Exhibit 1 Item 5-A
Planning Board Meeting
June 23, 2025

ALAMEDA AQUATIC CENTER

800 ATLANTIC AVENUE ALAMEDA, CA 94501



CITY OF ALAMEDA RECREATION AND PARK DEPARTMENT

2226 SANTA CLARA AVENUE ALAMEDA, CA 94501


PROJECT NUMBER: 202407

PLANNING RESUBMITTAL 5
JUNE 9, 2025

| | REVISION | | |
|---------------------------------|----------|------|-------------|
| | NUMBER | DATE | DESCRIPTION |
| e s architecture + urban design | • | | |
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| urban design |) | | |
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| d PL & | PENNY (NAIL) PROPERTY LINE AND | H.R. H. H.B. | HAND RAIL HIGH HOSE BIBB | T.B. T.C. T.O.C. | TOWEL BAR TOP OF CURB TOP OF CONCRETE | AT ONCE REPORT TO THE PERFORMS ANY CONST | IE ARCHITECT ERRORS, INCONS RUCTION ACTIVITY KNOWING IT | PARE THE CONTRACT DOCUMENTS WIT ISTENCIES OR OMISSIONS DISCOVERE INVOLVES A RECOGNIZED ERROR, INCO TO THE ARCHITECT, THE CONTRACTO | D. IF THE CONTRACT ONSISTENCY OR OM |
|--|---|---------------------------|--|--------------------------------|---|--|--|---|--|
| <u>/</u> @ CL | ANGLE AT CENTERLINE | H.C. HDR. HDWD. | HOLLOW CORE HEADER HARDWOOD | T.D. TEL. TEMP. | TIE DOWN TELEPHONE TEMPERED | | SIBILITY FOR SUCH PERFORMAN | CE AND SHALL BEAR AN APPROPRIATE | |
| 4 | DIAMETER, ROUND PERPENDICULAR | HDWE. H.M. | HARDWARE HOLLOW METAL | TER. T. & G. THK. | TERRAZZO TONGUE AND GROOVE THICK | PROGRESS AND CONFO | | UCTION TO REMAIN, ALL CONDITIONS A | |
| # (E) (N) | POUND, NUMBER EXISTING NEW | HORIZ. HR. HT. | HORIZONTAL HOUR HEIGHT | THK. THR. T.O. | THICK THRESHOLD TOP OF | OF WORK. | TAKE PRECEDENCE OVER SCALE | D MEASUREMENTS. WHERE DISCREPA | NOIES IN DIMENSIO |
| | | | INCIDE DIAMETER (DIMENOION) | T.O.B. T.O.C | TOP OF BENCH TOP OF CONCRETE | OCCUR THEY SHALL BE | REPORTED TO THE ARCHITECT | FOR RESOLUTION. | |
| A.B. ABV. A.C. | ANCHOR BOLT ABOVE ASPHALTIC CONCRETE | I.D. INSUL. INT. | INSIDE DIAMETER (DIMENSION) INSULATION INTERIOR | T.O.S. T.P.D. TRANSF. | TOP OF STRUCTURE TOILET PAPER DISPENSER TRANSFORMER | AND/OR LOCAL CODES, | LAWS, ORDINANCES, STATUTES | THE LATEST RULES AND REGULATIONS AND REGULATIONS. NOTHING IN THE D OR PERMITTING WORK CONTRARY TO | RAWINGS OR |
| ACC. VC | ACCESSIBLE AIR CONDITIONING | INTERM. | INTERMEDIATE | T.O.W. TYP. | TOP OF WALL TYPICAL | REGULATIONS, AND COL | | D TYPICAL DETAILS OF CONSTRUCTION | THE DRAWINGS D |
| ACOUS. A.D. ADJ. | ACOUSTICAL AREA DRAIN ADJUSTABLE, ADJACENT | JAN. JST. | JANITOR JOIST | | | ILLUSTRATE EVERY CON | IDITION; WORK NOT EXPRESSLY | DETAILED SHALL BE OF CONSTRUCTION SHALL BE REPORTED TO THE ARCHITE | ON SIMILAR TO PAR |
| A.F.F. AGGR. | ABOVE FINISH FLOOR AGGREGATE | J.H. JT. | JOIST HANGER JOINT | UNF. U.O.N. UR. | UNFINISHED UNLESS OTHERWISE NOTED URINAL | | | DARY DECLINATIONS, AND EXISTING GREEMED TO HAVE INSPECTED THE SITE A | |
| ALUM. ALT. A.P. | ALUMINUM ALTERNATE ACCESS PANEL | KIT. | KITCHEN | OK. | UNIVAL | TO ACTUAL GRADES, LE TO BE PERFORMED. | VELS, DIMENSIONS, AND DECLIN | IATIONS AND THE TRUE CONDITIONS UI | NDER WHICH THE V |
| APPROX. ARCH. | APPROXIMATE ARCHITECT | L.B. | LAG BOLT | V.T. VERT. | VINYL TILE VERTICAL | DIMENSIONS ARE TO BE | | RWISE NOTED. DO NOT SCALE THE DRA | |
| ASPH. | ASPHALT | LAM. LAV. | LAMINATE LAVATORY | VEST. V.I.F. | VESTIBULE VERIFY IN FIELD | | | SIONS ARE LACKING, NOTIFY THE ARCH ARE LOCATED BY THE DOOR DETAILS. | ITECT AT ONCE. IF I |
| BC BSMT. | BOTTOM OF CURB BASEMENT | LKR. LOC. | LOCKER LOCATION LONG | | | | | EFER TO BUILDING DATUM, UNLESS OTI LL EXISTING CONDITIONS BEFORE BIDD | |
| BTW. BD. | BETWEEN BOARD | LT. | LIGHT | W W. | WIDE WEST | 9. THE CONTRACTOR STIAL | LE VIGIT THE SHE AND VERIL I AL | LE EXISTING CONDITIONS BEI ORE BIDD | ing. |
| BITUM. BLDG. BLK. | BITUMINOUS BUILDING BLOCK | MACH. | MACHINE | W/ W.C. | WITH WATER CLOSET | | | | |
| BLKG. BLW. | BLOCKING BELOW | MAX. M.B. M.C. | MAXIMUM MACHINE BOLT MEDICINE CABINET | W.I. WD. W.F. | WROUGHT IRON WOOD WIDE FLANGE | 0) (1 4 1 0 1 0 1 | FOEND | | |
| 3M. 3.O. 3.S. | BEAM BOTTOM OF BOTTOM OF SILL | MECH. MEMB. | MECHANICAL MEMBRANE | W.O. W/O | WHERE OCCURS WITHOUT | SYMBOLS I | LEGEND | | |
| 3.R. 3.O.C. | BOTTOM OR RISER BOTTOM OF CURB | MFR. MH. MIN. | MANUFACTURER MANHOLE MINIMUM | WP. WP. TYPE 1 (ETC.) WR | WATER RESISTANT | | | \downarrow | |
| 3.O.W. 3OT. 3.U.R. | BOTTOM OF WALL BOTTOM BUILT-UP ROOFING | MIR. MISC. | MIRROR MISCELLANEOUS | W.S. WSCT. | WOOD SCREW WAINSCOT | (#) | | | WORK POINT |
| | | M.O. MTD. MTL. | MASONRY OPENING MOUNTED METAL | WT. W.W.F. | WEIGHT WELDED WIRE FABRIC | # | GRID LINE REFERENCE | \\\\ _ # | WINDOWENDS |
| CAB. C.B. CEM. | CABINET CATCH BASIN CEMENT | MTP. MTL. | METAL TOILET PARTITION METAL SIDING | | | | | W - # | WINDOW TYPE LOUVER TYPE |
| CEM. CEM. PLAS. CER. | CEMENT CEMENT PLASTER CERAMIC | MUL. | MULLION | | | | | P - # | PAINT TYPE |
| C.I. C.J. | CAST IRON CONTROL JOINT | (N) N. | NEW NORTH | | | 1 TITLE SCALE | DRAWING TITLE | \frown | TEMPERED AND |
| CLG. CLKG. CH. | CEILING CAULKING COAT HOOK | N.I.C. NO. | NOT IN CONTRACT NUMBER | | | | | T | LAMINATED GLA |
| C.J. CLO. | CONSTRUCTION JOINT CLOSET | NOM. N.T.S. | NOMINAL NOT TO SCALE | | | 1 TITLE SCALE | PARTITION SCHEDULE DRAWING TITLE | 101 | DOOR NUMBER |
| C.O. CLR. COL. | CLEAN_OUT CLEAR COLUMN | O.A. | OVERALL | | | JUALE | - ··· | | 1 HR ASSEMBLY |
| COMP. CONC. | COMPOSITION CONCRETE | OBSC. O.C. OD | OBSCURE ON CENTER OVERFLOW DRAIN | | | 1— VIEW | I | | 2 HR ASSEMBLY |
| C.M.U. CONN. CONST. | CONCRETE MASONRY UNIT CONNECTION CONSTRUCTION | O.D. O.F.C.I. | OUTSIDE DIAMETER OWNER FURNISHED | | | 4 SHEET 2 | INTERIOR ELEVATION | | |
| CONT. CORR. | CONTINUOUS CORRIDOR | OFF. O.H. | CONTRACTOR INSTALLED OFFICE OVERHEAD | | | 3 | | TYPE | |
| C.T. CTSK. CNTR. | CERAMIC TILE COUNTERSINK COUNTER | O.H. OPNG. OPP. | OPENING OPPOSITE | | | | | P1 | PARTITION TYPE |
| CPT. CTR. CW. | CARPET CENTER CURTAIN WALL | PART'N. | PARTITION | | | 1 VIEW | I | | |
| | | P & SH. P.B. P.D. | POLE AND SHELF PARTICLE BOARD PLANTER DRAIN | | | SHEET | EXTERIOR ELEVATION | # > | KEYNOTE |
| D. DBL. D.C. TYPE 1 (ETC.) | DEEP DOUBLE DECK COATING TYPE 1 (ETC.) | PLUMB. PRCST. | PLUMBING PRECAST | | | VIEW | , | | KETNOTE |
| D.D DEMO. | DECK DRAIN DEMOLISH DEPARTMENT | PREFAB. PTDF PL. | PRE-FABRICATED PRESSURE TREATED DOUGLA PLATE | S FIR | | NO. | , | ROOM − ROOM NAME | |
| DEPT. DET. D.F. | DETAIL DOUGLAS FIR, DRINKING FOUNTAIN | P. LAM. PLAS. | PLASTIC LAMINATE PLASTER | | | SHEET | SECTION KEY | 123 → ROOM # | ROOM KEY |
| DIAM. DIAG. DIM. | DIAMETER DIAGONAL DIMENSION | PLYWD. PTP PR. | PLYWOOD PLASTIC TOILET PARTITION PAIR | | | | | | |
| DIIVI. DISP. DN. | DISPENSER DOWN | PT. PTD | POINT, POINT PAINTED | | | NO. | DETAIL SECTION KEY | 1 | DRAWING REVIS |
| D.O. DR. DWG. | DOOR OPENING DOOR DRAWING | PTN, PART. P.T.R. | PARTITION PAPER TOWEL RECPTACLE | | | SHEET | DETAIL SECTION RET | | |
| D.W.P. DWR. | DESIGN WORKING POINT DRAWER | Q.T. | QUARRY TILE | | | | | _ | |
| D.S. D.S.P. | DAVIT SOCKET DRY STANDPIPE | r. | RADIUS | | | NO. | ! DETAIL PLAN KEY | MATCHLINE 1 / A101 | MATCHLINE |
| E. EA. | EAST EACH | R. (R) R.D. | RISER REMOVE ROOF DRAIN | | | SHEET | j | | |
| E.B. E.F. | EXPANSION BOLT EXHAUST FAN | REF. REFER. | REFERENCE REFRIGERATOR | | | | | PLAN TRUE NORTH | |
| E.F.S. E.I.F.S. E.J. | EXTER. FINISH SYSTEM EXTER. INSUL. & FIN. SYST. EXPANSION JOINT | RGTR. REINF. REQ'D | REGISTER REINFORCED | | | LEVEL_ | ELEVATION TARGET | | NORTH ARROW |
| ELECT. EL. | ELECTRICAL ELEVATION | | REQUIRED | | | | | | |
| ELEV. EMER. ENAM. | ELEVATOR EMERGENCY ENAMELED | RESIL. RET. | RESILIENT RETAINING | | | +21' - 0" | SPOT ELEVATION | 0' 10' 20' 40' | GRAPHIC SCALE |
| ENCL. E.P. | ENCLOSURE ELECTRICAL PANEL | REV. RM. R.O. | REVISION, REVISED ROOM ROUGH OPENING | | | Ψ | | SCALE: 1" = 20' - 0" | |
| EQ. EQUIP. | EQUAL EQUIPMENT EACH WAY | RDWD. R.W.L. | REDWOOD RAIN WATER LEADER | | | | | | |
| E.W. E.W.C. (E) | ELECTRIC WATER COOLER EXISTING | R.B. | RUBBER BASE | | | | | | |
| EXPO. EXP. | EXPOSED EXPANSION | S. S.C. | SOUTH SOLID CORE | | | | | | |
| EXT. | EXTERIOR | S.C.D. SCH. S.D. | SEE CIVIL DRAWINGS SCHEDULE SOAP DISPENSER | | | | | | |
| F.B. FC | RE ALARM DOTBOARD | SECT. S.E.D. | SECTION SEE ELECTRICAL DRAWINGS | | | | | | |
| FDN. FO | LOOR DRAIN DUNDATION RE EXTINGUISHER | SH. S.H.V.C. | SHELF SURFACE MOUNTED HOSE VALVE CABINET | | | | | | |
| F.E.C. FI F.H. FI | RE EXTINGUISHER CABINET RE HYDRANT | SHR. SHT. | SHOWER SHEET | | | | | | |
| F.H.C. FI FIN. FI | NISH FLOOR RE HOSE CABINET NISH | SIM. S.L.D. S.M. | SIMILAR SEE LANDSCAPE DRAWINGS SHEET METAL | | | | | | |
| FIXT. FIXT. FIX | XTURE LOOR | S.M.D. S.N.D. | SEE MECH. DRAWINGS SANITARY NAPKIN DISPENSER | | | | | | |
| FLUOR. FL | LASHING LUORESCENT ACE OF | S.N.R. SPEC. S.P.R. | SANITARY NAPKIN RECEPTACL SPECIFICATION SINGLE-PLY ROOFING | .E | | | | | |
| F.O.C. F <i>F</i> F.O.F. F <i>F</i> | ACE OF CONCRETE ACE OF FINISH | SQ. | SQUARE SQUARE FOOT, SQUARE FEET | | | | | | |
| FPRF. FI FRMG. FF | ACE OF STUDS REPROOF RAMING | S.S. S.S.D. S. SK. | STAINLESS STEEL SEE STRUCTURAL DRAWINGS SERVICE SINK | | | | | | |
| F.S.R. FI F.S. FL | RE SPRINKLER RISER LOOR SINK | STA. STD, | STATION STANDARD | | | | | | |
| FTG. FC | OOT, FEET OOTING DUNDATION | STL. STOR. | STEEL STORAGE | | | | | | |
| FURR. FL | JUNDATION JRRING JTURE | STRUCT. SUSP. SAT | STRUCTURAL SUSPENDED SUSPENDED ACOUSTICAL TILE | <u>:</u> | | | | | |
| | AUGE ALVANIZED | S.V. SYM. | SHEET VINYL SYMMETRICAL | | | | | | |
| G.B. GI | ALVANIZED RAB BAR YPSUM WALL BOARD | | | | | | | | |
| G.I. G/ G.F.I. GI | ALVANIZED IRON ROUND FAULT INTERRUPTER | | | | | | | | |
| | LASS FIBER REINF. CONC. LASS | | | | | | | | |
| | ROUND | | | | | | | | |

PROJECT LOCATION

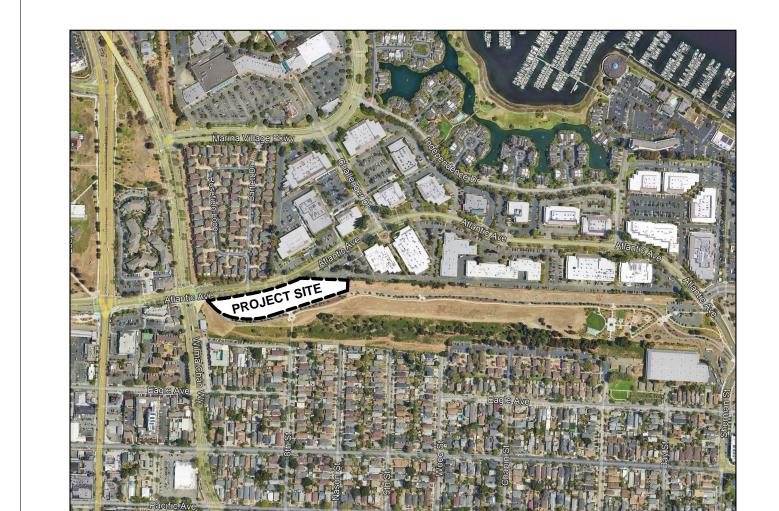

PROJECT DESCRIPTION

THE PROJECT SITE IS LOCATED AT THE WESTERN END OF JEAN SWEENEY OPEN SPACE PARK NEAR THE CROSSROADS OF WILMA CHAN WAY AND ATLANTIC AVENUE.

ALAMEDA AQUATICS CENTER IS A NEW ALL-ELECTRIC SWIM CENTER THAT INCLUDES A ONE-STORY BUILDING WITH SUPPORT SPACES FOR A 30M COMPETITIVE SWIMMING POOL, A SMALLER ACTIVITY POOL AND SPECTATOR SEATING AREAS OFF THE POOLS.

THE FACILITY IS AN L-SHAPED BUILDING, WITH A NORTH WING THAT CONTAINS POOL MECHANICAL EQUIPMENT, ELECTRICAL ROOM, LOCKER ROOMS, AND LIFEGUARD ROOM AND A SOUTH WING THAT CONTAINS ADMINSTRATION OFFICES, AND MULTIPURPOSE ROOM. THE TWO WINGS ARE CONNECTED BY A COVERED BREEZEWAY THAT FUNCTIONS AS THE FACILITY'S PRIMARY ENTRY.

THE PERIMETER OF THE POOL DECK IS SURROUNDED BY FENCING WHICH WILL BE A MINIMUM OF 10'H FOR SECURITY AND WILL BE RAISED TO 15' ALONG THE WEST TO PROVIDE NEEDED WIND PROTECTION FOR THE POOLS WITH A COMBINATION OF SOLID AND SEMI-POROUS FENCING.

THE PROJECT'S LANDSCAPE IMPROVEMENTS INCLUDE AN ENTRY PLAZA, BICYCLE PARKING, AND PARKING LOT.

els architecture+ urban design

ALAMEDA AQUATIC CENTER

800 ATLANTIC AVENUE

ALAMEDA, CA 94501

PROJECT NUMBER:

202407

PROJECT:

CITY OF ALAMEDA RECREATION AND PARK DEPARTMENT 2226 SANTA CLARA AVENUE ALAMEDA, CA 94501

PROJECT TEAM:

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LANDSCAPE ARCHITECT: SWA

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P: 415.332.5100

STRUCTURAL ENGINEER:
FORELL/ELSESSER ENGINEERS, INC.
160 Pine Street, 6th Floor
San Francisco, CA 94111
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MEP / FIRE PROTECTION:
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San Francisco, CA 94111
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AQUATICS:
AQUATICS DESIGN GROUP
2226 Faraday Avenue
Carlsbad, CA 92008
P: 760.438.8400

SPECIFICATIONS: SPECIFICATIONS WEST 1975 E. Buck Ridge Place Tucson, AZ 85737 P: 800.646.3820

SHEET INDEX

| | ADMINISTRAT | IVF |
|------------------|---------------|---|
| WORK POINT | A000 | COVER SHEET - PS |
| WORKE OHE | A001 | INDEX SHEET & GENERAL NOTES - PS |
| | A002 | CODE ANALYSIS & PLUMBING FIXTURE CALCULATIONS |
| | A003 | EGRESS DIAGRAM |
| WINDOW TYPE | A030 | RENDERINGS |
| LOUVED TYPE | A031 | RENDERINGS EXTERIOR MATERIALS |
| LOUVER TYPE | A035 A040 | MASSING AXONOMETRIC |
| PAINT TYPE | 710 10 | MINIOSINO / MONOME THIS |
| | CIVIL | |
| TEMPERED AND/OR | C1.0 | EXISTING CONDITIONS |
| LAMINATED GLASS | C2.0 | DEMOLITION PLAN |
| | C3.0 | HORIZONTAL CONTROL PLAN |
| D000 NUMBER | C4.0 | GRADING PLAN UTILITY PLAN |
| DOOR NUMBER | C5.0 C6.0 | STORMWATER MANAGEMENT PLAN |
| | C7.0 | FIRE ACCESS PLAN |
| | C 110 | |
| 1 HR ASSEMBLY | LANDSCAPE | |
| 2 HR ASSEMBLY | L0.00 | EXISTING CONDITIONS |
| 2111(7(00E))(BE1 | L0.01 | ILLUSTRATIVE PLAN |
| | L1.01 | LAYOUT PLAN |
| | L2.0 L4.01 | PEDESTRIAN AND BICYCLE ACCESS PLAN PLANTING PLAN |
| | L4.01A | TREE PLAN |
| | L4.02 | PLANT LIST & IMAGES |
| PARTITION TYPE | L5.00 | PAVING DETAILS |
| | L5.02 | BIKE RACK & LOCKER DETAILS |
| | | |
| | ARCHITECTUR | |
| | A100 | SITE PLAN - DEMOLITION |
| KEYNOTE | A101 A102 | OVERALL SITE PLAN SITE PLAN |
| | A110 | SITE SECTIONS |
| | A120 | SITE ELEVATIONS & ENLARGED PLANS- TRASH ENCLOSURE |
| | A121 | SITE ELEVATIONS - PERIMETER FENCING |
| ROOM KEY | A201 | FLOOR PLAN - BUILDINGS |
| NOOM NET | A202 | FLOOR PLAN - POOL ENCLOSURE |
| | A231 | ROOF PLAN - BUILDINGS |
| | A301 A311 | EXTERIOR ELEVATIONS BUILDING SECTIONS |
| | A601 | REFLECTED CEILING PLAN - BUILDINGS |
| DRAWING REVISION | A801 | EXTERIOR STOREFRONT SCHEDULE |
| | | |
| | ELECTRICAL | |
| | E001 | LEGEND, SYMBOLS, GENERAL NOTES & DRAWING LIST |
| | E101 | SITE PLAN - POWER |
| | E102 E103 | SITE PLAN – POWER SITE LIGHTING PLAN - PHOTOMETRIC CALCULATIONS |
| MATCHLINE | E401 | SECTIONS & ENLARGED PLANS |
| | E501 | SINGLE LINE DIAGRAM |
| | E601 | LIGHTING FIXTURE SCHEDULE |
| | E704 | DETAILS (FOR REFERENCE) |
| | | |
| | | |
| NORTH ARROW | | |
| | | |
| | | |
| ODADIJIO ODALE | | |
| GRAPHIC SCALE | | |

REVISION

NUMBER DATE DESCRIPTION

PLANNING RESUBMITTAL 5

JUNE 9, 2025

NOT FOR CONSTRUCTION

HEET TITLE:

INDEX SHEET & GENERAL NOTES - PS

SHEET NUMBER:

A001

CODE ANALYSIS

APPLICABLE CODES:

California Code of Regulations, Title 24, Published by the California Building Standards Commission:

Part 1, "2022 California Administrative Code" (CAC) Part 2, "2022 California Building Code" (CBC) Part 3, "2022 California Electrical Code" (CEC)

Part 4, "2022 California Mechanical Code" (CMC)

Part 5, "2022 California Plumbing Code" (CPC) Part 6, "2022 California Energy Code" (CEC) Part 9, "2022 California Fire Code" (CFC)

Part 11, "2022 California Green Building Standards Code" Part 12, "2022 California Reference Standards Code"

CBC SUMMARY:

CHAPTER 3: OCCUPANCY CLASSIFICATION AND USE

A-5 Outdoor Swimming Pool with Spectator Seating A-3 Multipurpose Room

B Offices S-2 Low Hazard Storage

City of Alameda Municipal Codes

CHAPTER 5: GENERAL BUILDING HEIGHTS AND AREAS

504: Building Height and Number of Stories Building Height: The vertical distance from grade plane to the average height of the highest roof surface.

Grade Plane: A reference plane representing the average of finished ground level adjoining the building at exterior walls. Where the finished ground level slopes away from the exterior walls, the reference plane shall be established by the lowest points within the area between the building and the lot line or, where the lot line is more than 6 feet (1829 mm) from the building, between the building and a point 6 feet (1829 mm) from the building.

Stories: 1 Max Building Height*: 20'-4"

*See exterior elevations A301 for location of measurement from established grade plane

506: Building Area in Square Feet:

The area included within surrounding exterior walls, or exterior walls and fire walls, exclusive of vent shafts and courts. Areas of the building not provided with surrounding walls shall be included in the building area if such areas are included within the horizontal projection of the roof or floor above.

| Total Building Area: | 6,490.65 |
|-------------------------|----------|
| Covered Roof Area: | 750.58 |
| Enclosed Building Area: | 5,740.07 |
| | |

Section 508.3 Non-separated occupancies:

Different occupancies are not required to be separated as long as building area and height are based on the requirements of the most restrictive occupancy. The most restrictive occupancy is A-3, therefore if the building complies with code allowances for A-3 occupancy we can consider the building to be a nonseparated A-3 occupancy.

| Construction | Most Restrictive | Area (SF) | Height (Stories / Feet) |
|--------------|------------------|-----------------|-------------------------|
| Type | Occupancy | Per Table 506.2 | |
| VB | A-3 | 24,000 sf (S1) | 1 / 60' |

ENCLOSED BUILDING AREA

COVERED ROOF AREA

FLOOR PLAN - BUILDING AREA

1/16" = 1'-0"

Table assumes building is fully sprinklered.

CHAPTER 6: TYPES OF CONSTRUCTION

Fire resistance rating of building elements in hours

| Building Element | Construction Type VB |
|--|----------------------|
| Primary structural frame | 0 |
| Bearing wall - exterior | 0 |
| Bearing wall - interior | 0 |
| Non-bearing walls - exterior | 0 |
| Non-bearing walls - interior | 0 |
| Floor construction and secondary members | 0 |
| Roof construction and secondary members | 0 |

CHAPTER 7: SMOKE AND PROTECTION FEATURES

Fire Resistance Rating For Exterior Walls Based on Fire Separation Distance Based on Table 705.5 for Construction Type VB Occupancy Groups A, B, S-2

| Fire separation distance = X feet | Rating (Hours) |
|-----------------------------------|----------------|
| x < 5 | 1 |
| 5 <u><</u> X < 10 | 1 |
| 10 <u><</u> X < 30 | 0 |
| X < 30 | 0 |

included in the fire area.

Chapter 5, therefore sprinkler system to be provided.

CHAPTER 7A: MATERIALS AND CONSTRUCTION METHODS FOR EXTERIOR WILDFIRE EXPOSURE Project is not located in a WUI (Wildland Urban Interface) Area as defined by 702a and this chapter does not apply. **CHAPTER 8: INTERIOR FINISHES**

Interior wall and ceiling finish requirements by occupancy Based on Table 803.13 for a sprinklered building rating class as defined by 803.1.2.

| Group | Interior exit stairways and ramps and exit passageways | Corridors and enclosure for exit access stairways and ramps | Rooms and enclosed spaces | | |
|-------|--|---|---------------------------|--|--|
| A-3 | В | В | С | | |

CHAPTER 9: FIRE PROTECTION AND LIFE SAFETY SYSTEM Fire Area: Fire area is defined as the floor area enclosed by exterior building walls. Horizontal projections of the roof or floor above shall be

Fire area does not exceed 12,000 SF. Sprinklers are not required by Chapter 9, but are required for our building area and construction per

CHAPTER 10: MEANS OF EGRESS

Means of egress is to be provided per the calculated occupant loads for the various occupancy groups per Table 1004.1.2. The number of exits provided are based on the calculated occupant loads per Tables 1006.3.1 and 1006.3.2(2) with 2 exits provided where there are more than 49 occupants, 3 exits for more than 500 occupants and 4 exits for more than 1,000 occupants. The egress component widths for the exterior areas such as the pool and pool deck will be calculated per CBC Sections 1005.3.1 and 1005.3.2 as unsprinklered areas.

CHAPTER 11B: ACCESSIBILITY TO PUBLIC BUILDINGS, ACCOMMODATIONS, COMMERCIAL BUILDINGS AND PUBLIC HOUSING The building is a public accommodation and is to be accessible per the requirements of CBC Chapter 11B.

Water slides, raised diving boards and diving platforms shall not be required to comply with these requirements or to be on an accessible route; an accessible route complying with Division 4 shall be provided to the ground- or floor-level entry points, where provided, of stairs, ladders or other means of reaching the raised elements or area

PLUMBING FIXTURE ANALYSIS

PLUMBING FIXTURE CALCULATION PER CBC SECTION 3116B.2--DEPT. OF PUBLIC HEALTH

PLUMBING FIXTURE OCCUPANT COUNT PER CBC SECTION 3116B.2 OCC. LOAD 7,448 SF ACTIVITY POOL 3,015 SF

PLUMBING FIXTURES REQUIRED PER CBC 3116B.2 & CBC 3117B OCCUPANCY: SWIMMING POOLS* (350 MALE, 350 FEMALE) OCCUPANTS: 699 WATER CLOSET URINAL BATHTUBS OR DRINKING

10,463 SF

LAVATORIES OTHER **FOUNTAINS** SHOWERS REQUIRED: 5 6 5 9 14 4

*per CBC Section 3116B.2 and 3117B.

ACTIVITY POOL

LAP POOL

THE PROJECT ALSO COMPLIES WITH THE CALIFORNIA PLUMBING CODE 422:

PLUMBING FIXTURE OCCUPANT COUNT PER CPC TABLE 4-1

| AREA | OCCUPANCY | AREA | LOAD FACTOR | OCCUPANT |
|---|----------------------------|--------------|-------------|----------|
| ASSEMBLY USE - CONFERENCE, DINING/DRINKIN | IG. LOUNGE (PORTABLE SEATI | NG/TABLE SPA | (CE) | |
| MULTI-PURPOSE ROOM | A-3 | 309 SF | | |
| | - | | | |
| ASSEMBLY USE - CONFERENCE, DINING/DRINKIN | IG, LOUNGE (PORTABLE SEATI | NG/TABLE SPA | (CE) | |
| LAWN | A-5 | 770 SF | 30 | |
| | | | | |
| ASSEMBLY USE - FIXED SEATS | | | | |
| SPECTATOR SEATING | A-5 | 263 SF | 50% SEATS | |
| SPECTATOR SEATING | A-5 | 283 SF | 50% SEATS | |
| SPECTATOR SEATING | A-5 | 177 SF | 50% SEATS | |
| | | | | • |
| EXERCISE (FITNESS) | | | | |

3,015 SF

7,448 SF

| | | | | 21 |
|---|---------------|---------------|--------------|------------|
| BUSINESS USE - OFFICE, SALES/SOLICITING, ADMINISTRATION | N, FOOD PROCE | SSING, COURTR | OOM, AMBULAT | ORY CLINIC |
| TICKETING | В | 194 SF | 150 | |
| MANAGER OFFICE | В | 129 SF | 150 | |
| AQUATICS DIRECTOR OFFICE | В | 159 SF | 150 | |
| LIFEGUARD / FIRST AID | В | 293 SF | 150 | : |

A-5

TOTAL OCCUPANTS

PLUMBING FIXTURES REQUIRED PER CPC TABLE 422.1

| OCCUPANCY: ASSEMBLY - A-3* | | | | OCCUPANTS: 403 | | | (202 MALE, 202 FEMALE) | | |
|----------------------------|-------|--------|--------|----------------|--------|-------------|------------------------|----------------|--|
| | WATER | CLOSET | URINAL | LAVAT | ORIES | BATHTUBS OR | DRINKING | OTHER | |
| | MALE | FEMALE | MALE | MALE | FEMALE | SHOWERS | FOUNTAINS | | |
| REQUIRED: | 3 | 6 | 2 | 2 | 4 | _ | 2 | 1 Service Sink | |

*Typical without fixed or permanent seating; arcades, places of worship, museums, libraries, lecture halls, gymnasiums (without spectator seating), indoor pools (without spectator seating)


PLUMBING FIXTURES PROVIDED

FIXTURE COUNTS EQUAL OR EXCEED CH. 31B REQUIREMENTS WHICH ARE MORE STRINGENT THAN CPC REQUIREMENTS

| | WATER CLOSET URINAL LAVATOR | | ORIES | BATHTUBS OR | DRINKING | SERVICE SINKS | | |
|-----------|-----------------------------|--------|-------|-------------|----------|---------------|-----------|---|
| | MALE | FEMALE | MALE | MALE | FEMALE | SHOWERS | FOUNTAINS | |
| PROVIDED: | 5 | 9 | 5 | 4 | 4 | 15 | 4 | 2 |

FIXTURES IN ALL-GENDER/GENDER NEUTRAL AND SINGLE-OCCUPANCY TOILET ROOMS ARE ASSIGNED

EQUALLY TO MEN AND WOMEN. FIXTURES IN THE SINGLE-OCCUPANCY OFFICE RESTROOM ARE EXCLUDED FROM THE COUNT, FOR THE PURPOSES OF THE CODE ANALYSIS.

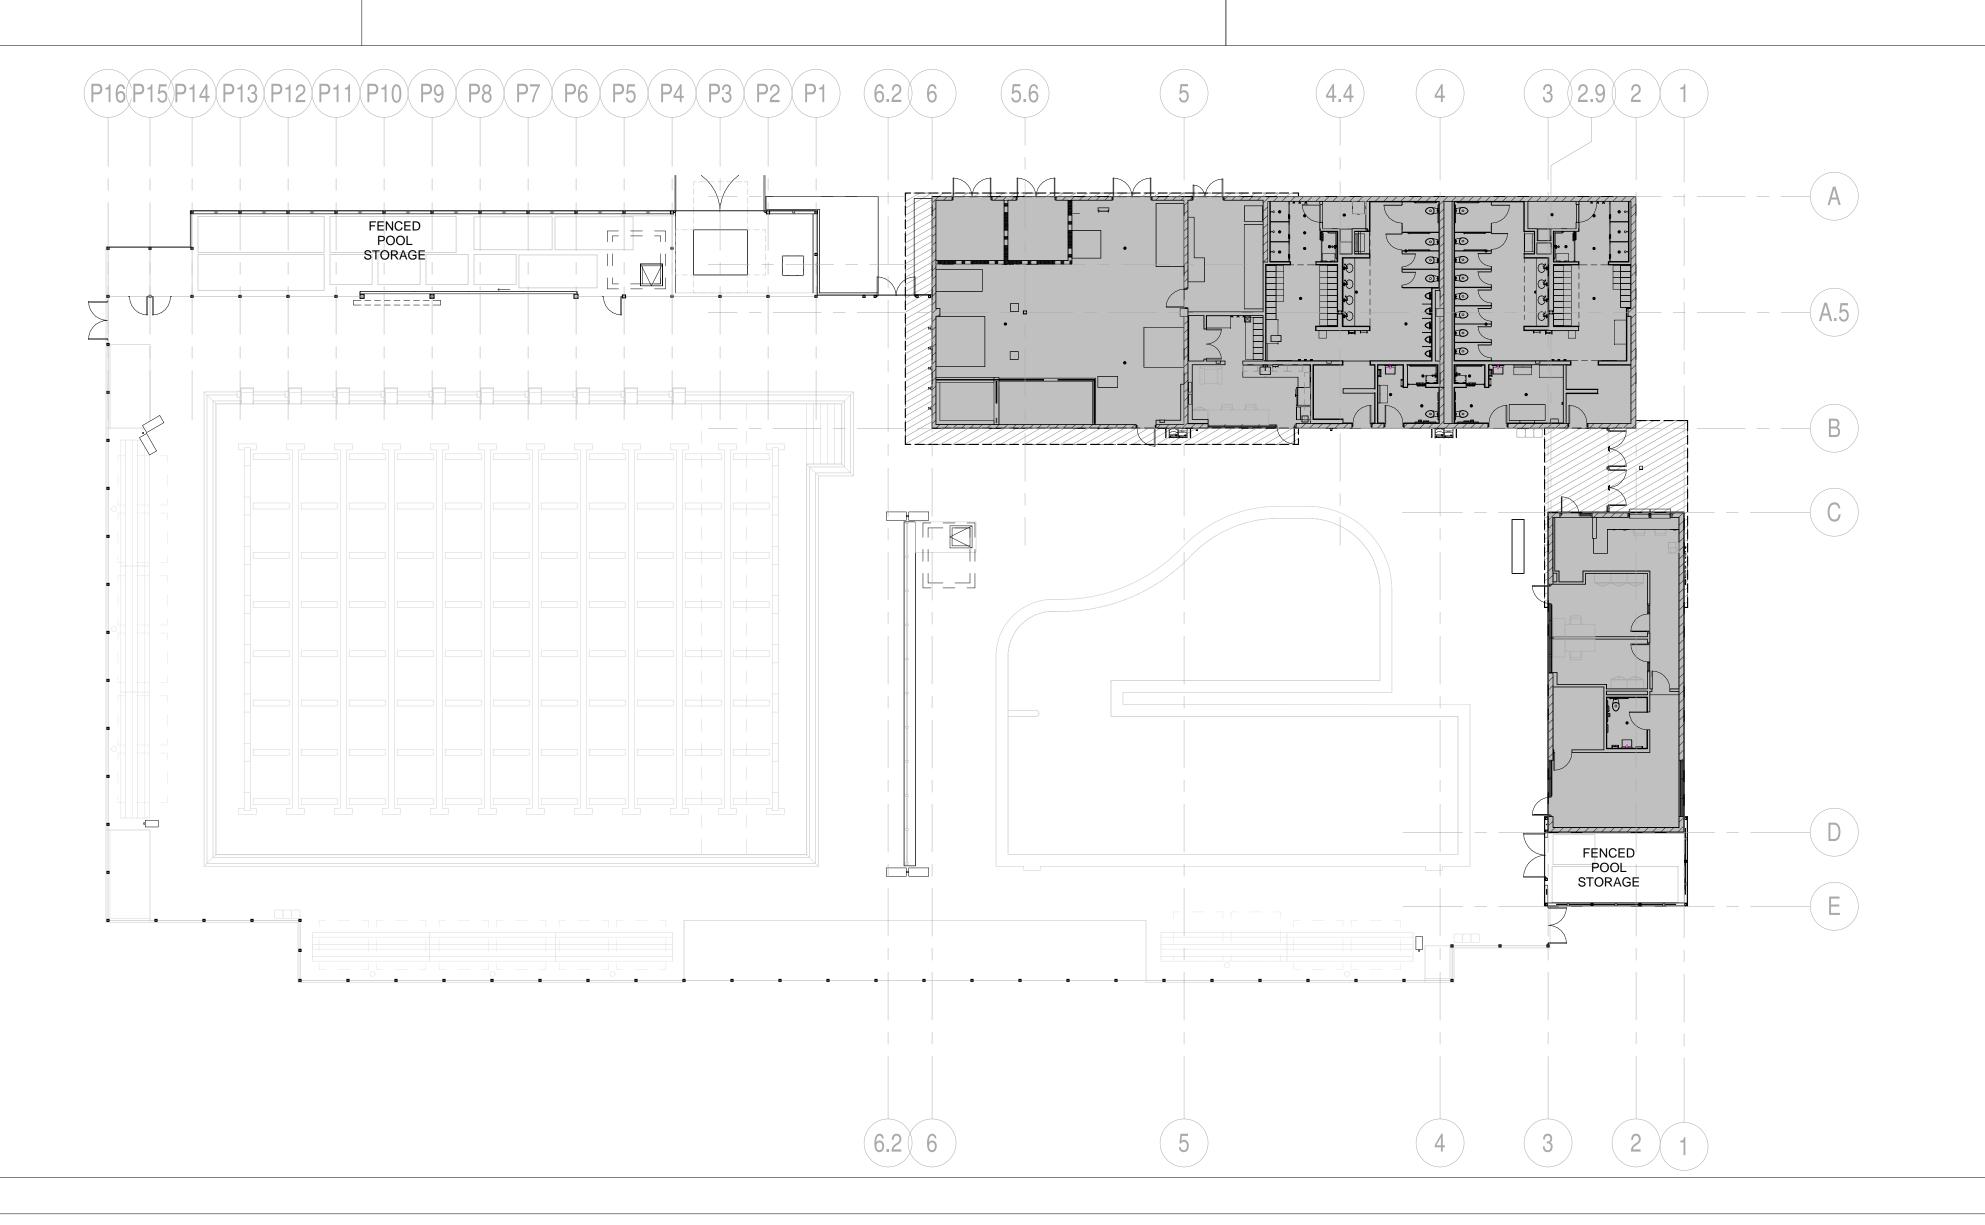

urban design

ALAMEDA AQUATIC CENTER

800 ATLANTIC AVENUE ALAMEDA, CA 94501

PROJECT NUMBER:

202407

PROJECT:

NO. OF

CITY OF ALAMEDA RECREATION AND PARK **DEPARTMENT**

2226 SANTA CLARA AVENUE ALAMEDA, CA 94501 PROJECT TEAM:

ARCHITECT: ELS ARCHITECTURE AND URBAN DESIGN 2040 Addison Street Berkeley, CA 94704 P: 510.549.2929

CIVIL ENGINEER: BKF ENGINEERS 1646 N. California Blvd, Suite 400 Walnut Creek, CA 94596

P: 925.940.2200 LANDSCAPE ARCHITECT: 2200 Bridgeway

Sausalito, CA 94965

P: 415.332.5100 STRUCTURAL ENGINEER: FORELL/ELSESSER ENGINEERS, INC. 160 Pine Street, 6th Floor San Francisco, CA 94111 P: 415.837.0700

MEP / FIRE PROTECTION: **GUTTMANN & BLAEVOET** 1620 Montgomery Street, Suite 230 San Francisco, CA 94111

P: 415.655.4000 **AQUATICS:** AQUATICS DESIGN GROUP 2226 Faraday Avenue

Carlsbad, CA 92008 P: 760.438.8400 SPECIFICATIONS: SPECIFICATIONS WEST 1975 E. Buck Ridge Place Tucson, AZ 85737

P: 800.646.3820

REVISION NUMBER DATE DESCRIPTION

PLANNING RESUBMITTAL 5


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JUNE 9, 2025

SHEET TITLE:

CODE ANALYSIS & PLUMBING FIXTURE CALCULATIONS SHEET NUMBER:

A002




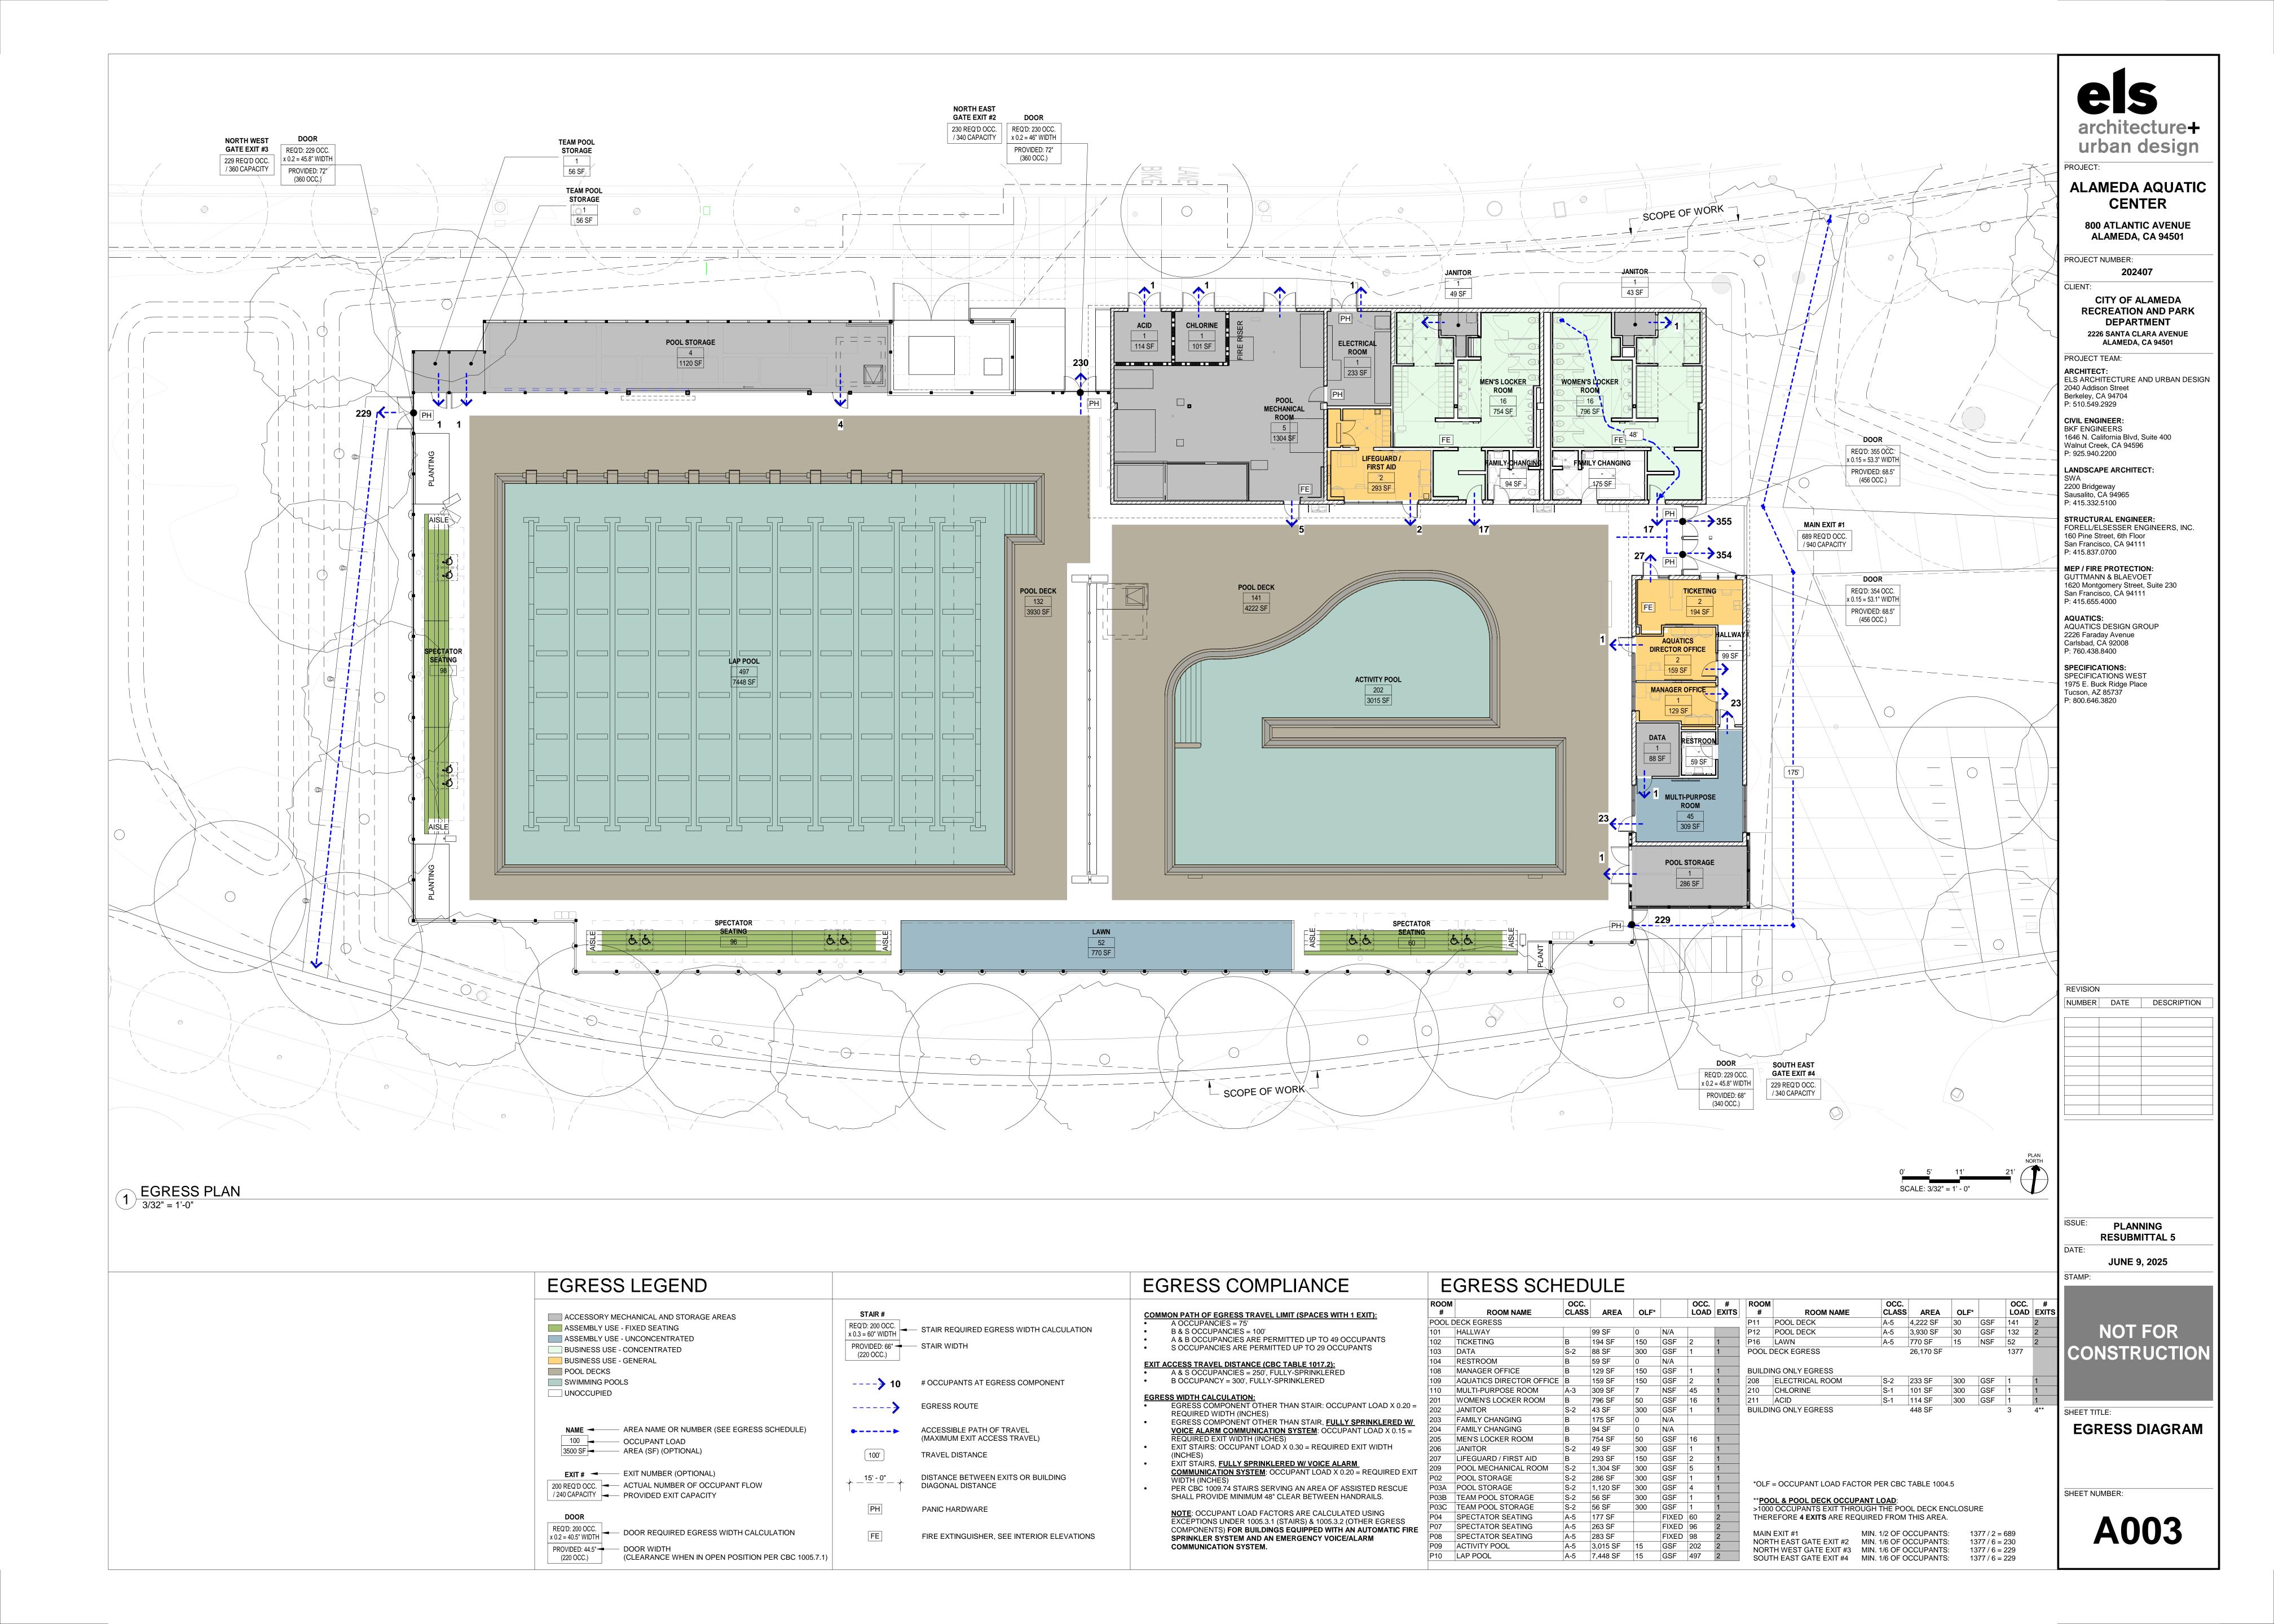

SOUTHEAST AERIAL FROM JEAN SWEENEY OPEN SPACE PARK



NORTHEAST AERIAL FROM ATLANTIC AVE.

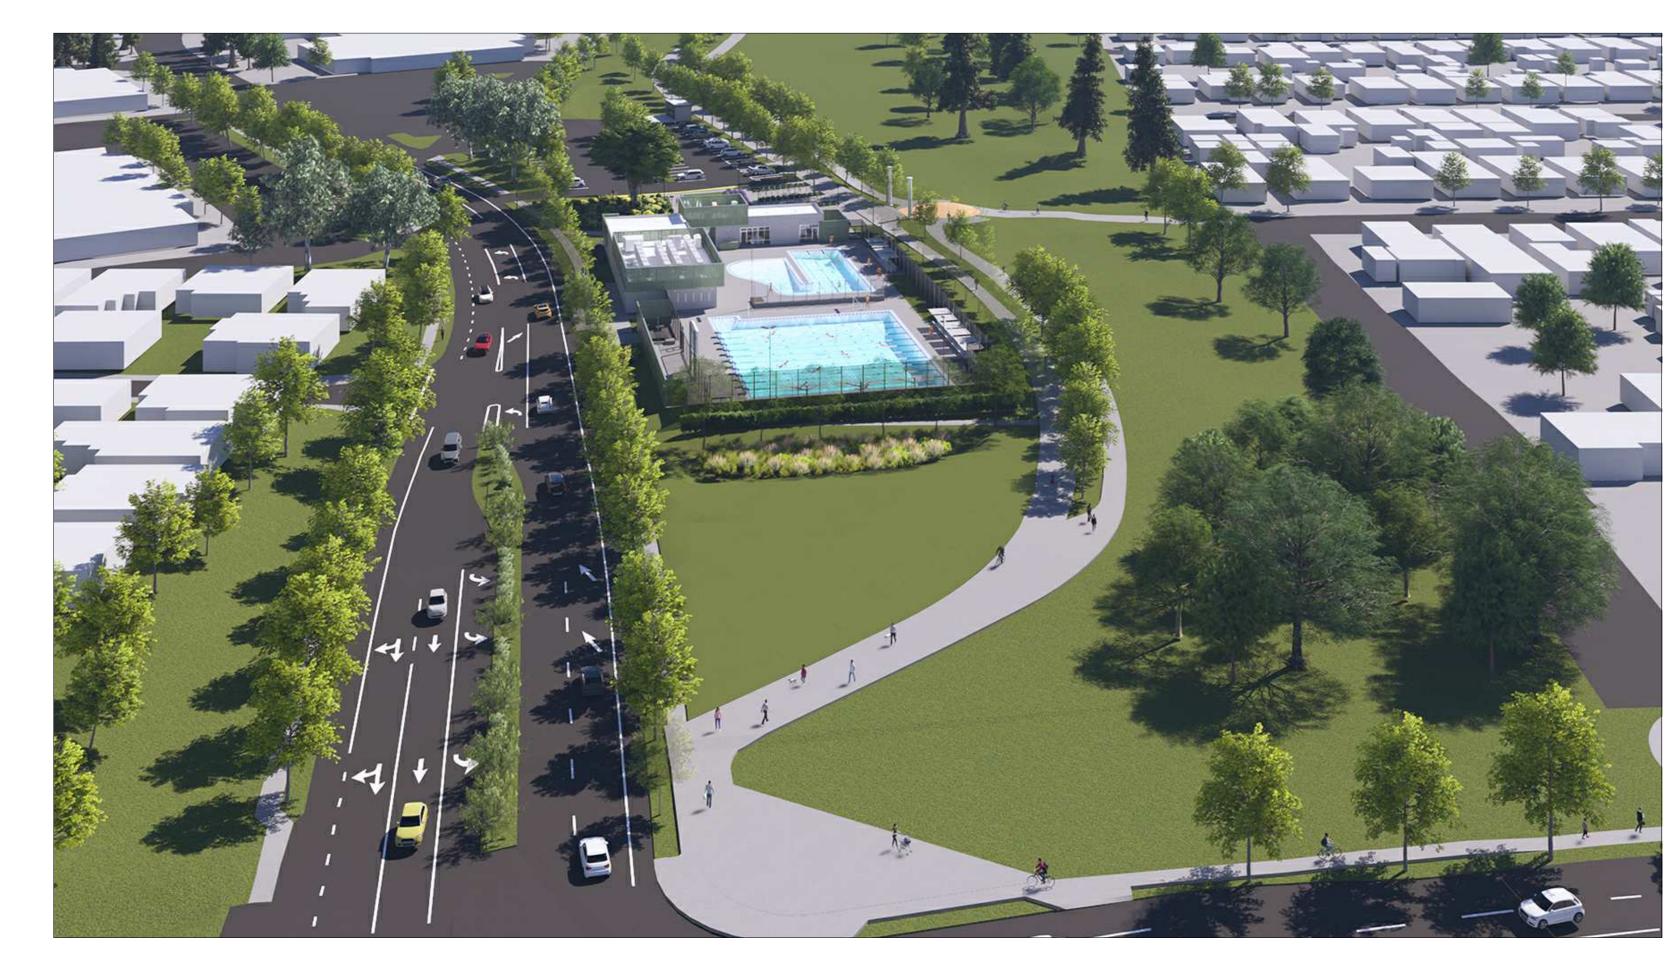

NORTHWEST AERIAL FROM INTERSECTION OF ATLANTIC AVE. & WILMA CHAN WAY

| el | 5 |
|---------|---------|
| archite | ecture+ |
| urban | design |

ALAMEDA AQUATIC CENTER

800 ATLANTIC AVENUE ALAMEDA, CA 94501

PROJECT NUMBER:

CITY OF ALAMEDA RECREATION AND PARK DEPARTMENT 2226 SANTA CLARA AVENUE ALAMEDA, CA 94501

PROJECT TEAM:

ARCHITECT: ELS ARCHITECTURE AND URBAN DESIGN 2040 Addison Street Berkeley, CA 94704 P: 510.549.2929

CIVIL ENGINEER:
BKF ENGINEERS
1646 N. California Blvd, Suite 400
Walnut Creek, CA 94596
P: 925.940.2200

LANDSCAPE ARCHITECT: 2200 Bridgeway Sausalito, CA 94965 P: 415.332.5100

STRUCTURAL ENGINEER:
FORELL/ELSESSER ENGINEERS, INC.
160 Pine Street, 6th Floor
San Francisco, CA 94111
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| REVISION | | | | | | |
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PLANNING RESUBMITTAL 5

JUNE 9, 2025

NOT FOR CONSTRUCTION

RENDERINGS



ENTRY VIEW FROM CROSS ALAMEDA TRAIL



ENTRY VIEW FROM ATLANTIC AVE. NEAR OAK TREE



COMPETITION POOL DECK VIEW

els architecture+ urban design

ALAMEDA AQUATIC CENTER

800 ATLANTIC AVENUE ALAMEDA, CA 94501

PROJECT NUMBER:

CITY OF ALAMEDA RECREATION AND PARK **DEPARTMENT** 2226 SANTA CLARA AVENUE ALAMEDA, CA 94501

PROJECT TEAM:

ARCHITECT:
ELS ARCHITECTURE AND URBAN DESIGN
2040 Addison Street
Berkeley, CA 94704
P: 510.549.2929

CIVIL ENGINEER:
BKF ENGINEERS
1646 N. California Blvd, Suite 400
Walnut Creek, CA 94596
P: 925.940.2200

LANDSCAPE ARCHITECT:

2200 Bridgeway Sausalito, CA 94965 P: 415.332.5100

STRUCTURAL ENGINEER:
FORELL/ELSESSER ENGINEERS, INC.
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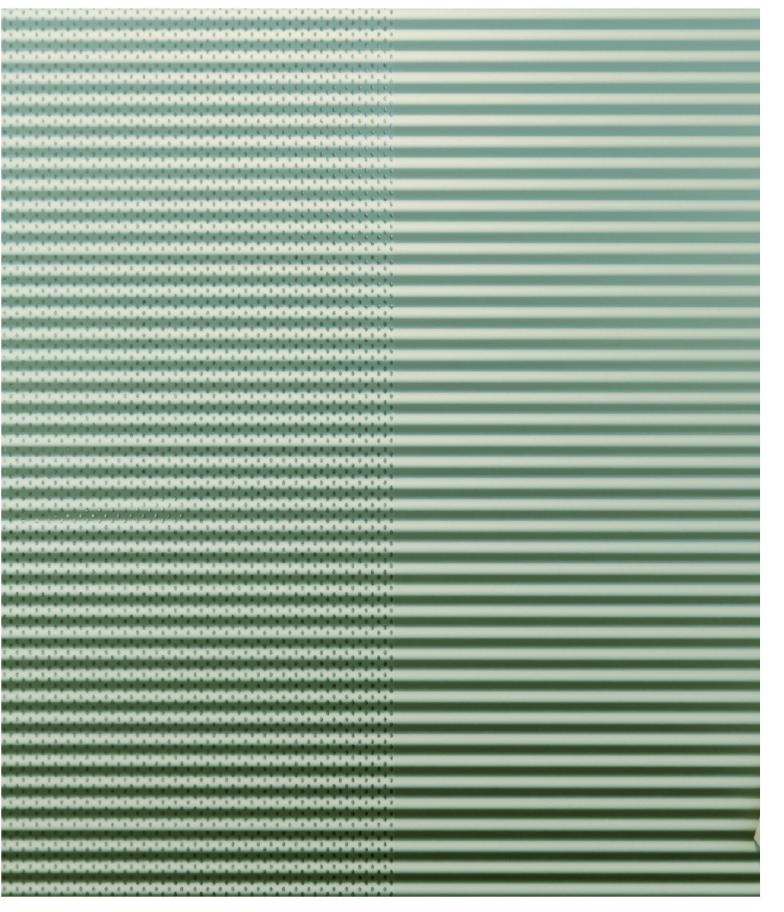
PLANNING RESUBMITTAL 5

JUNE 9, 2025

NOT FOR CONSTRUCTION

RENDERINGS

SHEET TITLE:







MORIN C37 IN PATINA GREEN PERFORATED CORRUGATED METAL PANEL

BASALITE

CMU BLOCK

ENTRY VIEW FROM CROSS ALAMEDA TRAIL




BLACK VINYL COATED **CHAIN LINK FENCE**




MORIN C37 IN PATINA GREEN SOLID

BLACK / GREEN WINDSCREEN MESH / VINYL SOLID WINDSCREEN

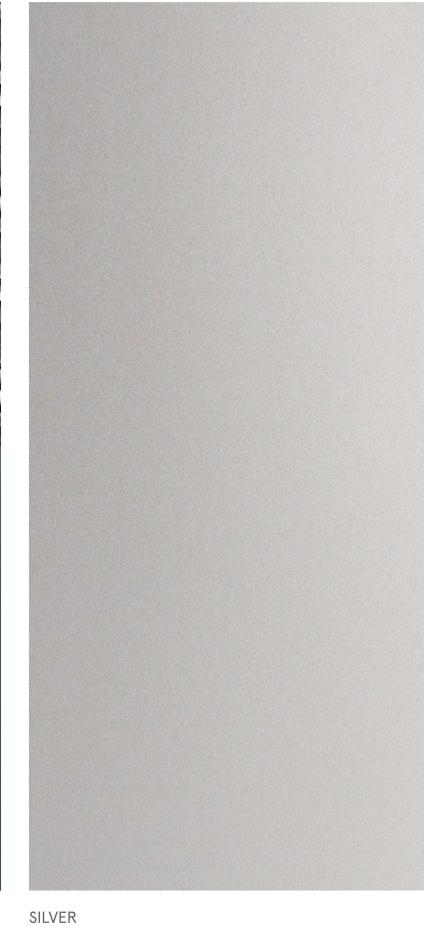

ANODIZED ALUMINUM DOOR & WINDOW FRAMES

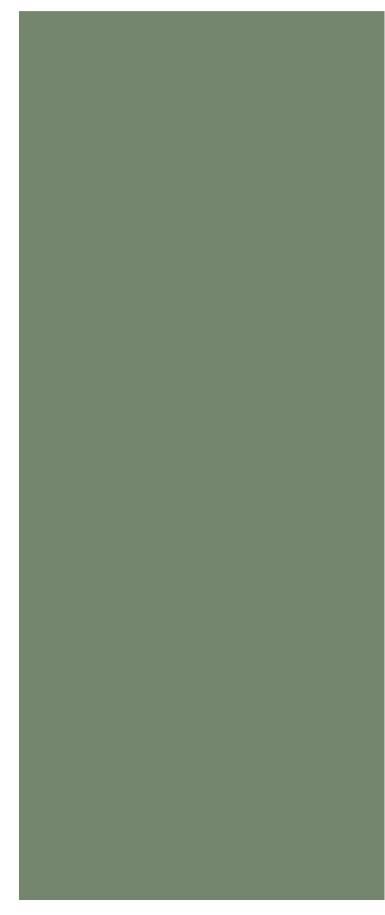

MORIN MX-6 IN PATINA GREEN FLAT METAL PANEL



ENTRY BREEZEWAY

els architecture+ urban design

ALAMEDA AQUATIC CENTER

800 ATLANTIC AVENUE ALAMEDA, CA 94501

PROJECT NUMBER:

CITY OF ALAMEDA RECREATION AND PARK **DEPARTMENT**

2226 SANTA CLARA AVENUE ALAMEDA, CA 94501 PROJECT TEAM:

ARCHITECT: ELS ARCHITECTURE AND URBAN DESIGN 2040 Addison Street Berkeley, CA 94704 P: 510.549.2929

CIVIL ENGINEER:
BKF ENGINEERS
1646 N. California Blvd, Suite 400
Walnut Creek, CA 94596
P: 925.940.2200

LANDSCAPE ARCHITECT:

2200 Bridgeway Sausalito, CA 94965 P: 415.332.5100

STRUCTURAL ENGINEER:
FORELL/ELSESSER ENGINEERS, INC.
160 Pine Street, 6th Floor
San Francisco, CA 94111
P: 415.837.0700

MEP / FIRE PROTECTION: GUTTMANN & BLAEVOET 1620 Montgomery Street, Suite 230 San Francisco, CA 94111 P: 415.655.4000

AQUATICS:
AQUATICS DESIGN GROUP
2226 Faraday Avenue
Carlsbad, CA 92008 P: 760.438.8400

SPECIFICATIONS: SPECIFICATIONS WEST 1975 E. Buck Ridge Place Tucson, AZ 85737 P: 800.646.3820

| REVISION | | |
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PLANNING RESUBMITTAL 5

JUNE 9, 2025


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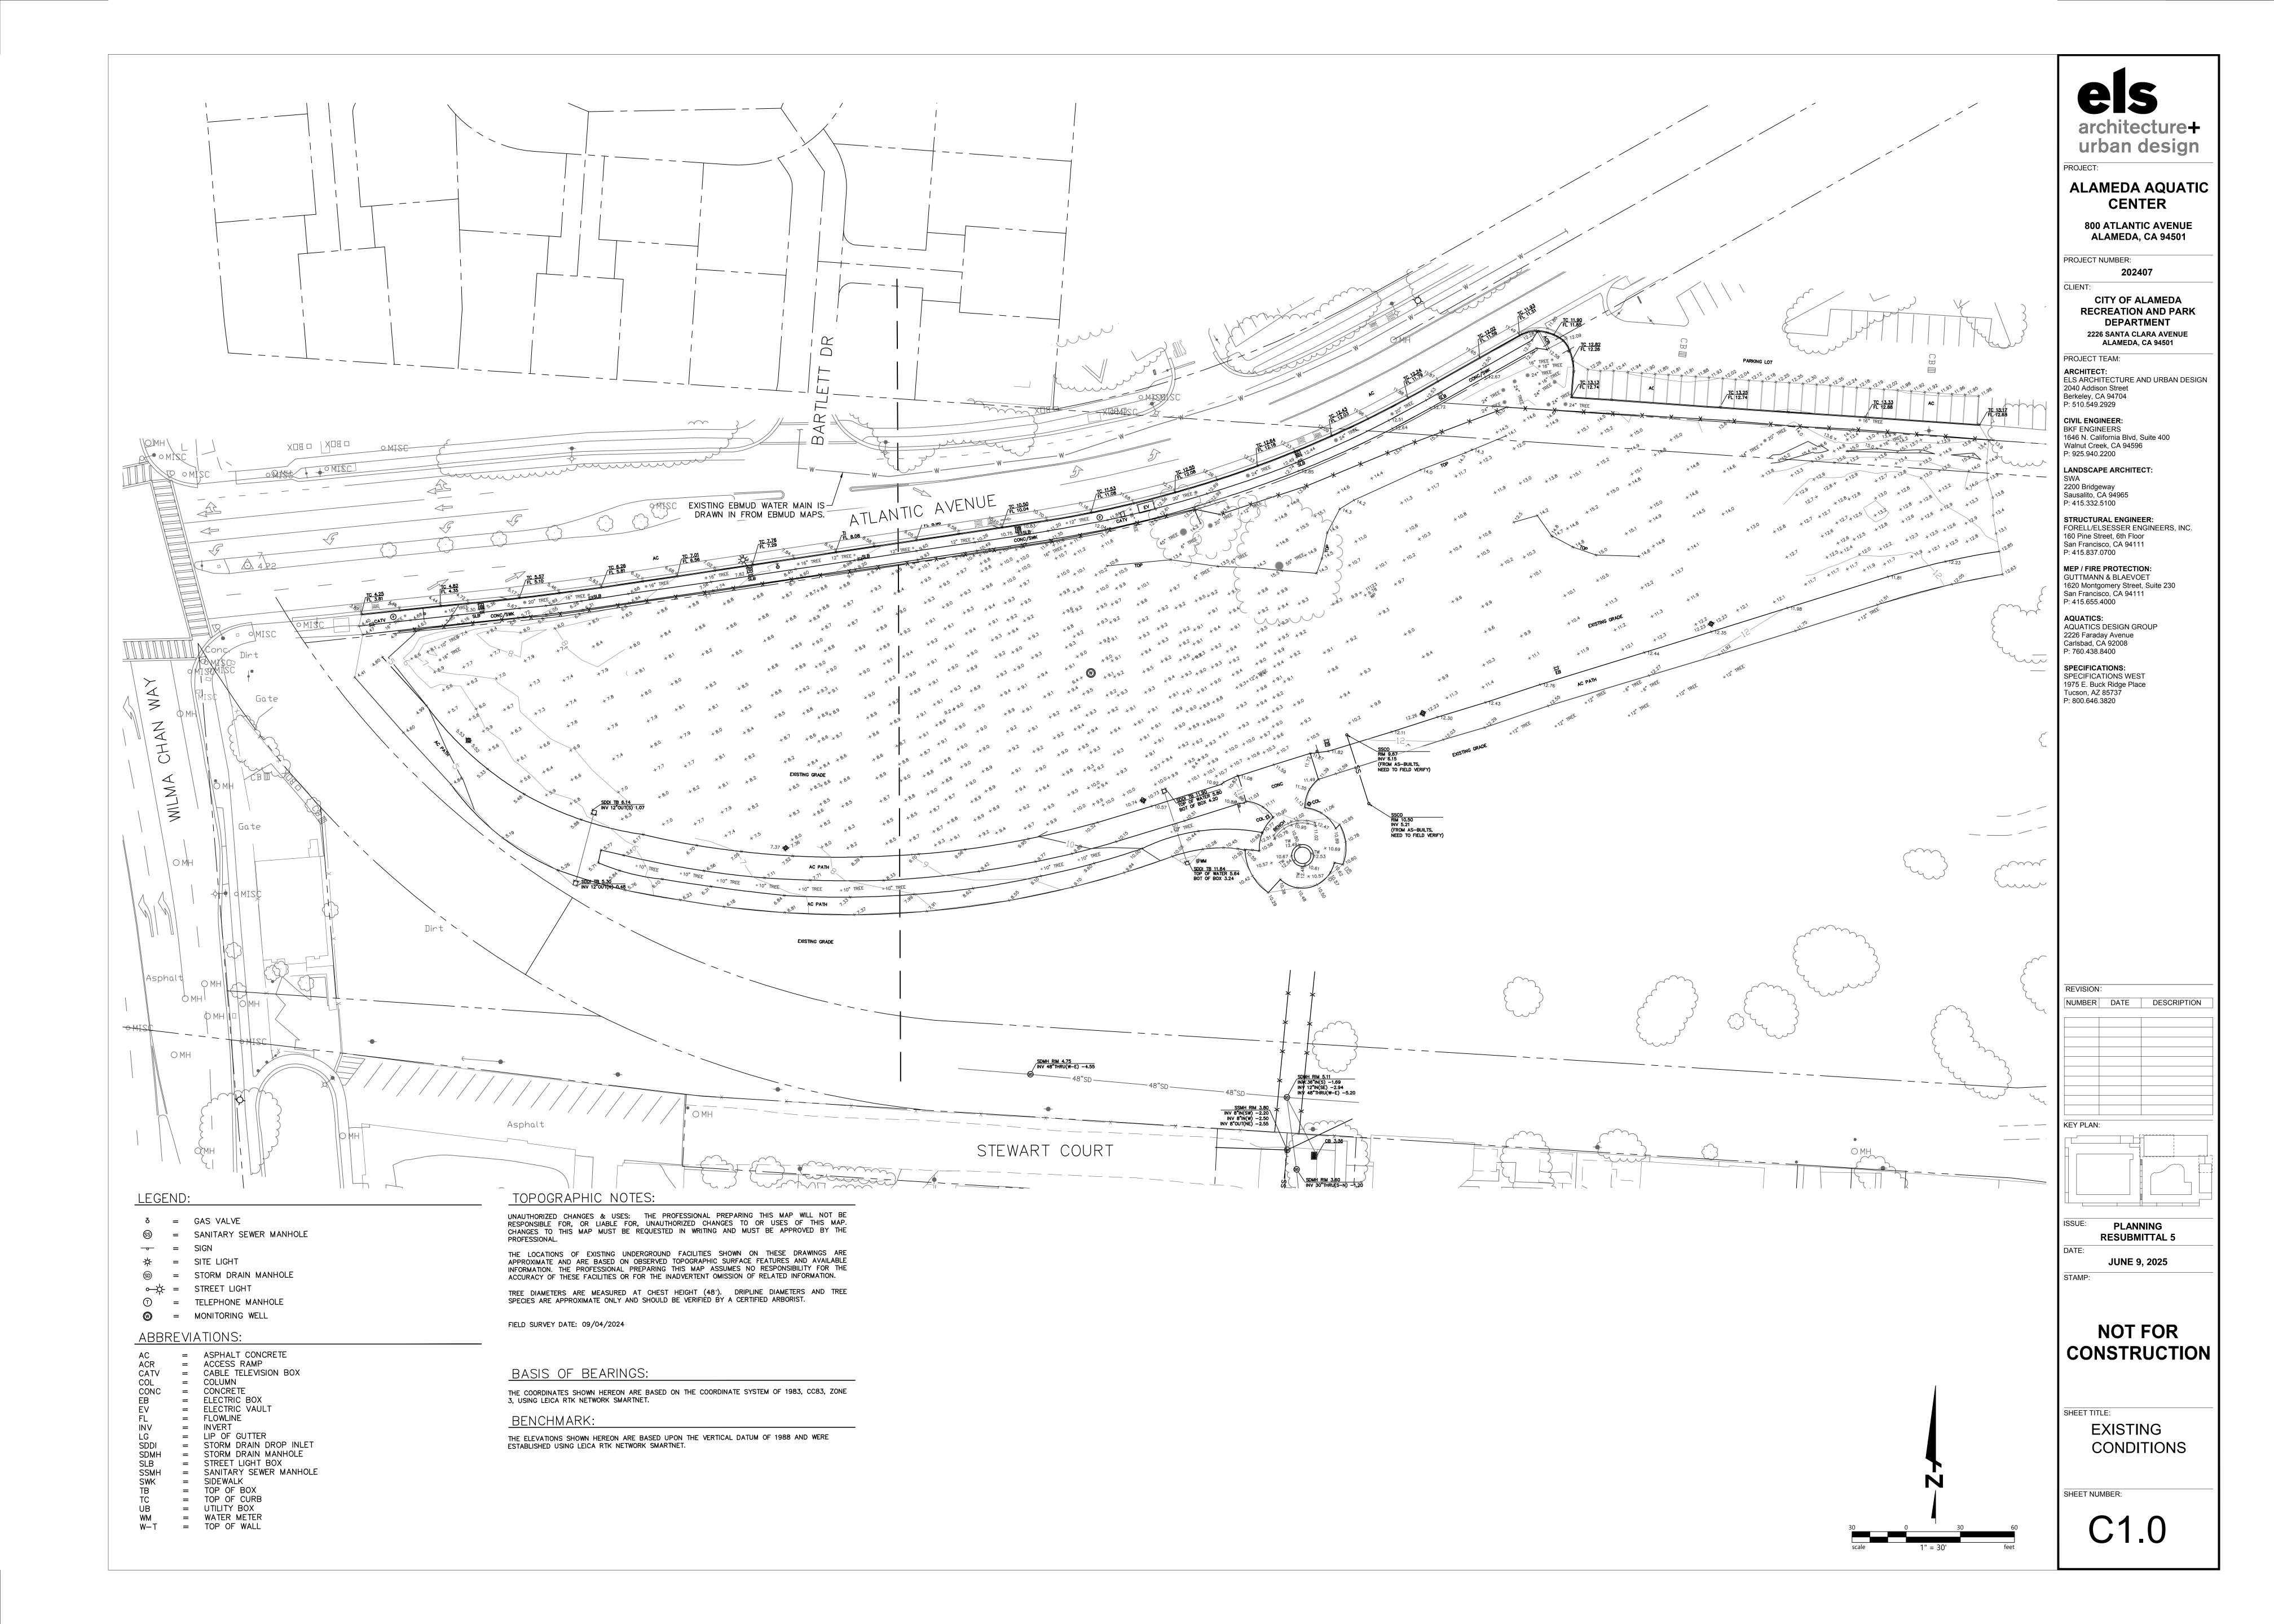
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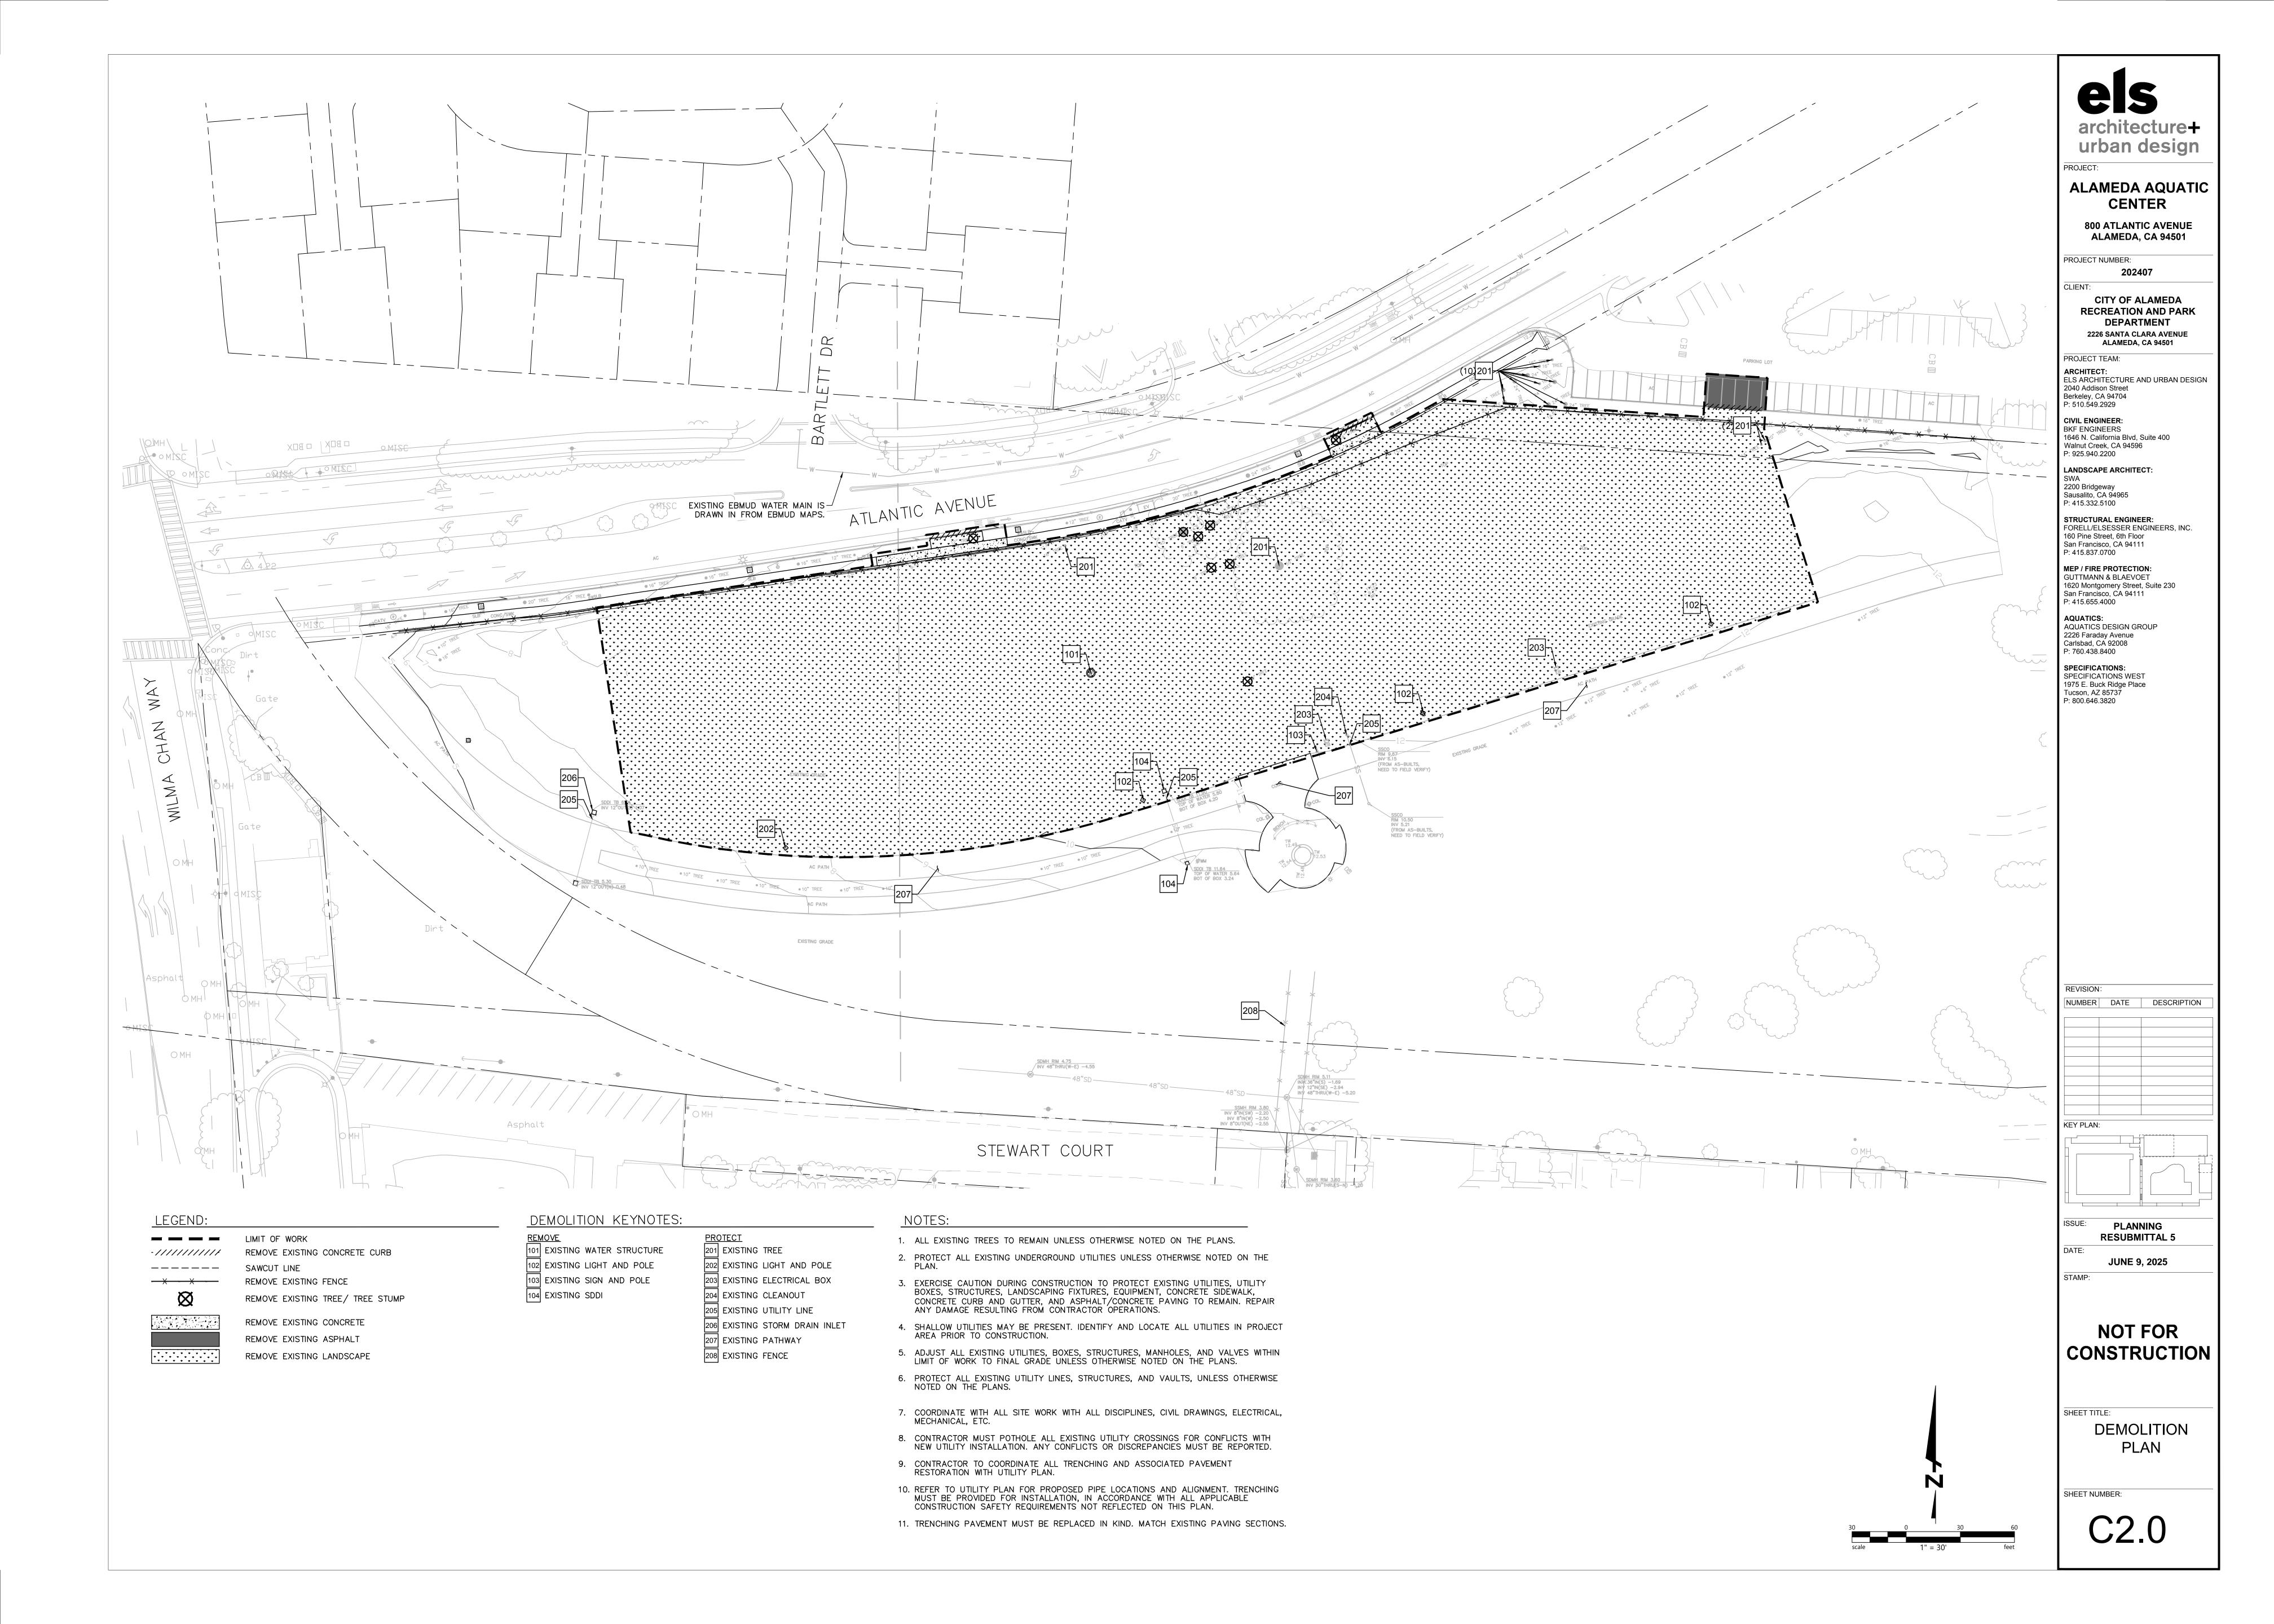
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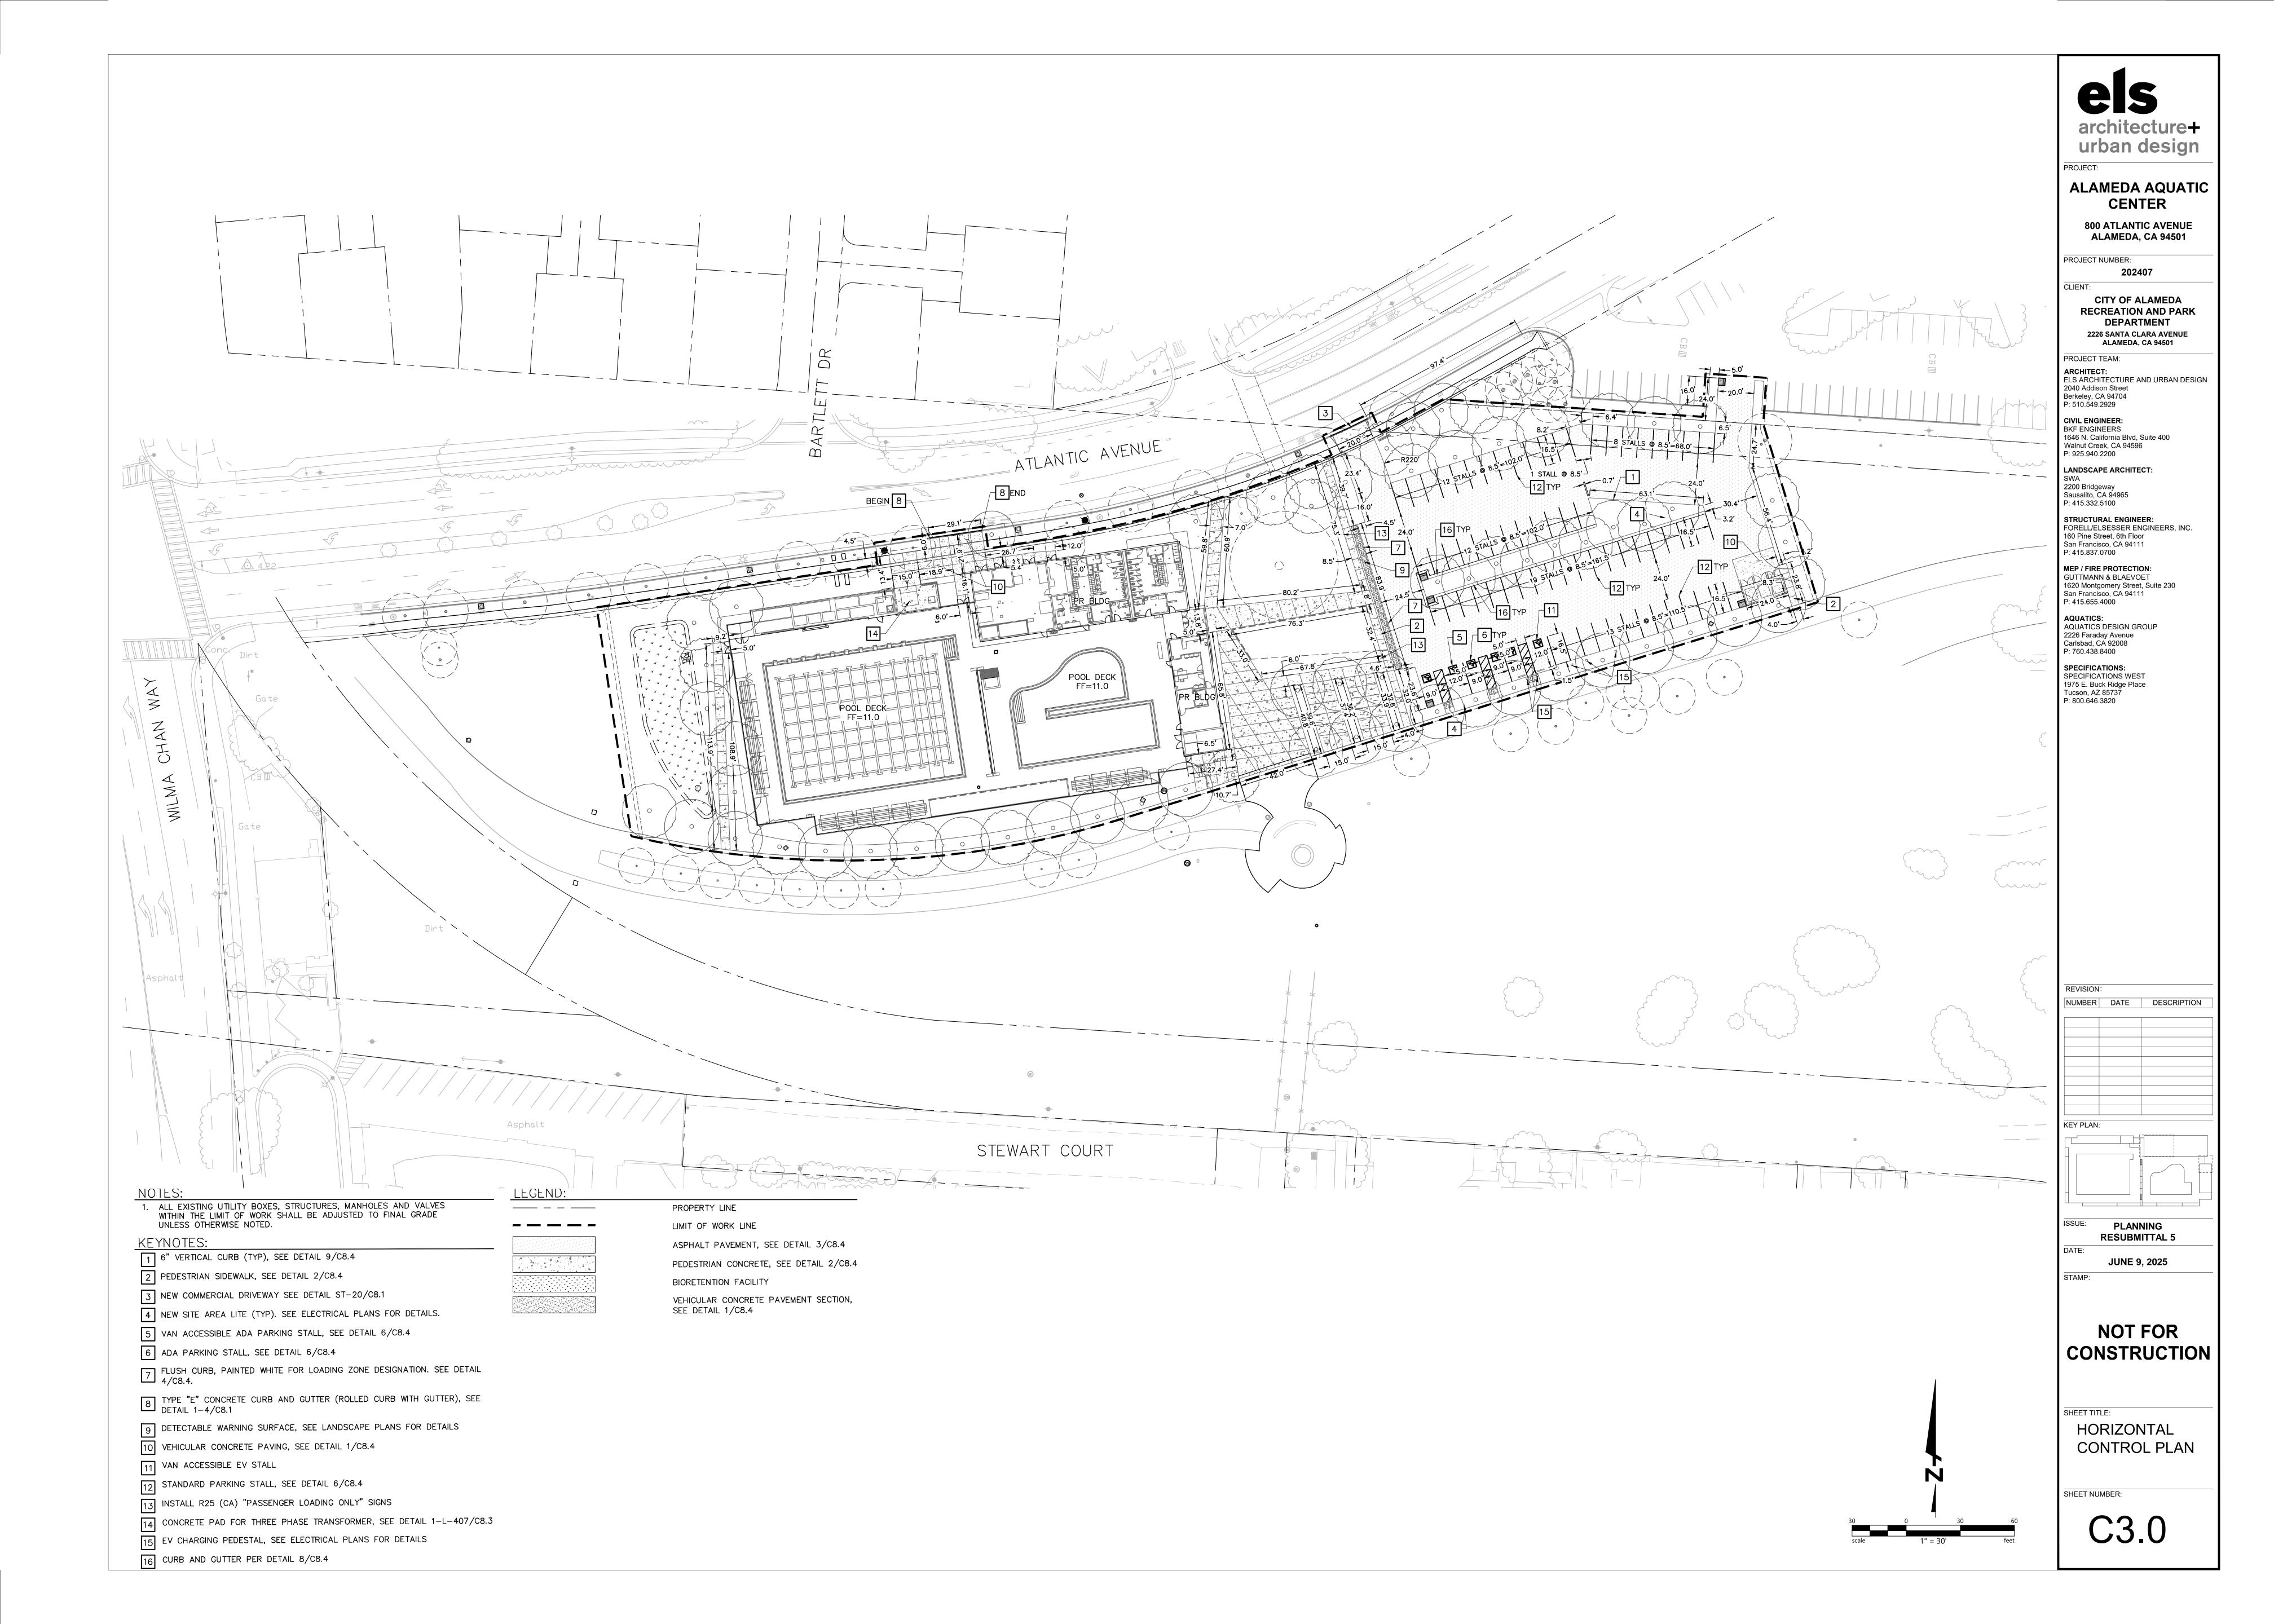
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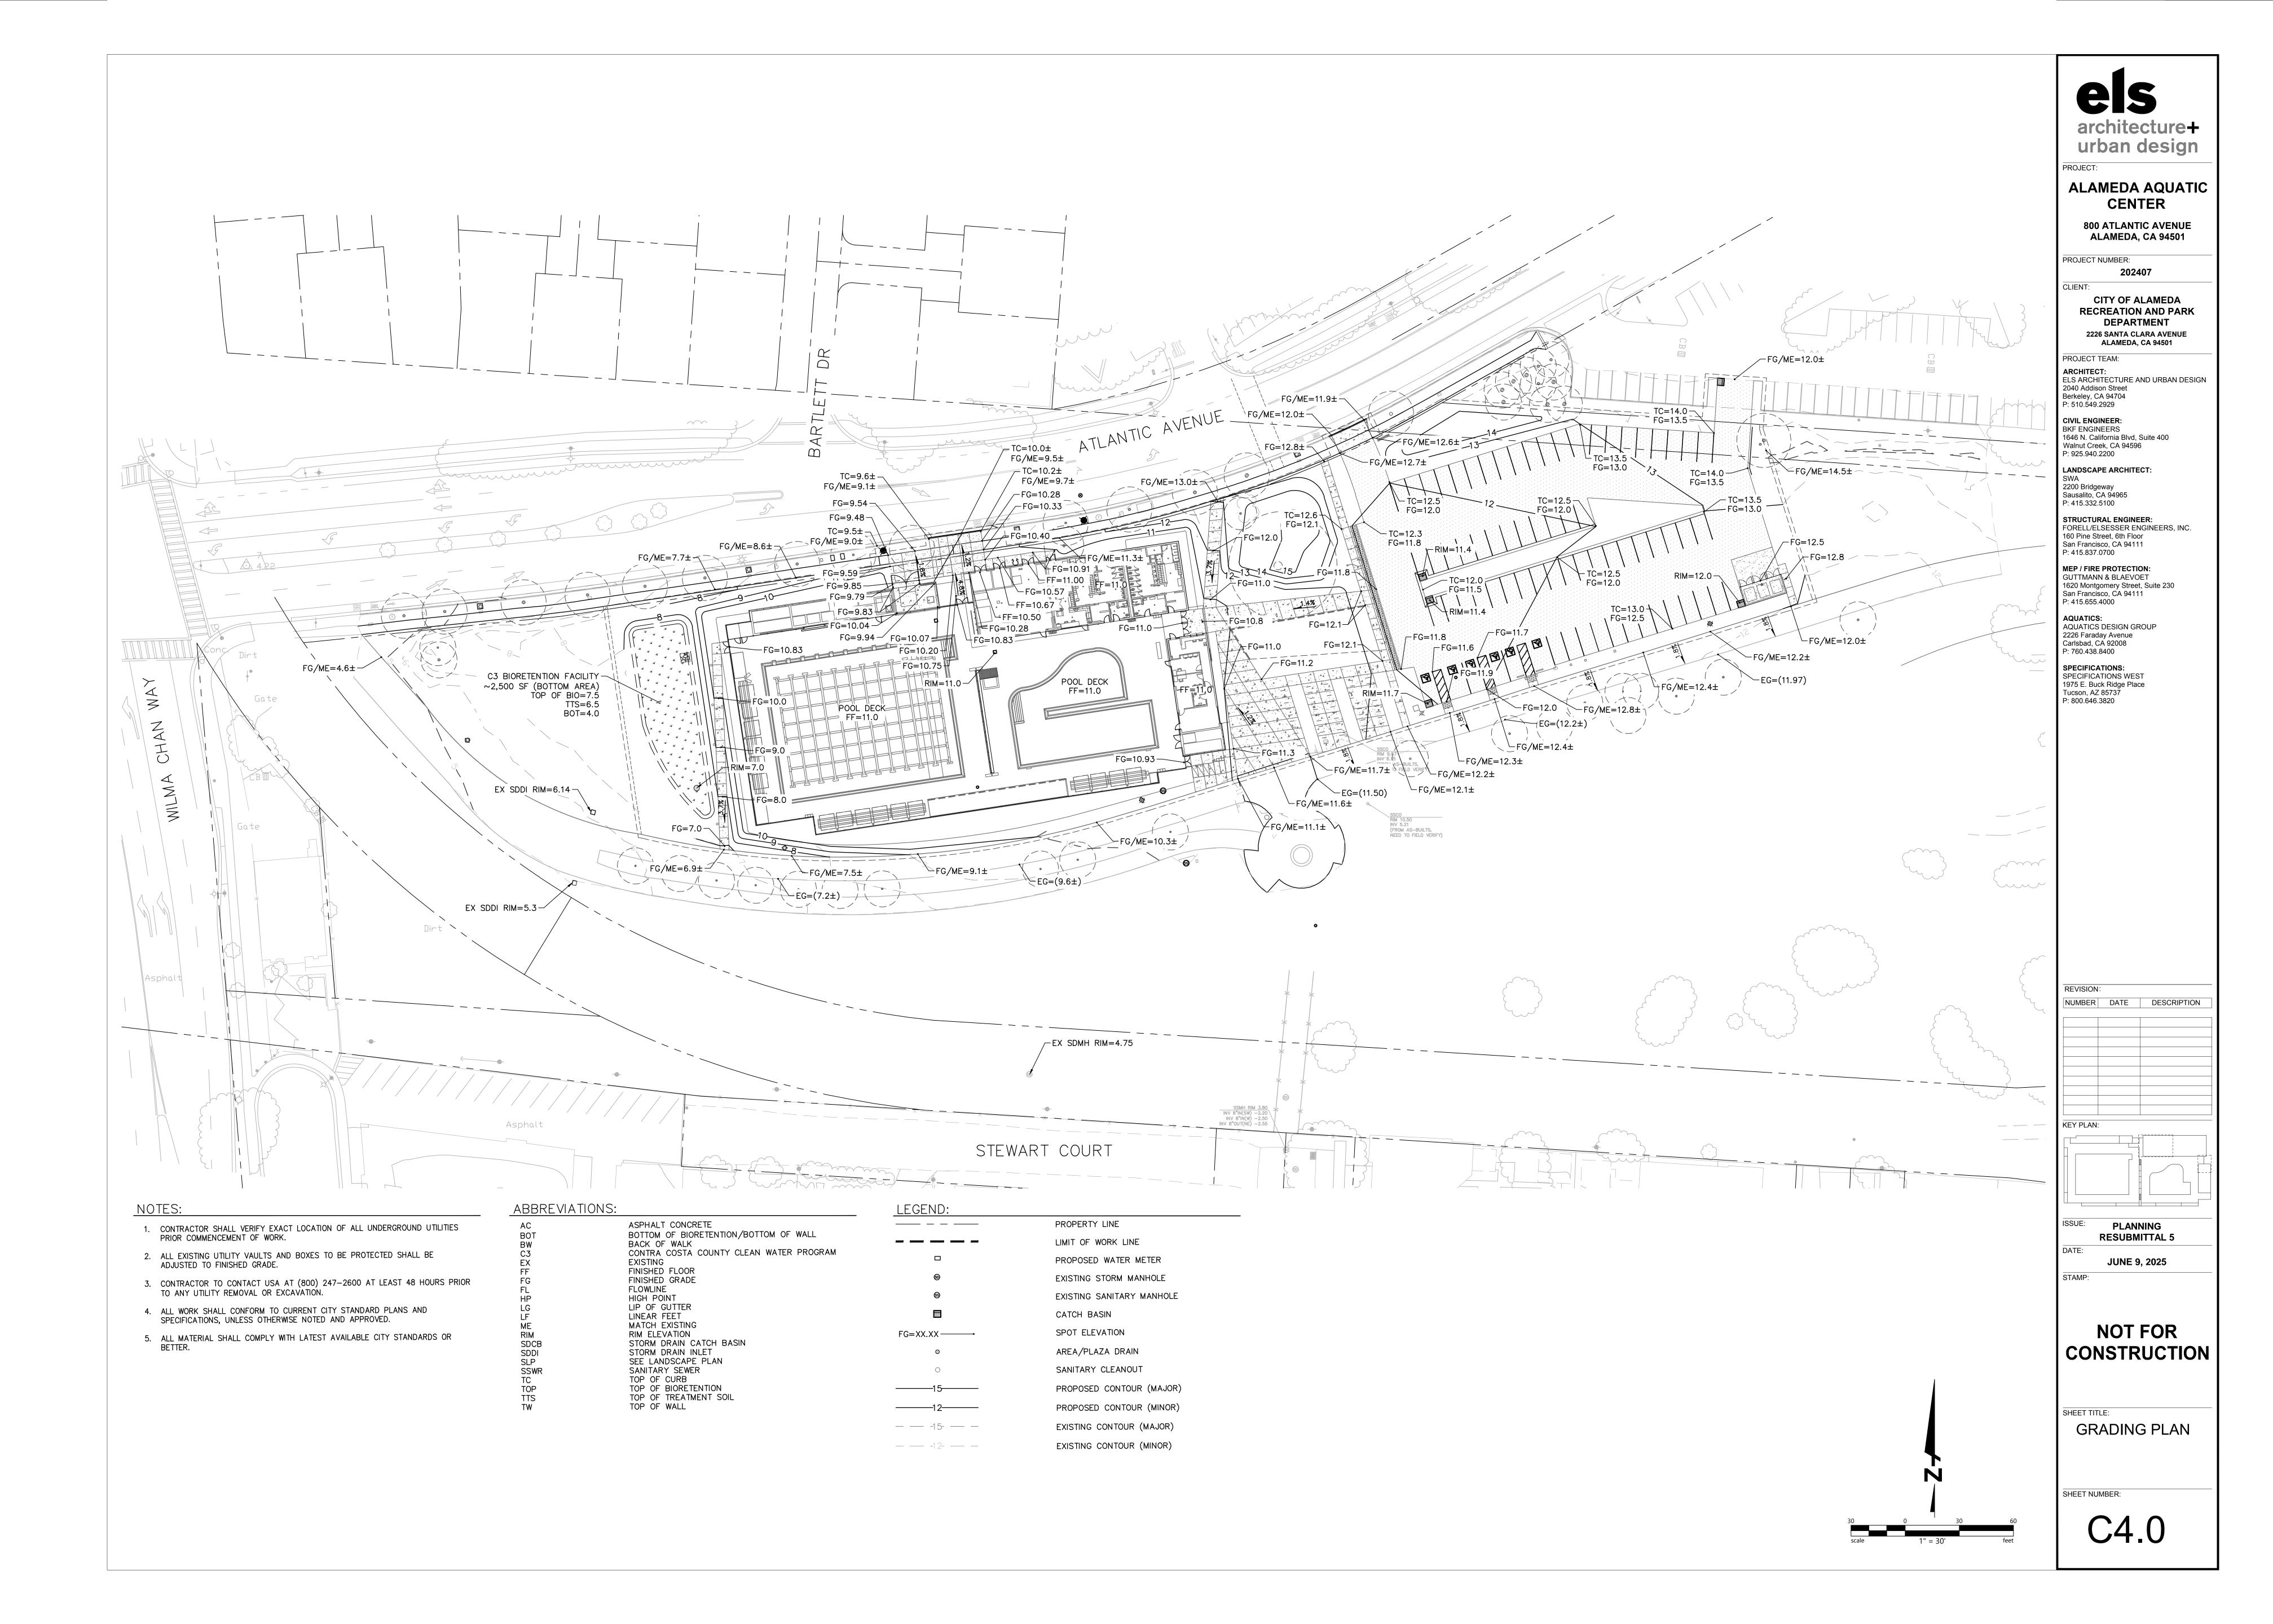
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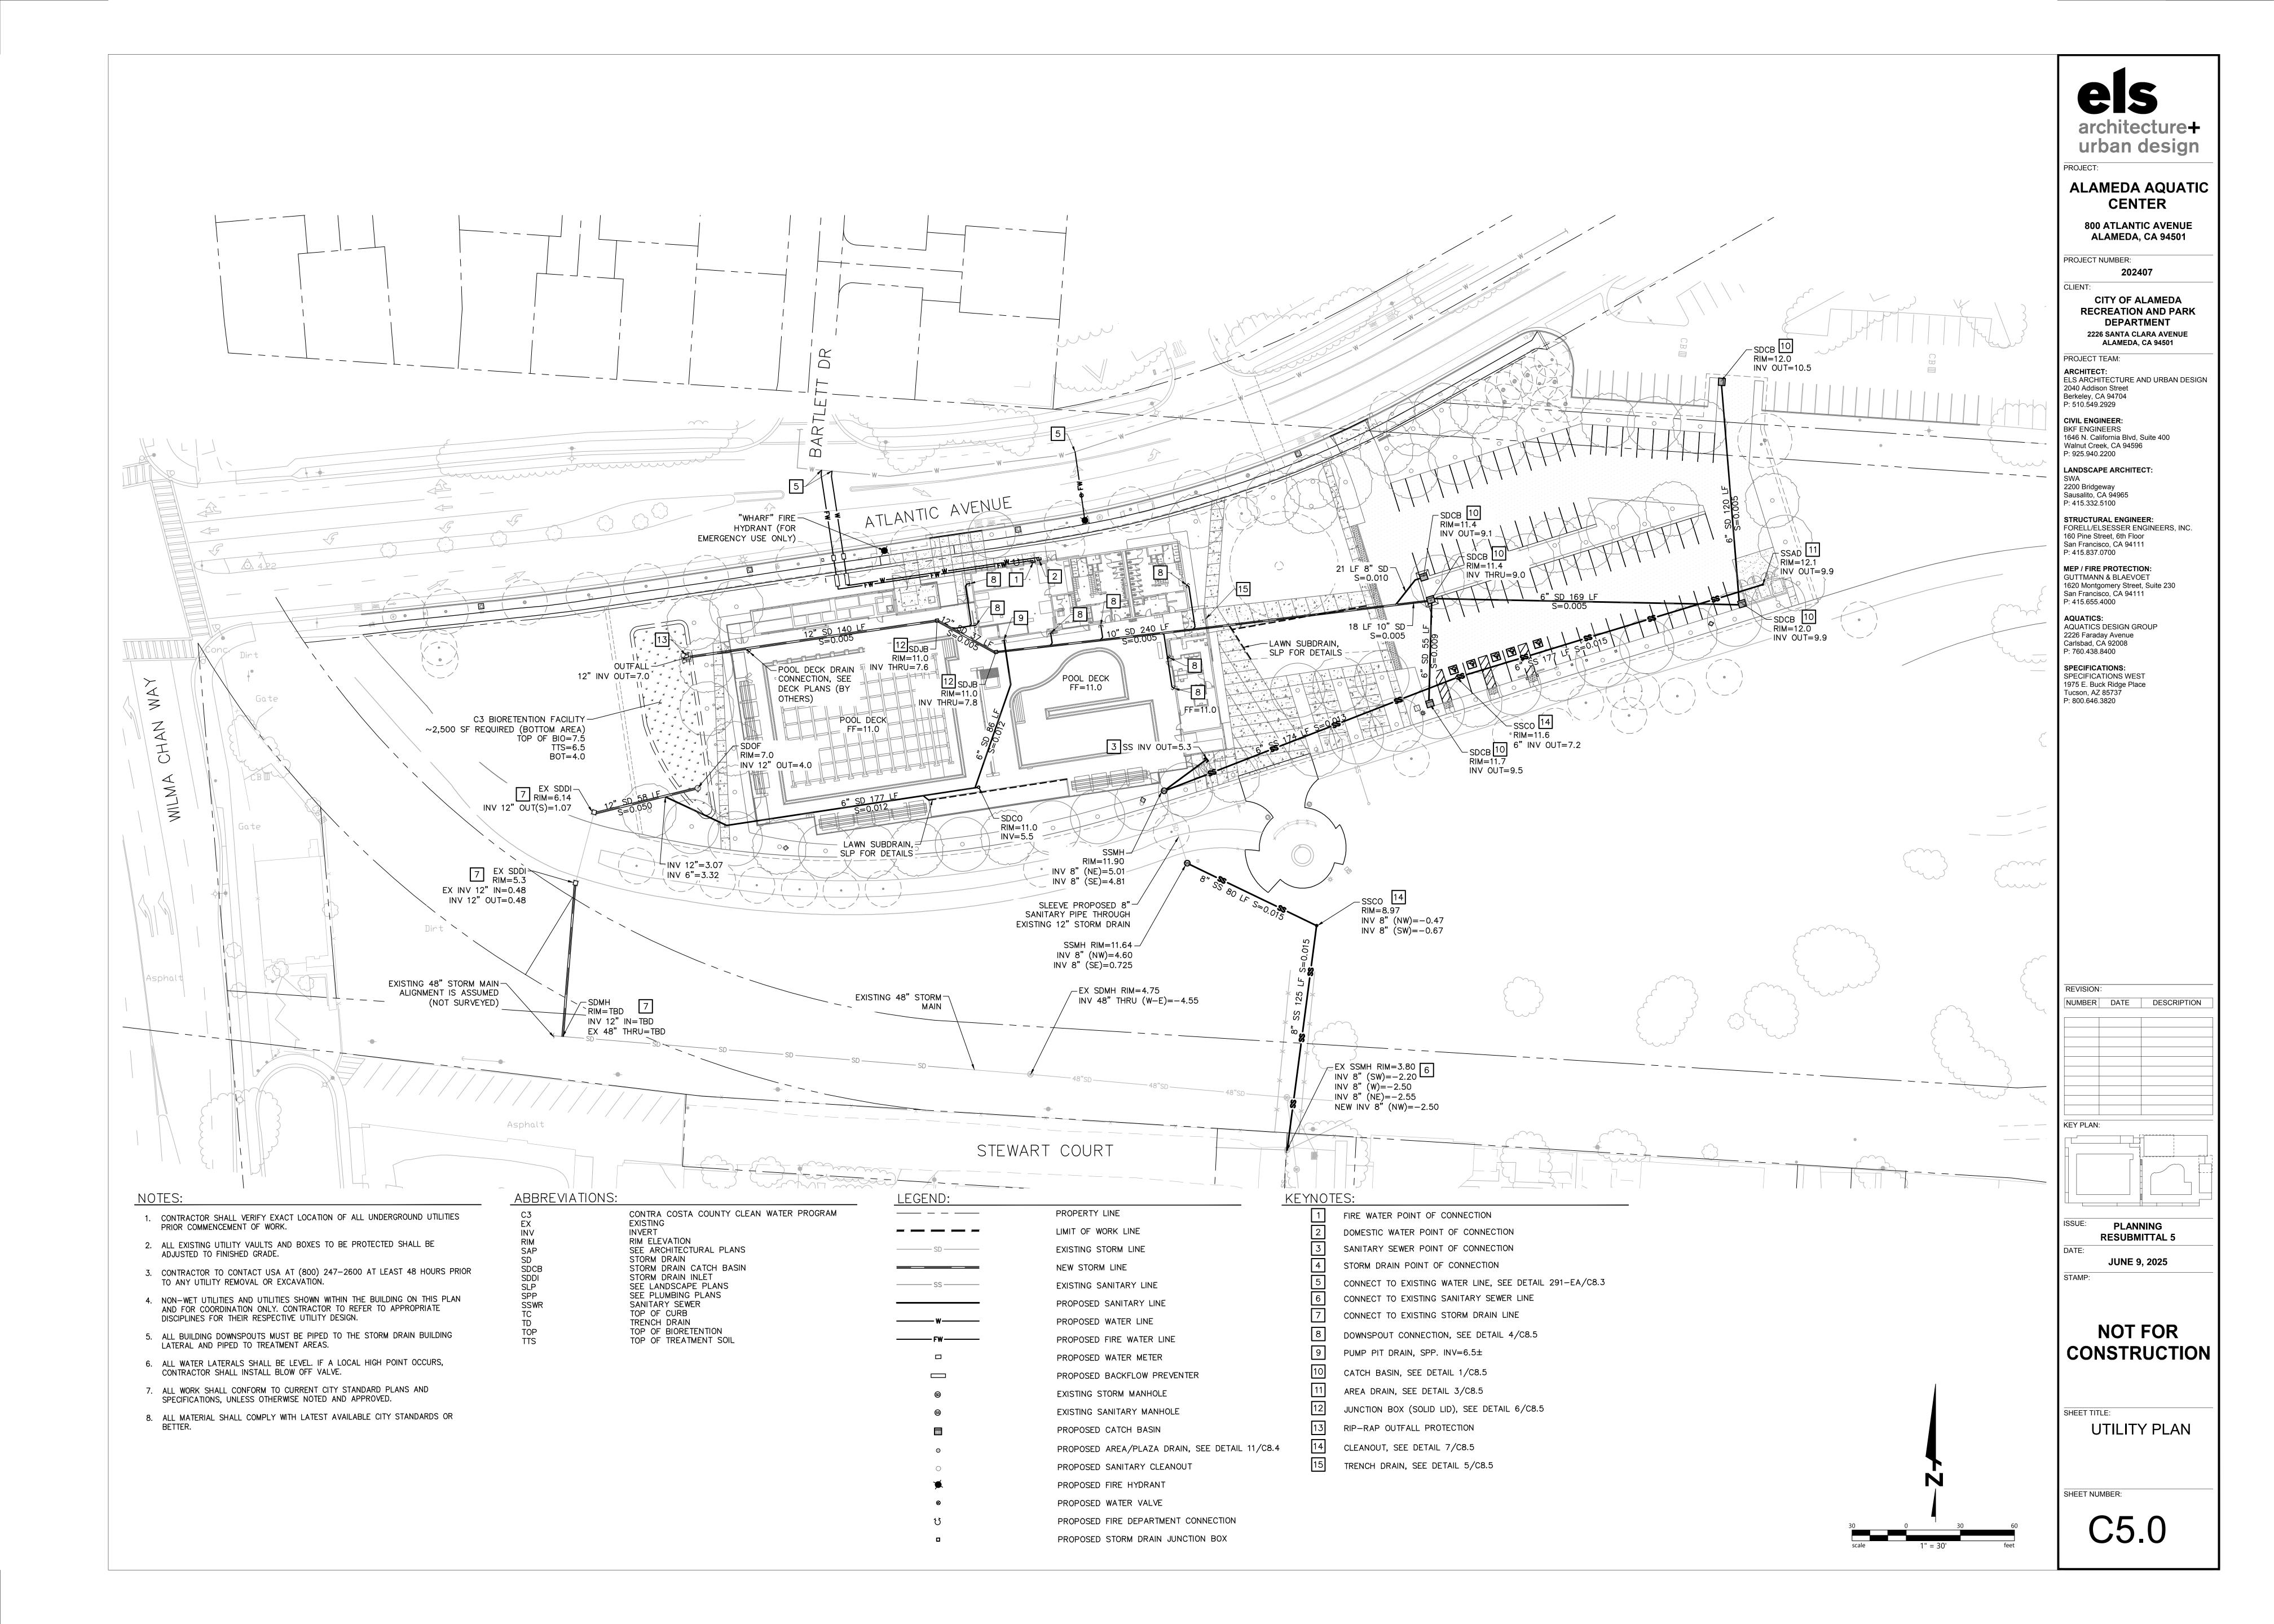












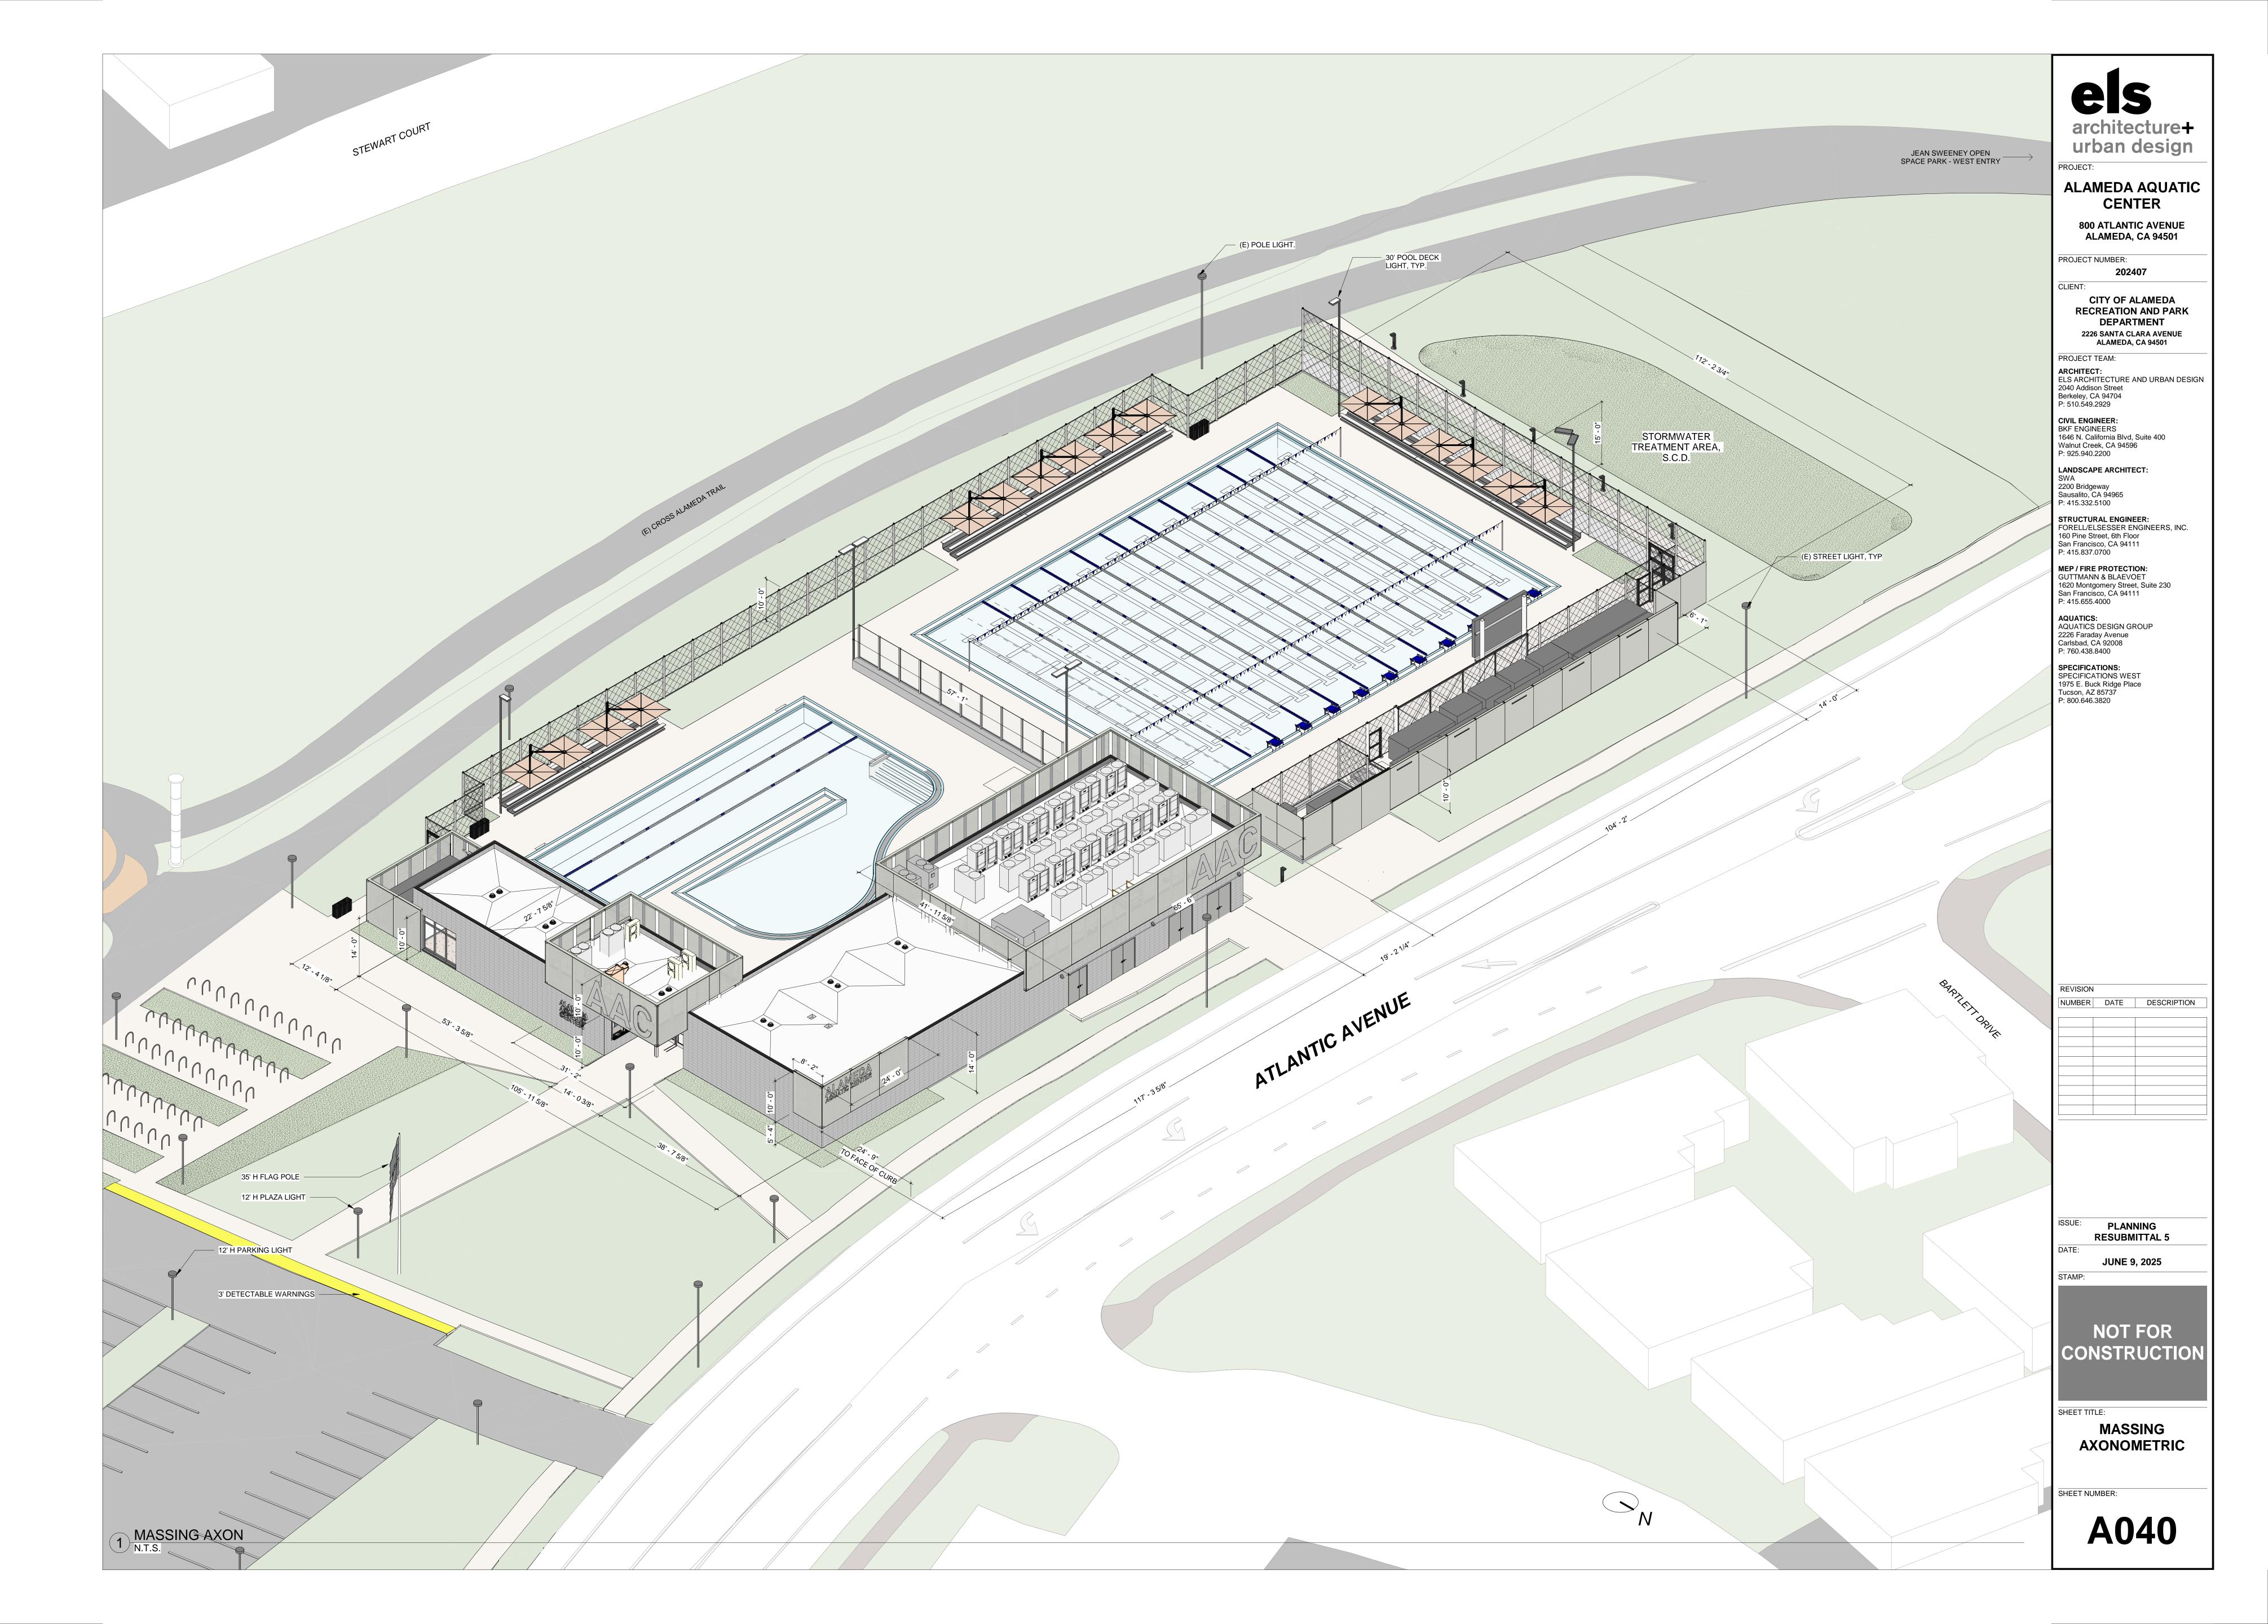

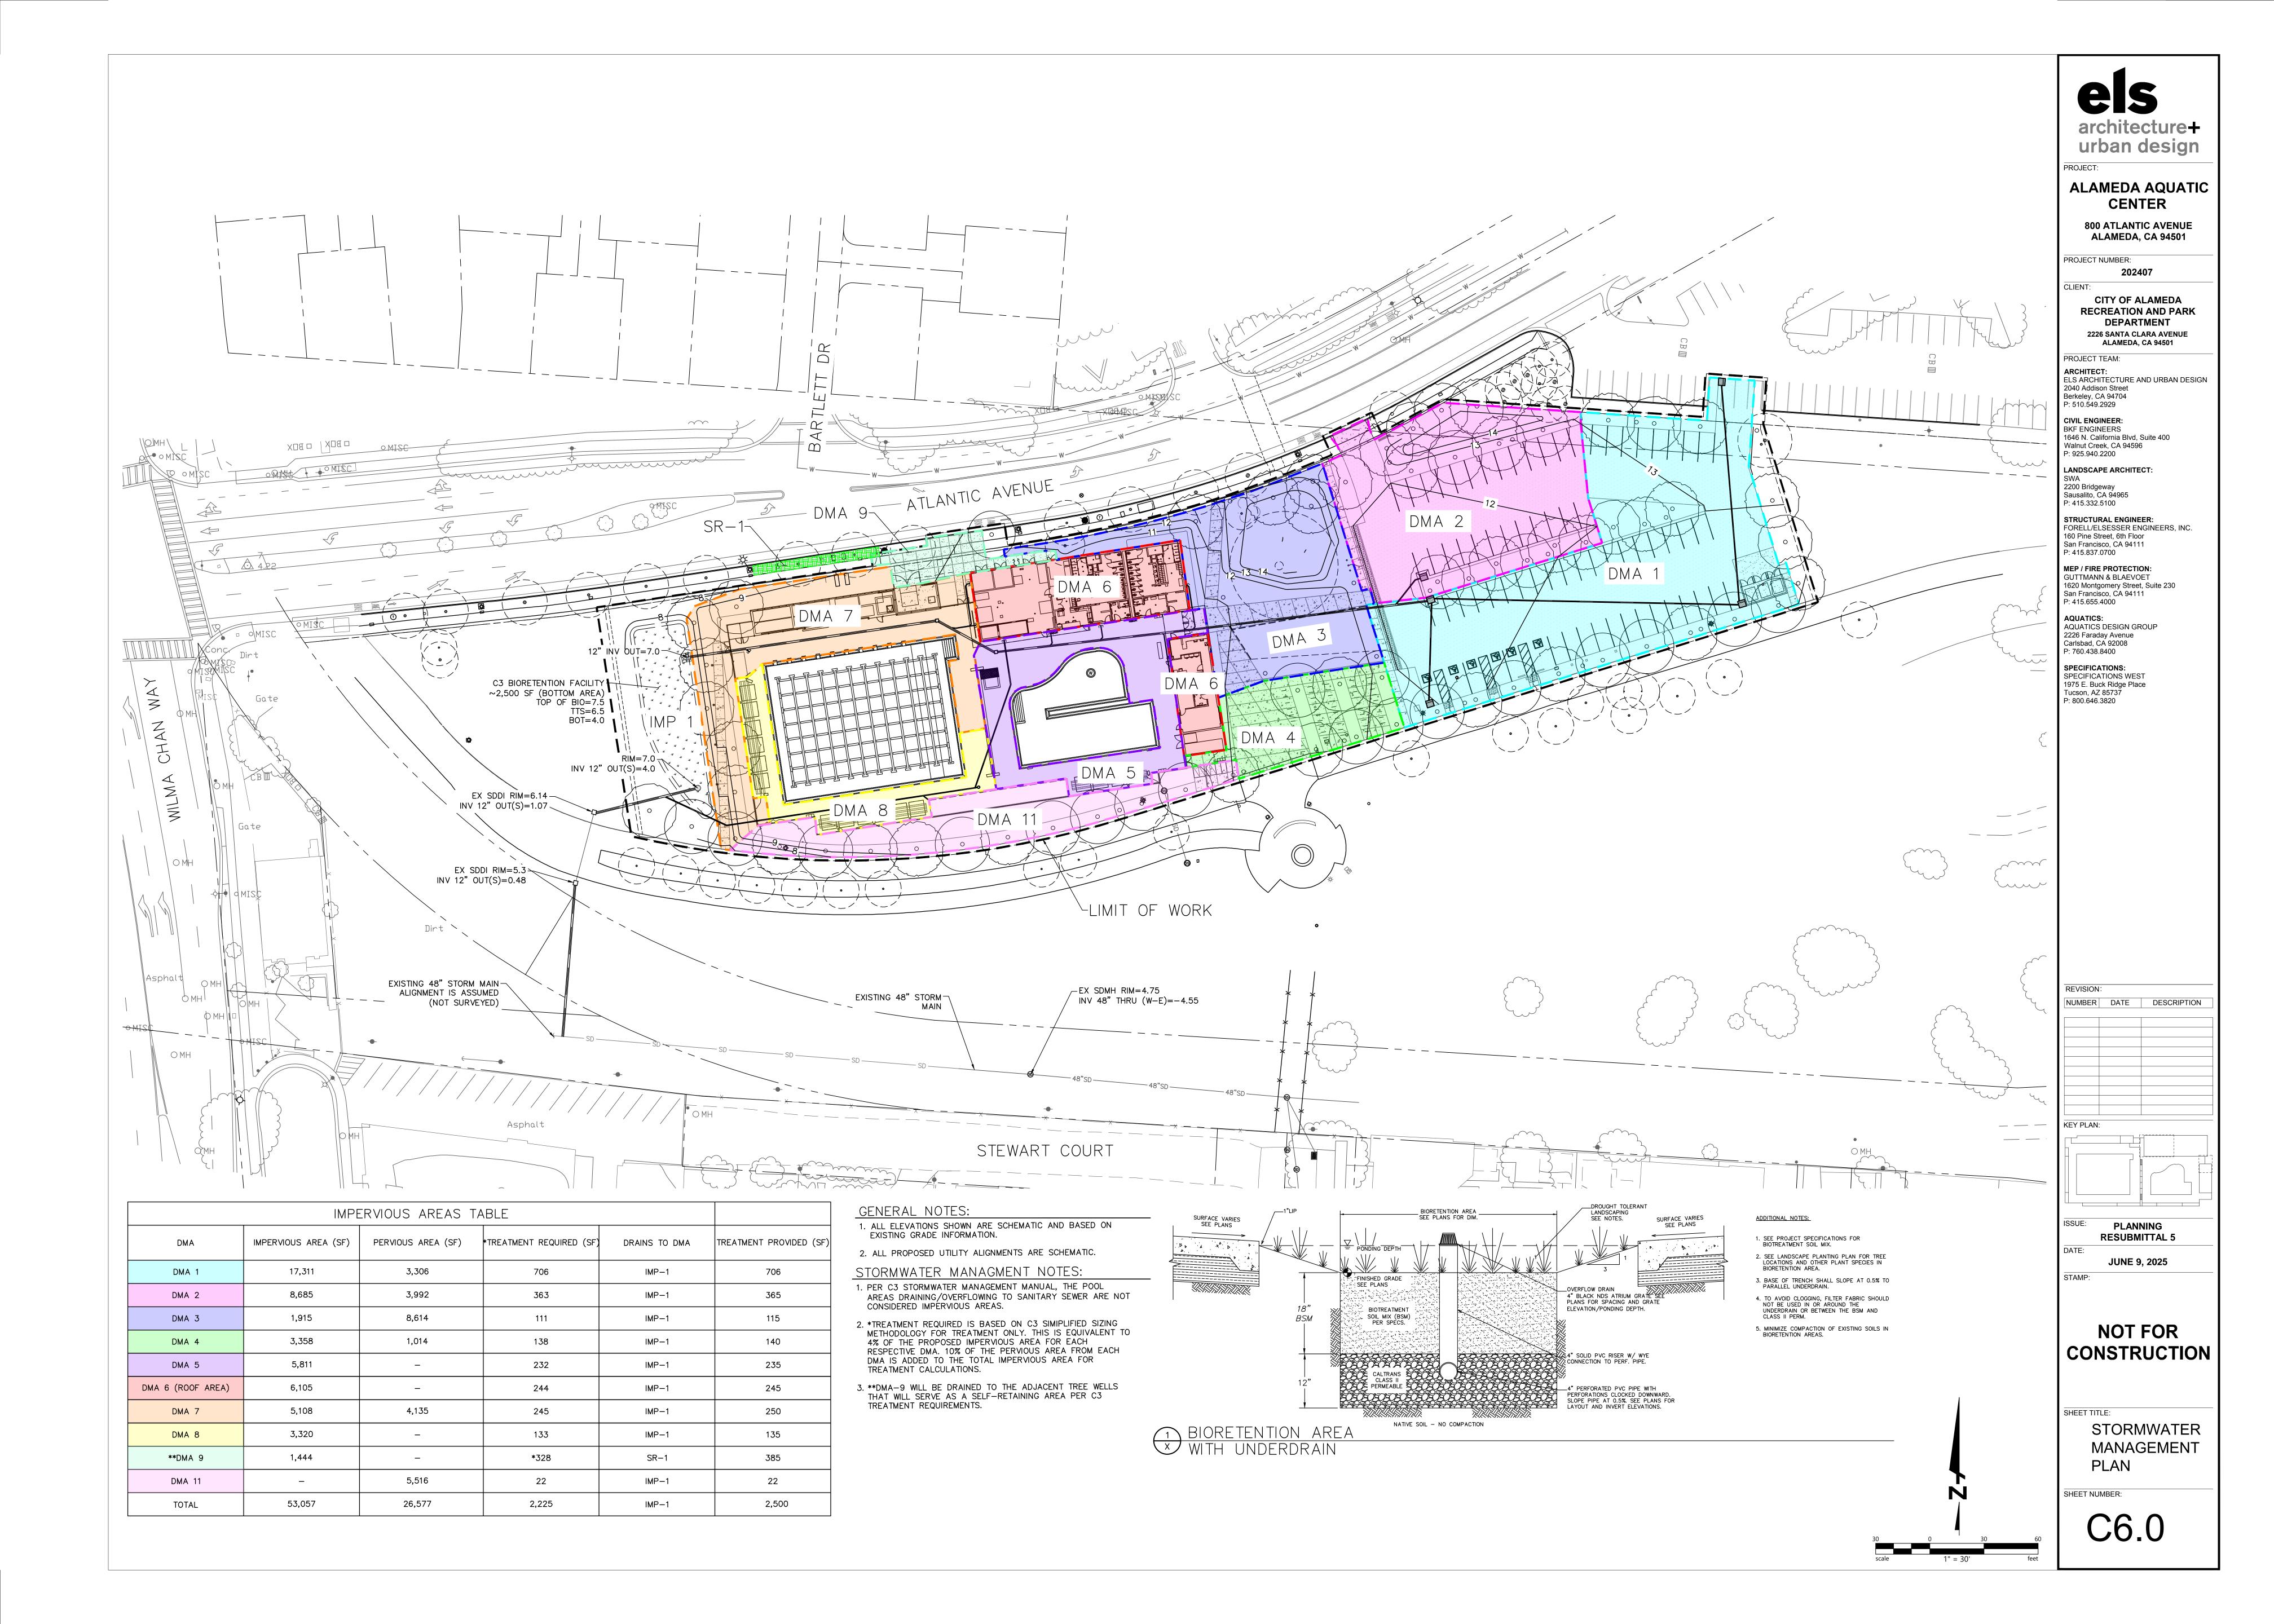

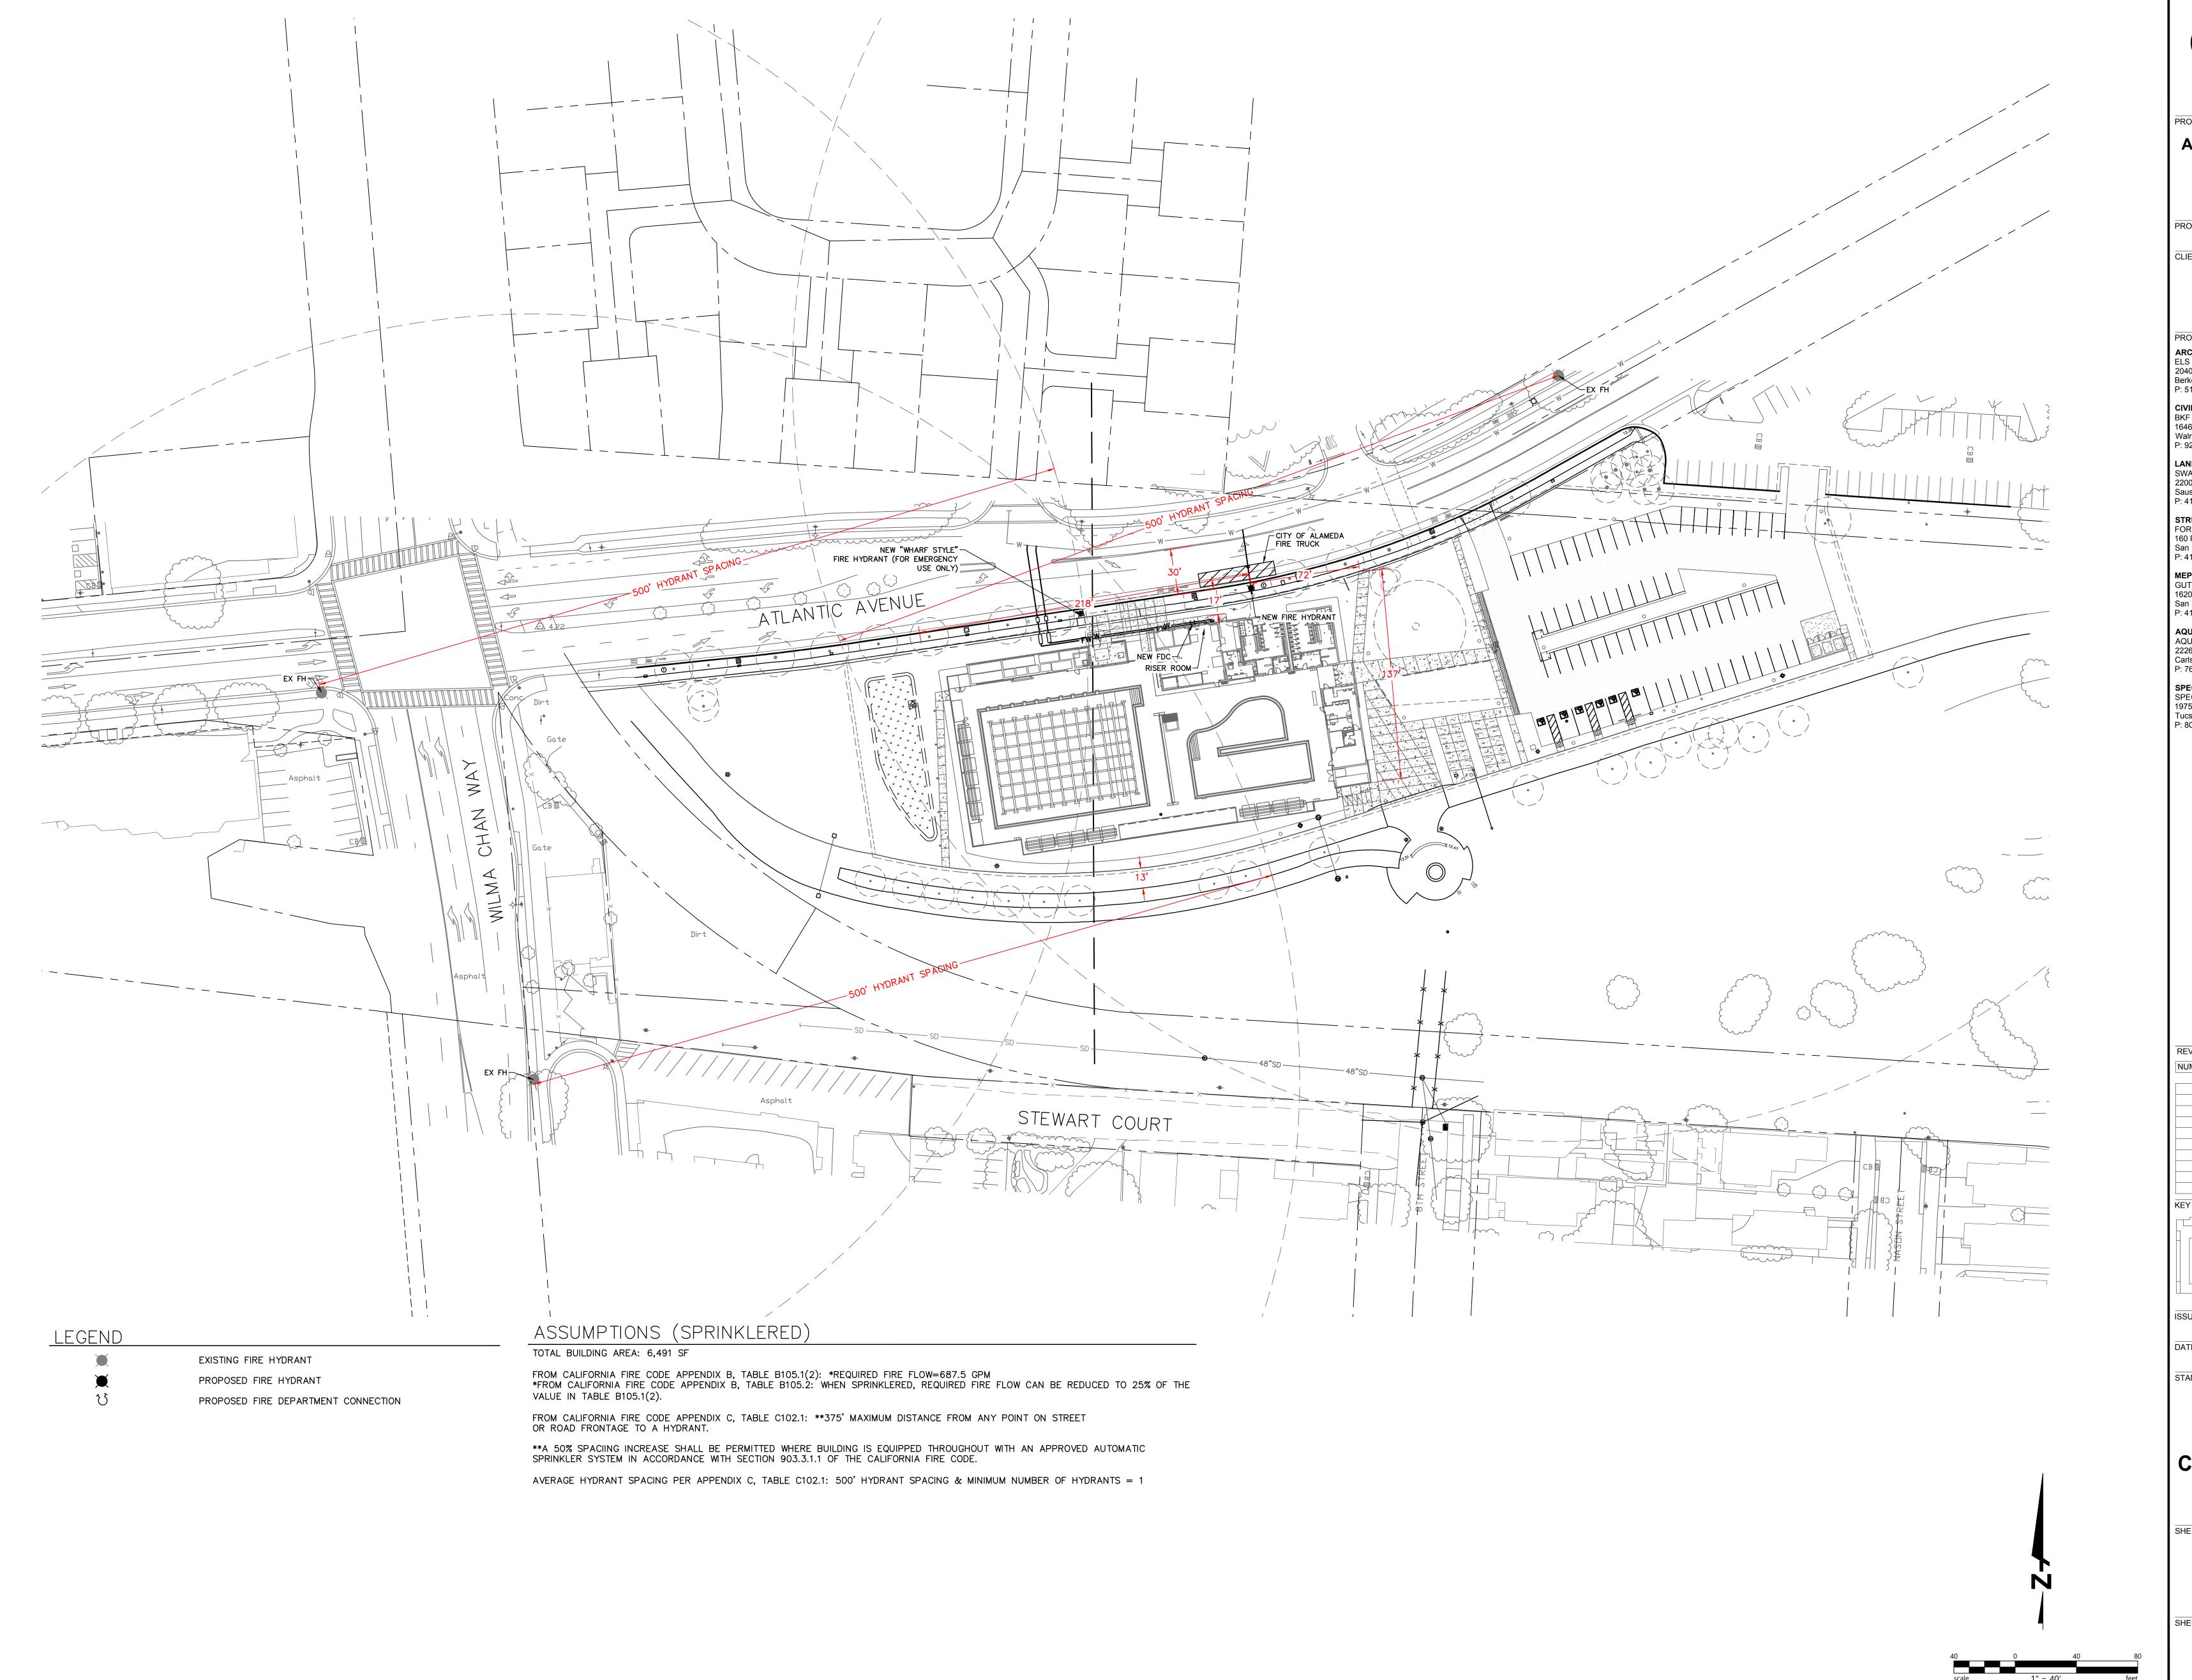

architecture+ urban design

ALAMEDA AQUATIC CENTER

800 ATLANTIC AVENUE ALAMEDA, CA 94501

PROJECT NUMBER: 202407

> **CITY OF ALAMEDA RECREATION AND PARK** DEPARTMENT 2226 SANTA CLARA AVENUE ALAMEDA, CA 94501

PROJECT TEAM: ARCHITECT: ELS ARCHITECTURE AND URBAN DESIGN 2040 Addison Street Berkeley, CA 94704 P: 510.549.2929

CIVIL ENGINEER:
BKF ENGINEERS
1646 N. California Blvd, Suite 400
Walnut Creek, CA 94596
P: 925.940.2200

LANDSCAPE ARCHITECT:

2200 Bridgeway Sausalito, CA 94965 P: 415.332.5100

STRUCTURAL ENGINEER:
FORELL/ELSESSER ENGINEERS, INC.
160 Pine Street, 6th Floor
San Francisco, CA 94111
P: 415.837.0700

MEP / FIRE PROTECTION:
GUTTMANN & BLAEVOET
1620 Montgomery Street, Suite 230
San Francisco, CA 94111
P: 415.655.4000

AQUATICS:
AQUATICS DESIGN GROUP
2226 Faraday Avenue
Carlsbad, CA 92008
P: 760.438.8400

SPECIFICATIONS: SPECIFICATIONS WEST 1975 E. Buck Ridge Place Tucson, AZ 85737 P: 800.646.3820

NUMBER DATE DESCRIPTION KEY PLAN:

PLANNING RESUBMITTAL 5

JUNE 9, 2025

NOT FOR CONSTRUCTION

SHEET TITLE: ACCESS PLAN



architecture+ urban design

ALAMEDA AQUATIC CENTER

800 ATLANTIC AVENUE ALAMEDA, CA 94501

PROJECT NUMBER:

CITY OF ALAMEDA RECREATION AND PARK **DEPARTMENT** 2226 SANTA CLARA AVENUE

ALAMEDA, CA 94501

PROJECT TEAM:

ARCHITECT: ELS ARCHITECTURE AND URBAN DESIGN 2040 Addison Street Berkeley, CA 94704 P: 510.549.2929

CIVIL ENGINEER: BKF ENGINEERS 1646 N. California Blvd, Suite 400 Walnut Creek, CA 94596 P: 925.940.2200

LANDSCAPE ARCHITECT: 2200 Bridgeway Sausalito, CA 94965

P: 415.332.5100 STRUCTURAL ENGINEER:
FORELL/ELSESSER ENGINEERS, INC.
160 Pine Street, 6th Floor
San Francisco, CA 94111

P: 415.837.0700 MEP / FIRE PROTECTION: GUTTMANN & BLAEVOET 1620 Montgomery Street, Suite 230 San Francisco, CA 94111 P: 415.655.4000

AQUATICS: AQUATICS DESIGN GROUP

P: 760.438.8400 SPECIFICATIONS:

PLANNING RESUBMITTAL 5

JUNE 9, 2025

NOT FOR CONSTRUCTION

EXISTING CONDITIONS



architecture+ urban design

ALAMEDA AQUATIC CENTER

800 ATLANTIC AVENUE ALAMEDA, CA 94501

PROJECT NUMBER:

CITY OF ALAMEDA RECREATION AND PARK

DEPARTMENT 2226 SANTA CLARA AVENUE ALAMEDA, CA 94501

PROJECT TEAM:

ARCHITECT: ELS ARCHITECTURE AND URBAN DESIGN 2040 Addison Street Berkeley, CA 94704 P: 510.549.2929

CIVIL ENGINEER: BKF ENGINEERS 1646 N. California Blvd, Suite 400 Walnut Creek, CA 94596 P: 925.940.2200

LANDSCAPE ARCHITECT:

P: 415.332.5100 STRUCTURAL ENGINEER:
FORELL/ELSESSER ENGINEERS, INC.
160 Pine Street, 6th Floor
San Francisco, CA 94111

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AQUATICS: AQUATICS DESIGN GROUP 2226 Faraday Avenue Carlsbad, CA 92008

SPECIFICATIONS: SPECIFICATIONS.
SPECIFICATIONS WEST
1975 E. Buck Ridge Place
Tucson, AZ 85737
P: 800.646.3820


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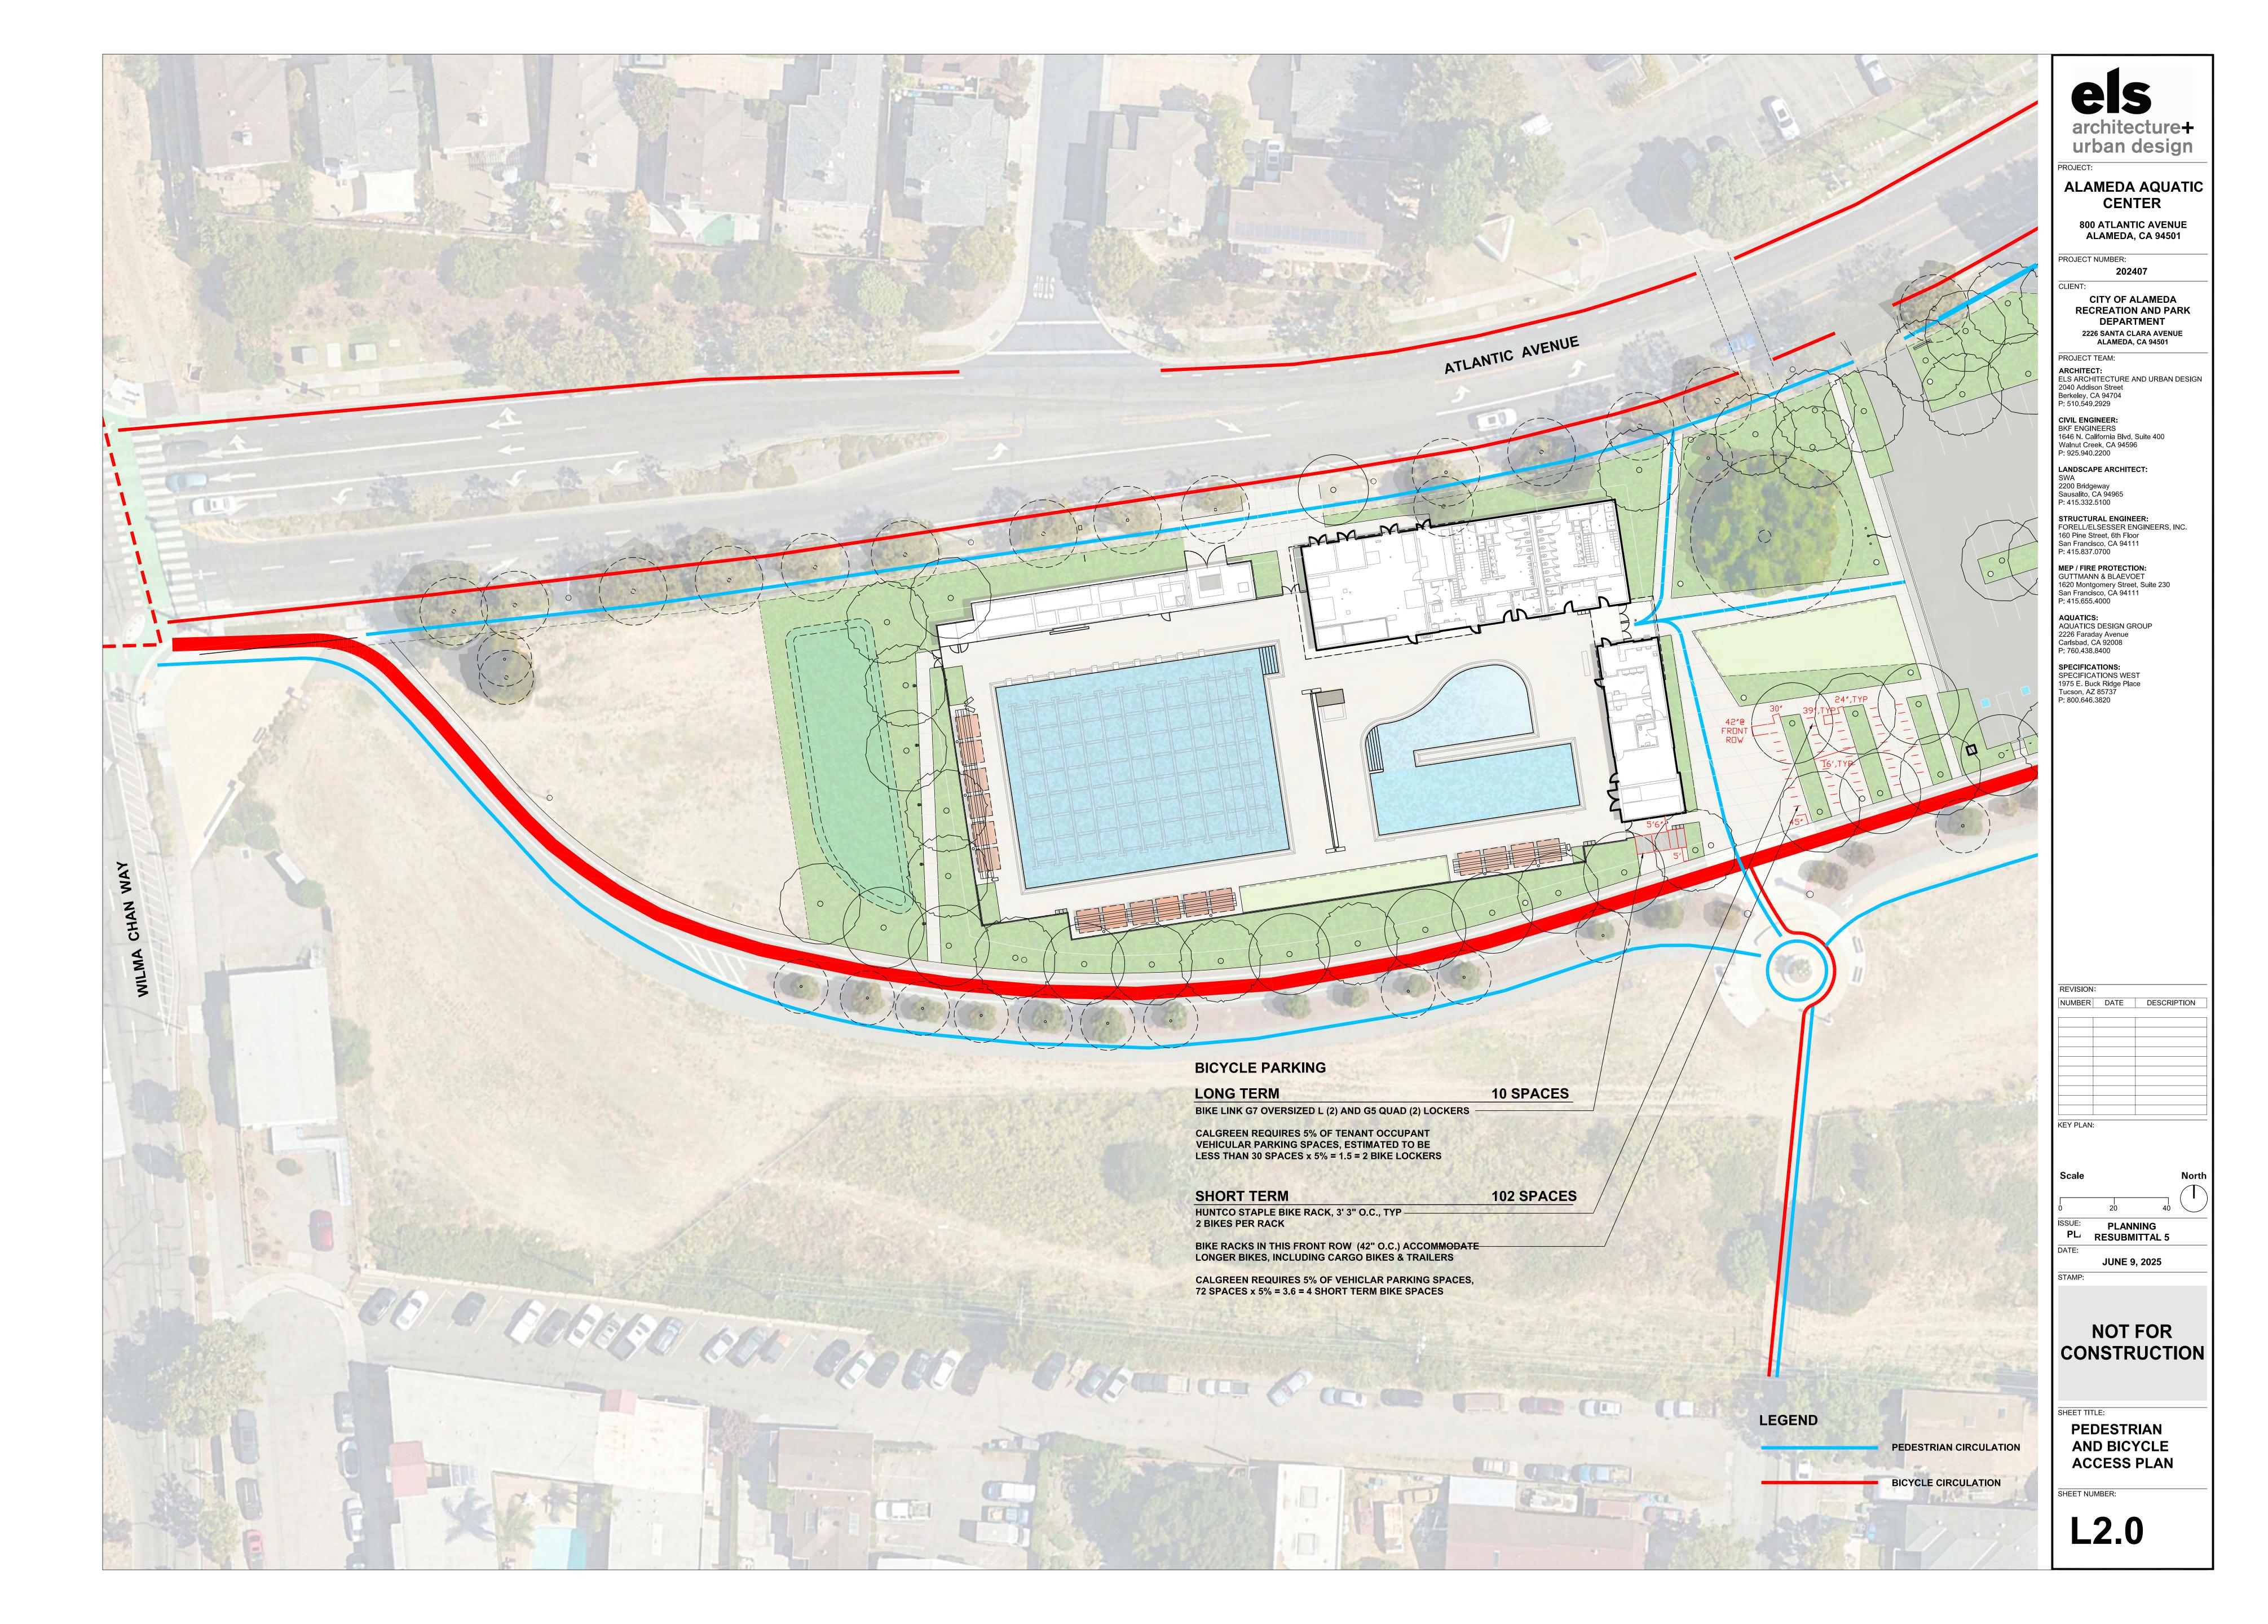
PLANNING RESUBMITTAL 5

JUNE 9, 2025

NOT FOR CONSTRUCTION

ILLUSTRATIVE PLAN



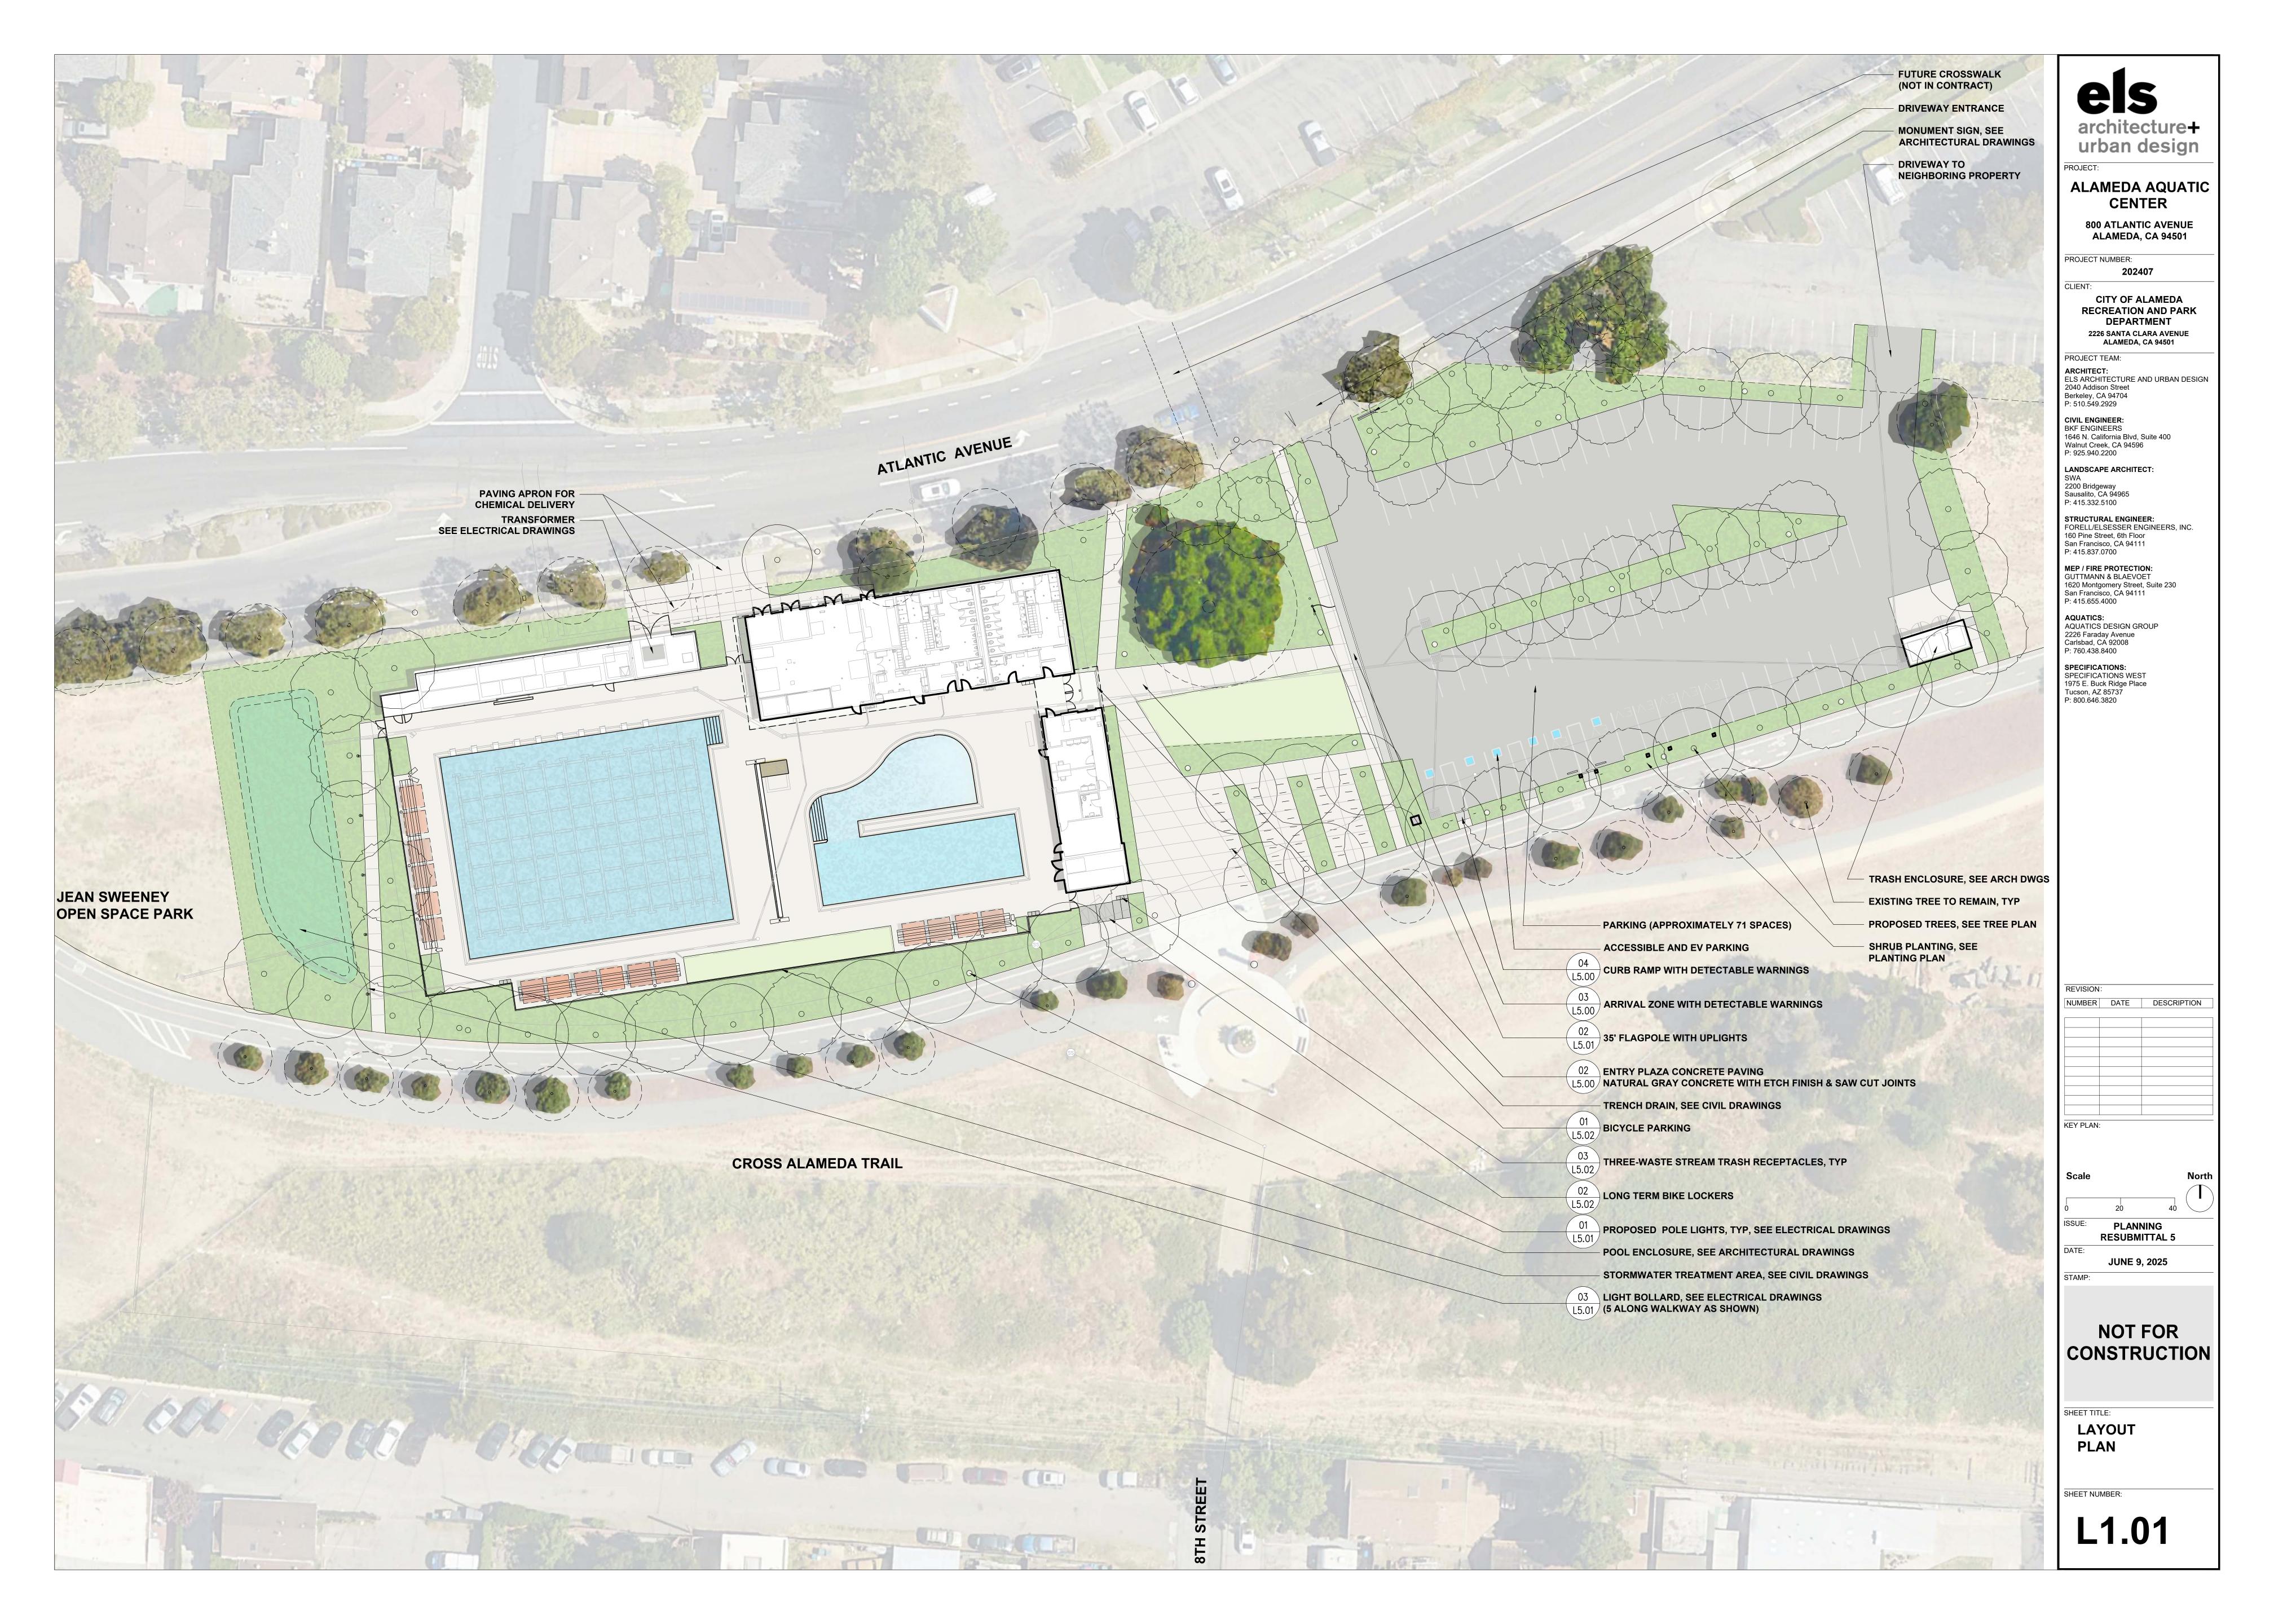











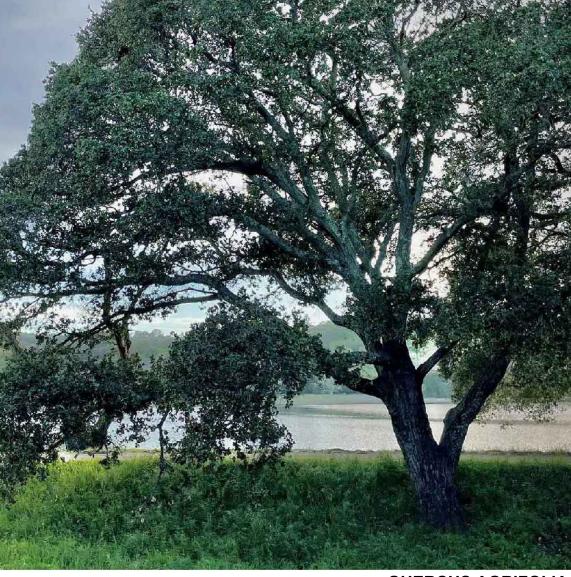

QUERCUS AGRIFOLIA COAST LIVE OAK

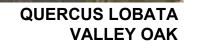

KEN TAYLOR MANZANITA



ARCTOSTAPHYLOS 'HOWARD McMINN' **HOWARD McMINN MANZANITA**





BACCHARIS PILURARIS 'TWIN PEAKS'

TWIN PEAKS COYOTE BRUSH



SALVIA CHAMAEDRYOIDES ' MARINE BLUE'
MARINE BLUE SAGE

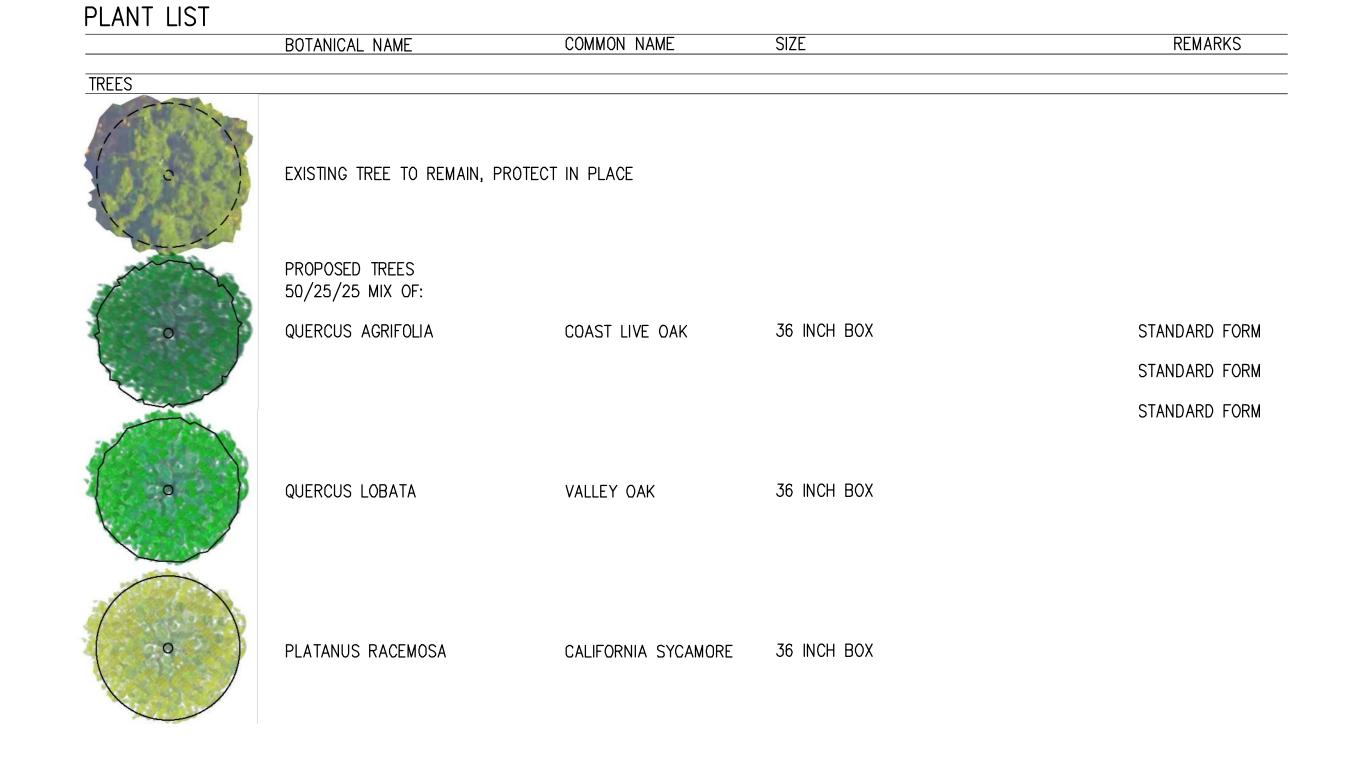

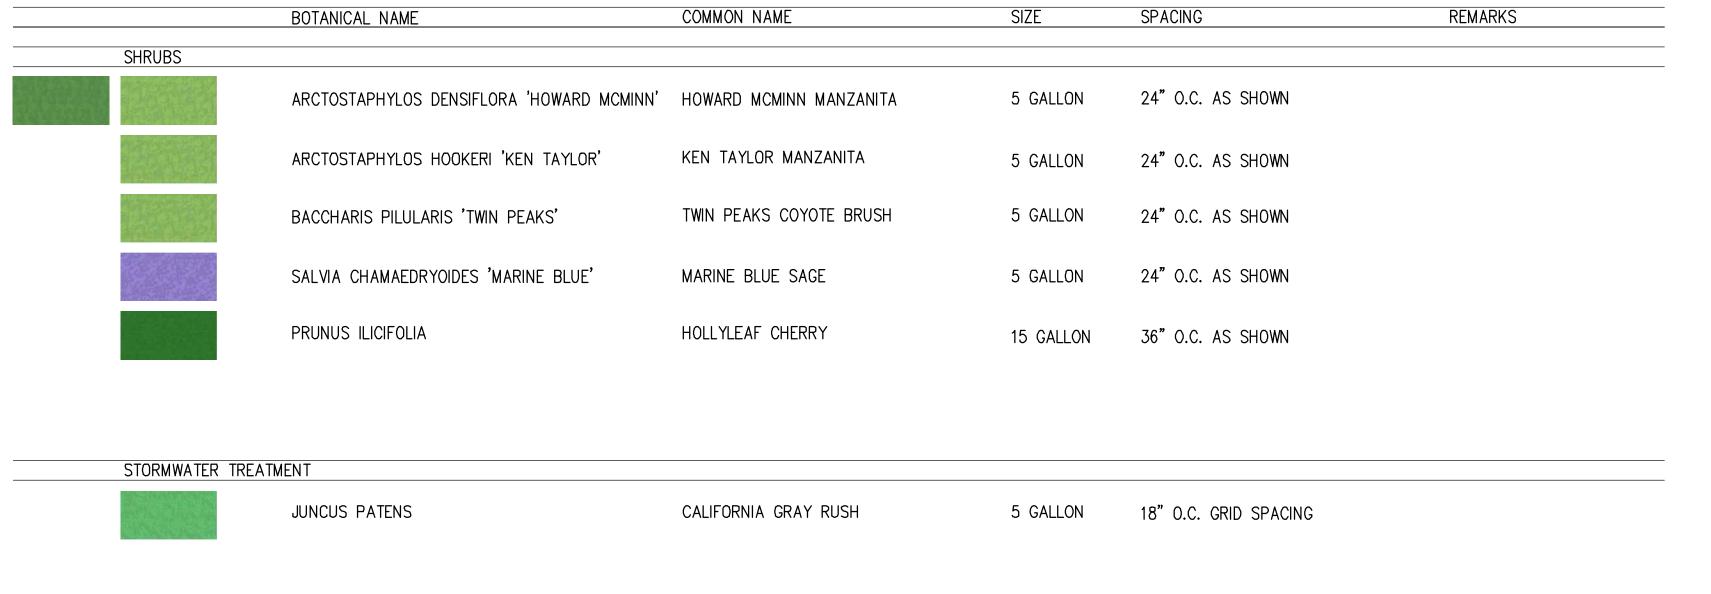

SOD LAWN

90/10 DWARF FESCUE/BLUEGRASS MIX BOLERO PLUS SOD, FROM DELTA BLUEGRASS

architecture+ urban design

ALAMEDA AQUATIC CENTER

800 ATLANTIC AVENUE

ALAMEDA, CA 94501

PROJECT NUMBER: 202407

> CITY OF ALAMEDA **RECREATION AND PARK** DEPARTMENT

2226 SANTA CLARA AVENUE ALAMEDA, CA 94501

PROJECT TEAM: ARCHITECT:

ELS ARCHITECTURE AND URBAN DESIGN 2040 Addison Street Berkeley, CA 94704 P: 510.549.2929

CIVIL ENGINEER: BKF ENGINEERS

1646 N. California Blvd, Suite 400 Walnut Creek, CA 94596 P: 925.940.2200

LANDSCAPE ARCHITECT: 2200 Bridgeway Sausalito, CA 94965

P: 415.332.5100

STRUCTURAL ENGINEER: FORELL/ELSESSER ENGINEERS, INC. 160 Pine Street, 6th Floor San Francisco, CA 94111

P: 415.837.0700 MEP / FIRE PROTECTION: GUTTMANN & BLAEVOET 1620 Montgomery Street, Suite 230 San Francisco, CA 94111 P: 415.655.4000

AQUATICS: AQUATICS DESIGN GROUP 2226 Faraday Avenue Carlsbad, CA 92008 P: 760.438.8400

SPECIFICATIONS: SPECIFICATIONS WEST 1975 E. Buck Ridge Place Tucson, AZ 85737 P: 800.646.3820

| REVISION: | | | | | | | |
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| KEY PLAN: | | | | | | | |

PLANNING RESUBMITTAL 5

JUNE 9, 2025


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PLANT LIST & IMAGES

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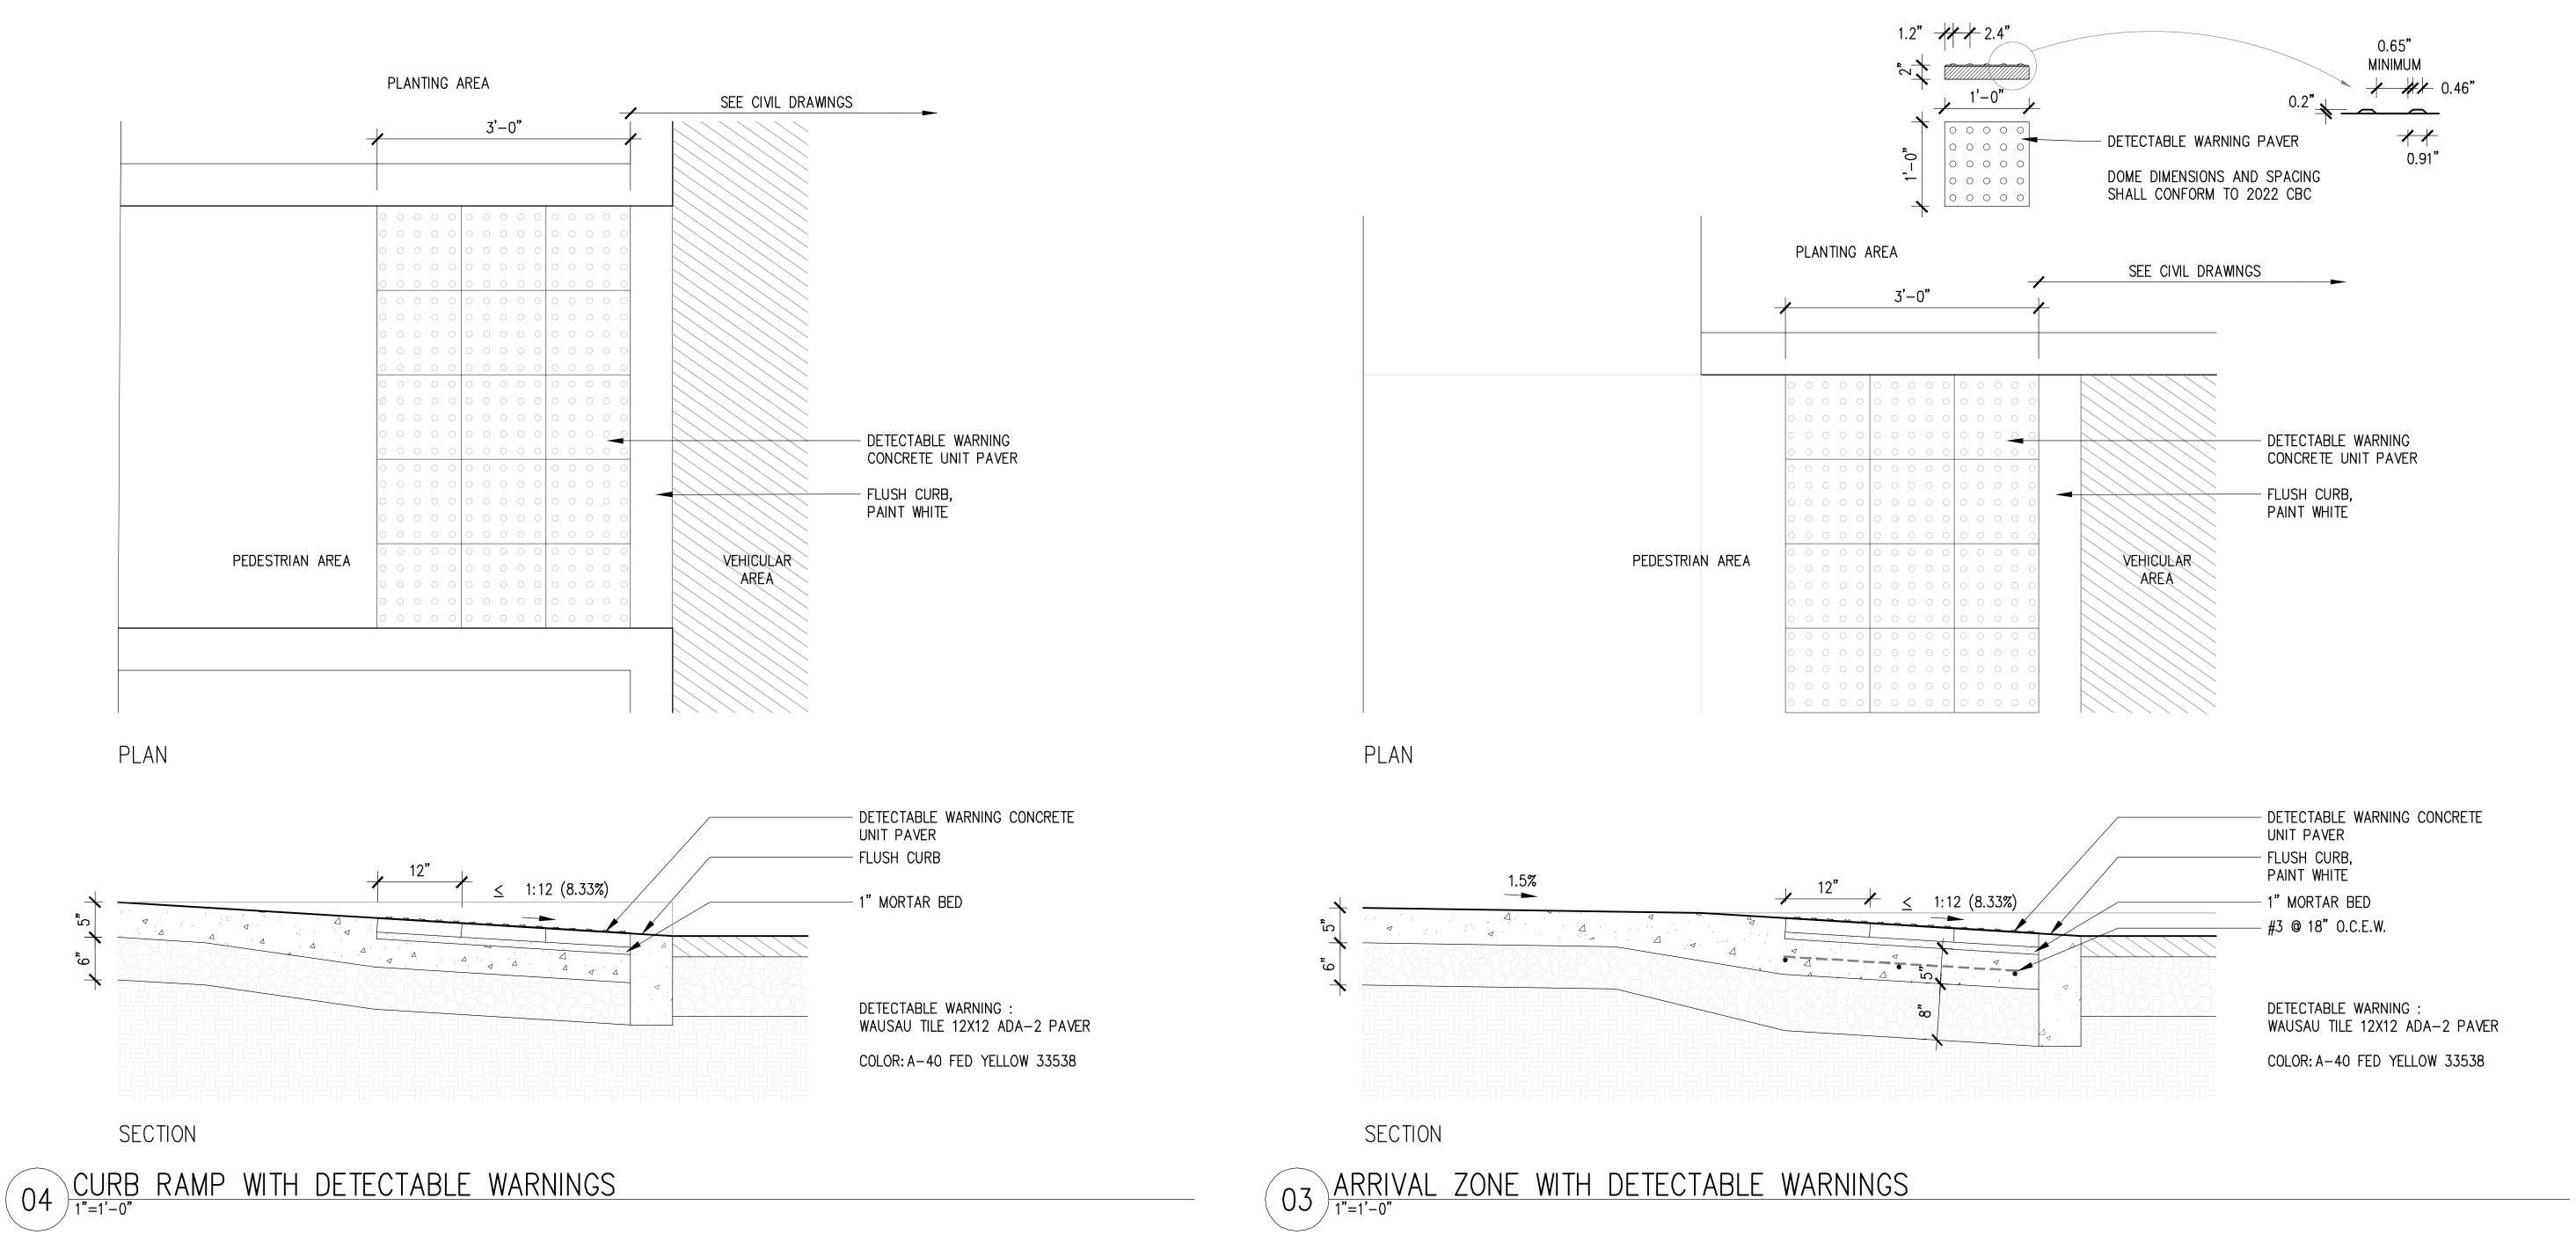
L4.02



NOTE: PAVING SECTIONS ARE BASED ON GEOTECH REPORT

BY NINYO & MOORE, DATED MAY 9, 2024

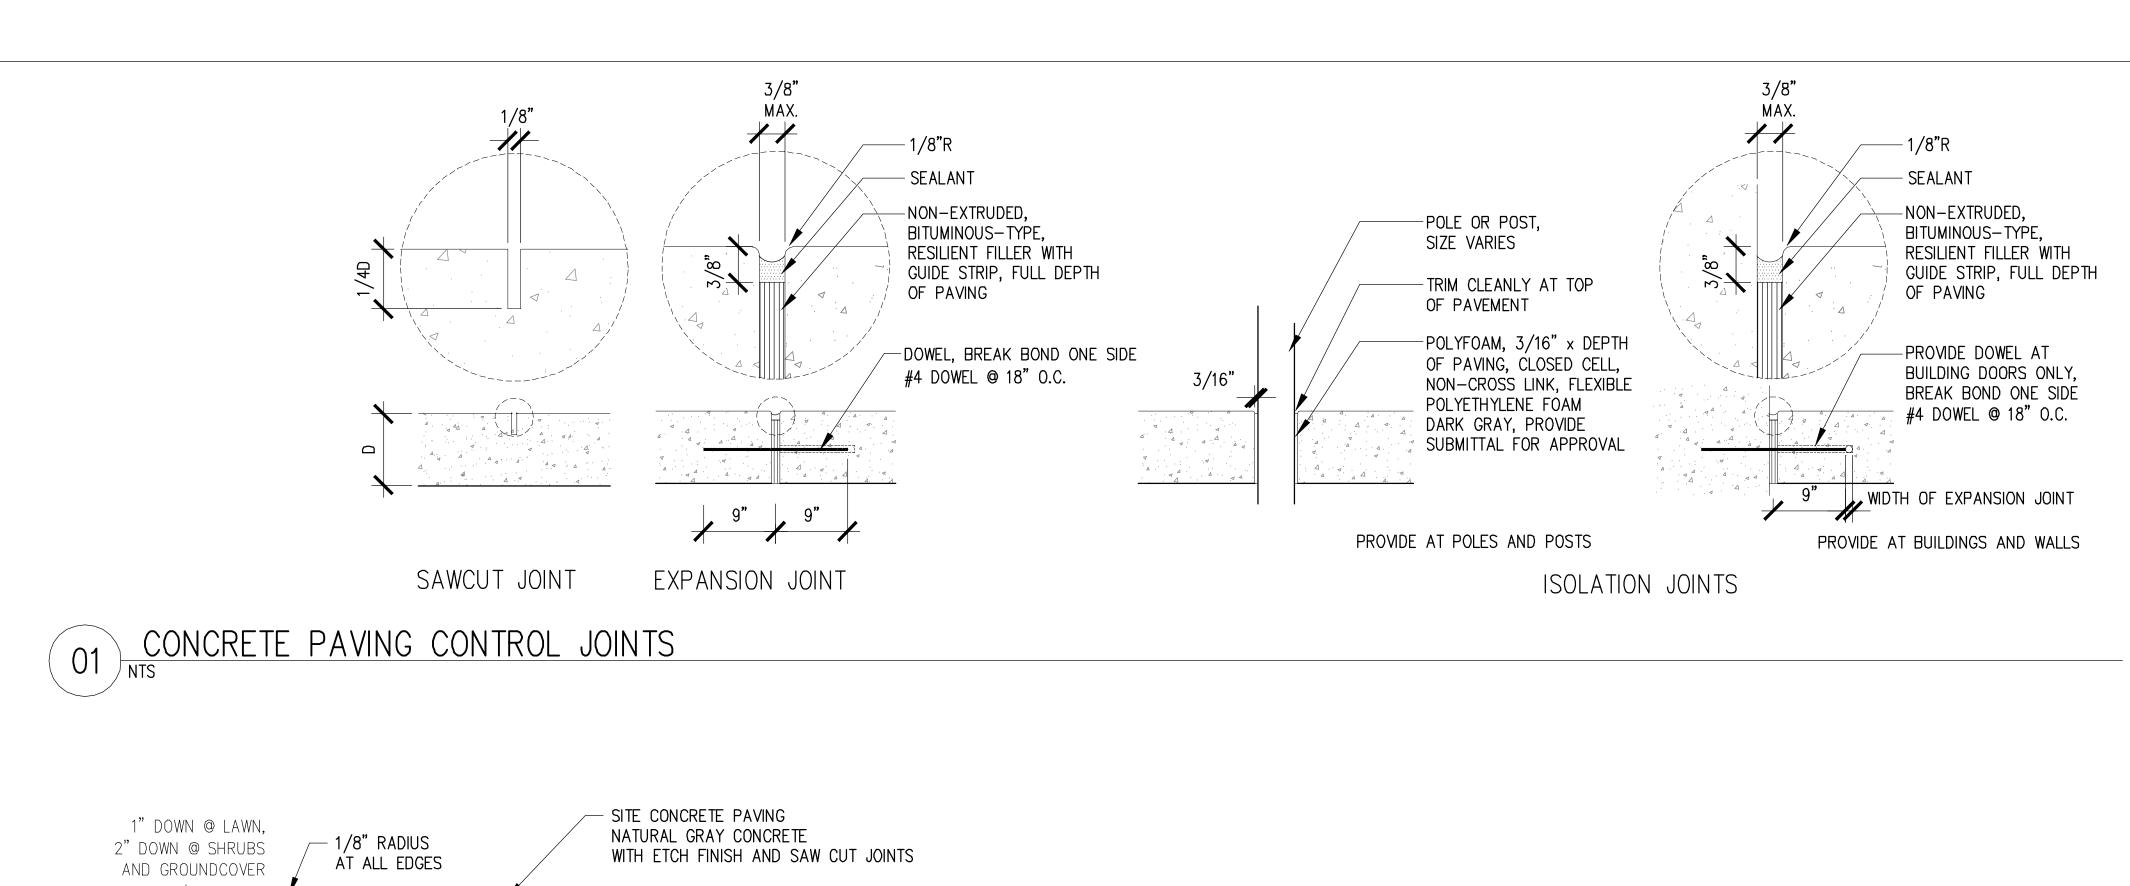O2 CONCRETE PAVINO



COMPACTED CLASS II AGGREGATE BASE

95% COMPACTION

COMPACTED SUBGRADE

els architecture+ urban design PROJECT: **ALAMEDA AQUATIC CENTER 800 ATLANTIC AVENUE** ALAMEDA, CA 94501 PROJECT NUMBER: 202407 CITY OF ALAMEDA **RECREATION AND PARK DEPARTMENT** 2226 SANTA CLARA AVENUE ALAMEDA, CA 94501 PROJECT TEAM: ARCHITECT: ELS ARCHITECTURE AND URBAN DESIGN 2040 Addison Street Berkeley, CA 94704 P: 510.549.2929 **CIVIL ENGINEER: BKF ENGINEERS** 1646 N. California Blvd, Suite 400 Walnut Creek, CA 94596 P: 925.940.2200 LANDSCAPE ARCHITECT: 2200 Bridgeway Sausalito, CA 94965 P: 415.332.5100 STRUCTURAL ENGINEER: FORELL/ELSESSER ENGINEERS, INC. 160 Pine Street, 6th Floor San Francisco, CA 94111 P: 415.837.0700 MEP / FIRE PROTECTION: **GUTTMANN & BLAEVOET** 1620 Montgomery Street, Suite 230 San Francisco, CA 94111 P: 415.655.4000 **AQUATICS:** AQUATICS DESIGN GROUP 2226 Faraday Avenue Carlsbad, CA 92008 P: 760.438.8400 SPECIFICATIONS: SPECIFICATIONS WEST 1975 E. Buck Ridge Place Tucson, AZ 85737 P: 800.646.3820 NUMBER DATE DESCRIPTION

KEY PLAN:

Scale

North

Description

Scale

PLANNING
RESUBMITTAL 5

DATE:

JUNE 9, 2025

STAMP:


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CONSTRUCTION

SHEET TITLE:

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PAVING


DETAILS

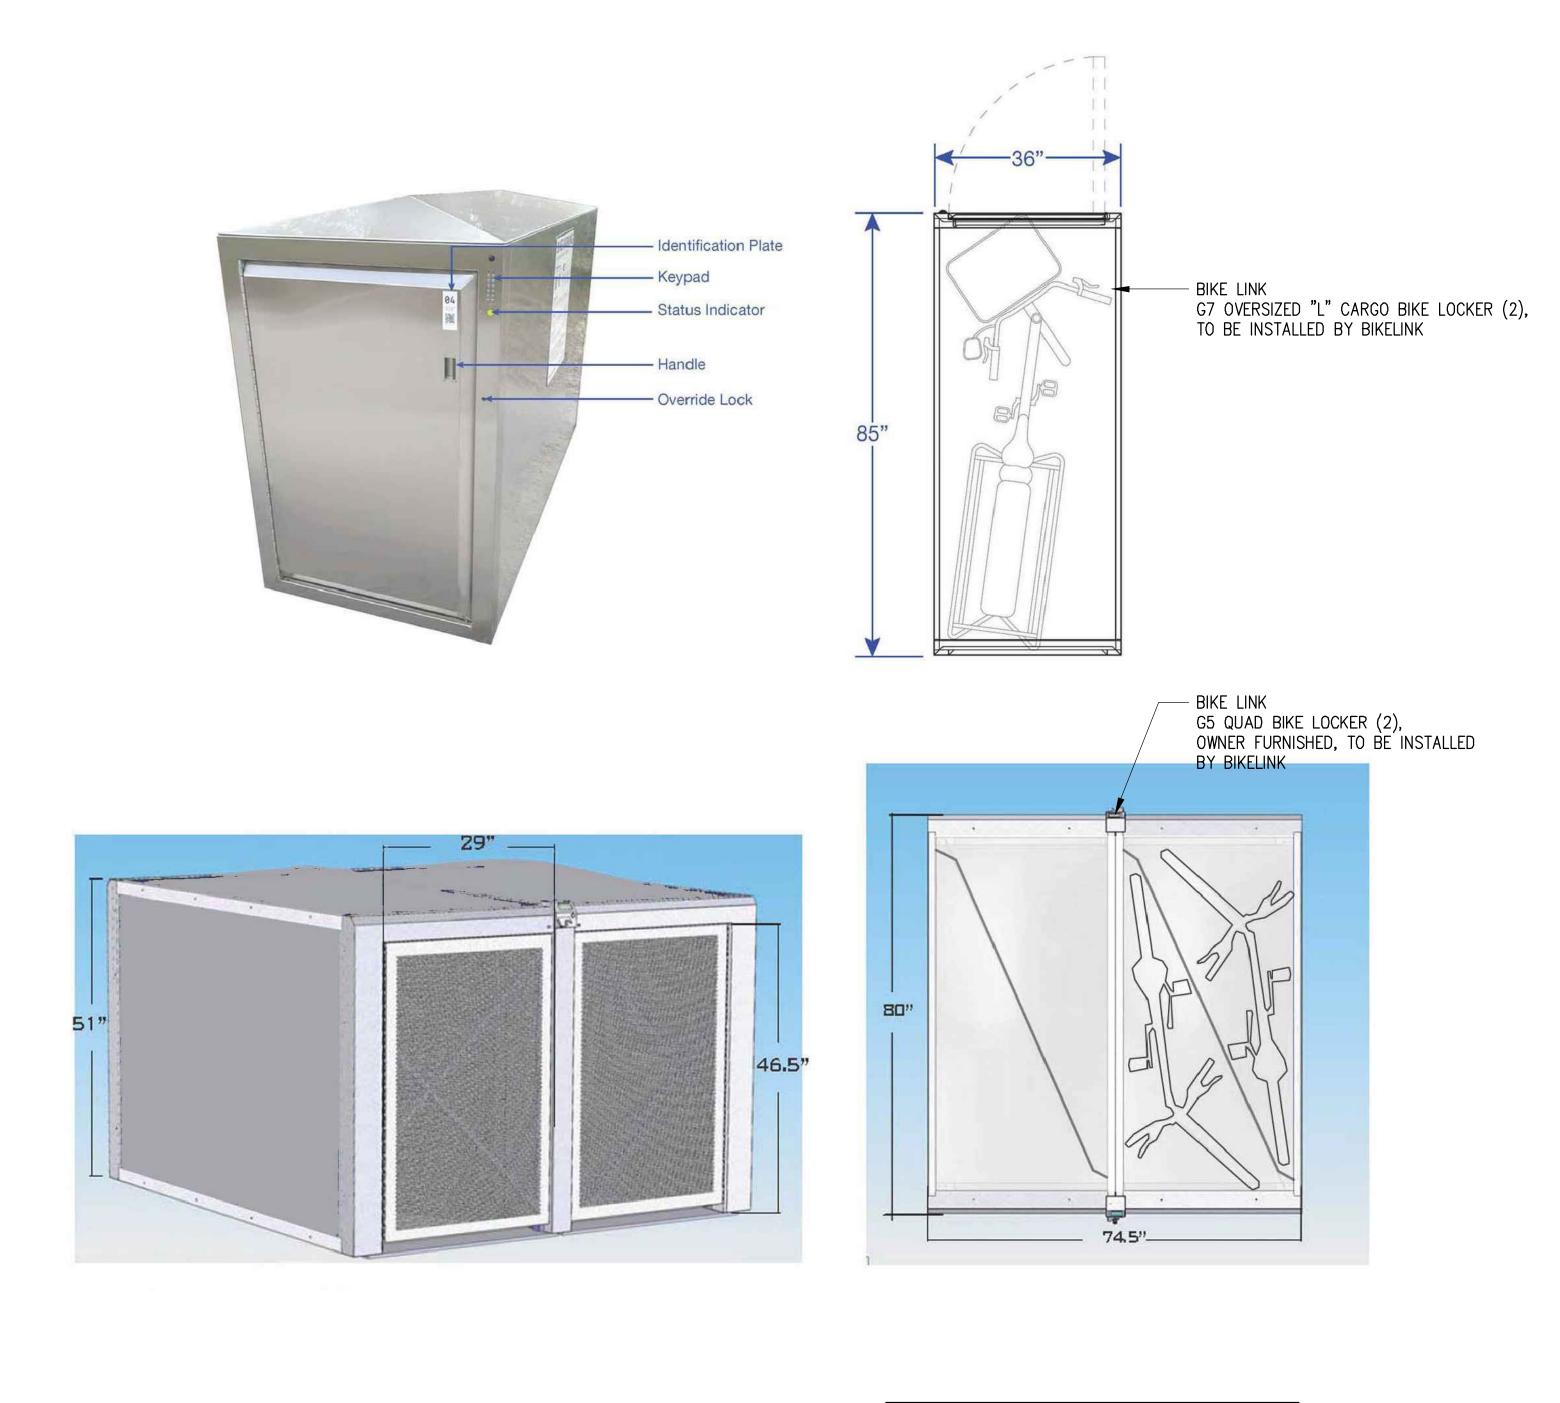

NOTE: G7 LOCKERS ARE CITY OWNED LOCKERS TO BE RELOCATED TO THE SITE. G5 LOCKERS ARE NEW. ALL LOCKERS TO BE INSTALLED BY BIKELINK


02 BIKE LOCKERS



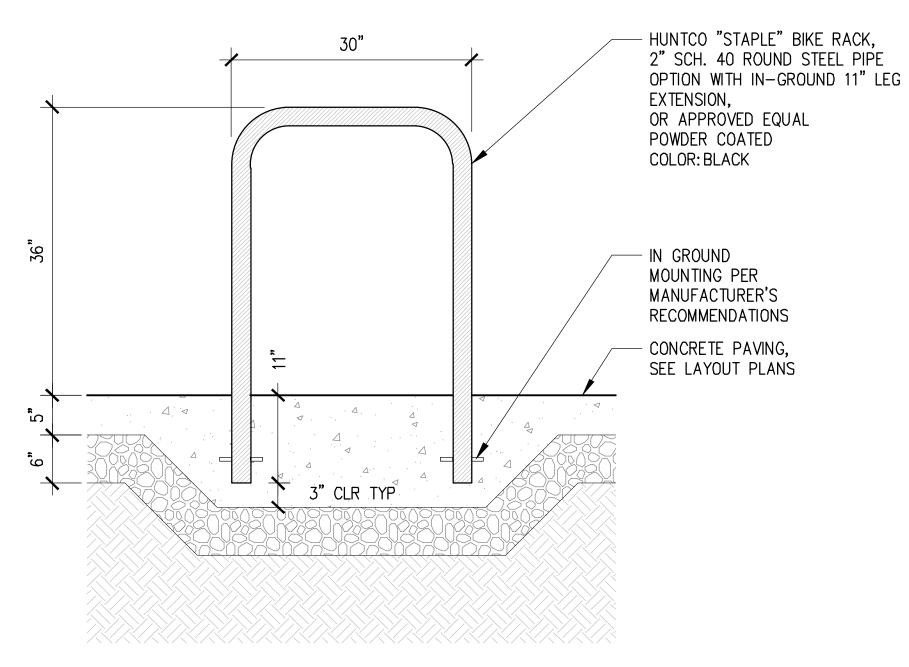

SECTION



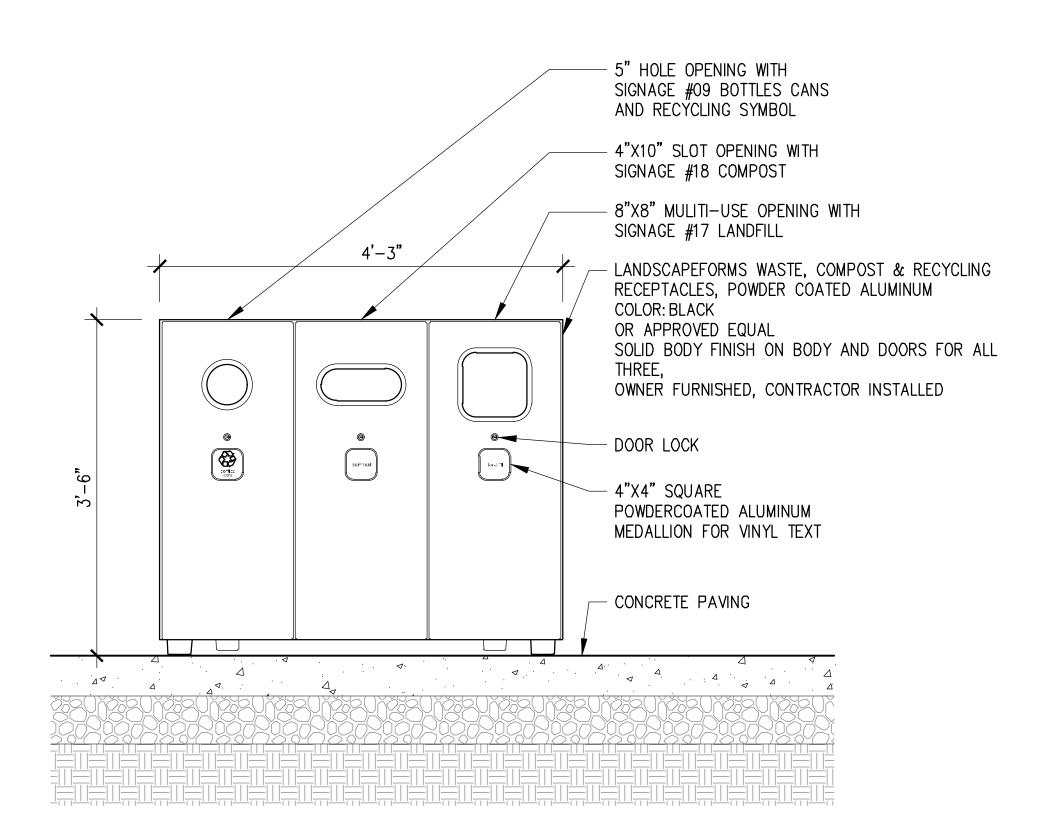

03 TRASH RECEPTACLE —— OFCI

els architecture+ urban design

PROJECT:

ALAMEDA AQUATIC CENTER

800 ATLANTIC AVENUE ALAMEDA, CA 94501

PROJECT NUMBER: 202407

LIENT:

CITY OF ALAMEDA

RECREATION AND PARK

DEPARTMENT
2226 SANTA CLARA AVENUE
ALAMEDA, CA 94501

PROJECT TEAM:

ARCHITECT: ELS ARCHITECTURE AND URBAN DESIGN 2040 Addison Street Berkeley, CA 94704 P: 510.549.2929

CIVIL ENGINEER:
BKF ENGINEERS

1646 N. California Blvd, Suite 400 Walnut Creek, CA 94596 P: 925.940.2200

LANDSCAPE ARCHITECT: SWA 2200 Bridgeway Sausalito, CA 94965

P: 415.332.5100

STRUCTURAL ENGINEER:
FORELL/ELSESSER ENGINEERS, INC.
160 Pine Street, 6th Floor
San Francisco, CA 94111

P: 415.837.0700

MEP / FIRE PROTECTION:
GUTTMANN & BLAEVOET
1620 Montgomery Street, Suite 230
San Francisco, CA 94111

P: 445.055.4000

P: 415.655.4000

AQUATICS:
AQUATICS DESIGN GROUP
2226 Faraday Avenue
Carlsbad, CA 92008

SPECIFICATIONS: SPECIFICATIONS WEST 1975 E. Buck Ridge Place Tucson, AZ 85737 P: 800.646.3820

P: 760.438.8400

REVISION:

NUMBER DATE DESCRIPTION

Scale

KEY PLAN:

PLANNING RESUBMITTAL 5

JUNE 9, 2025

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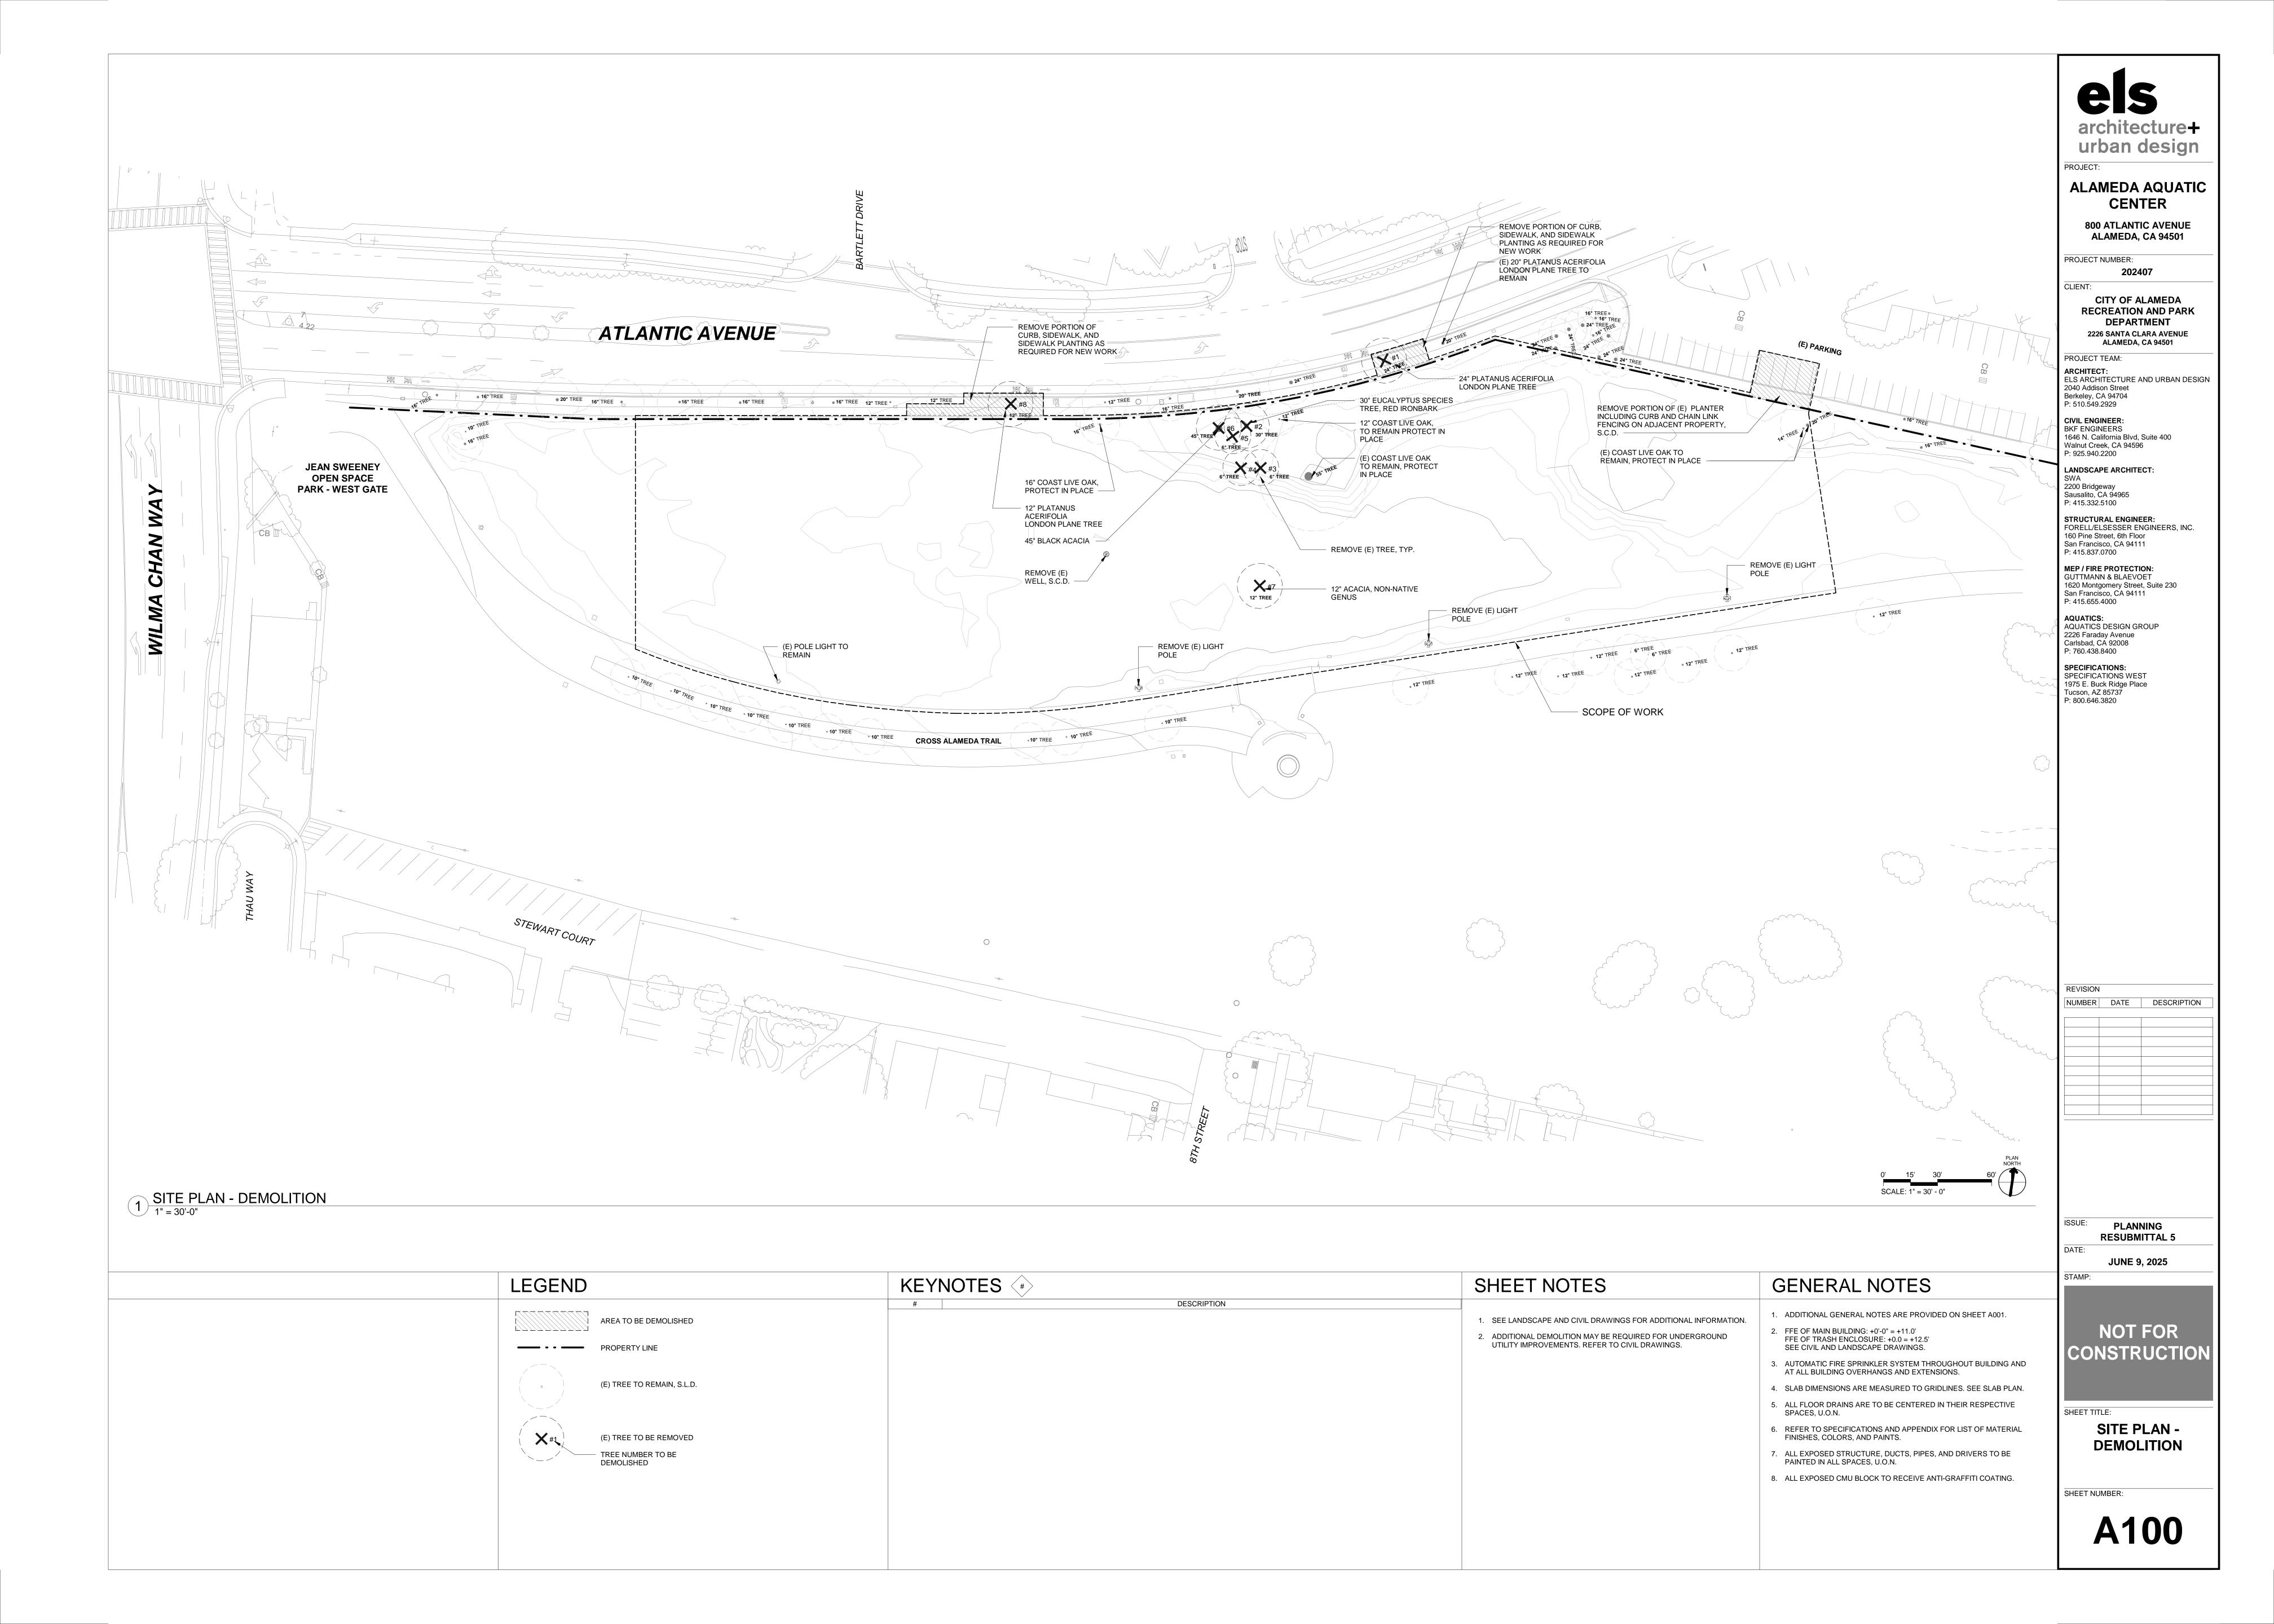
North


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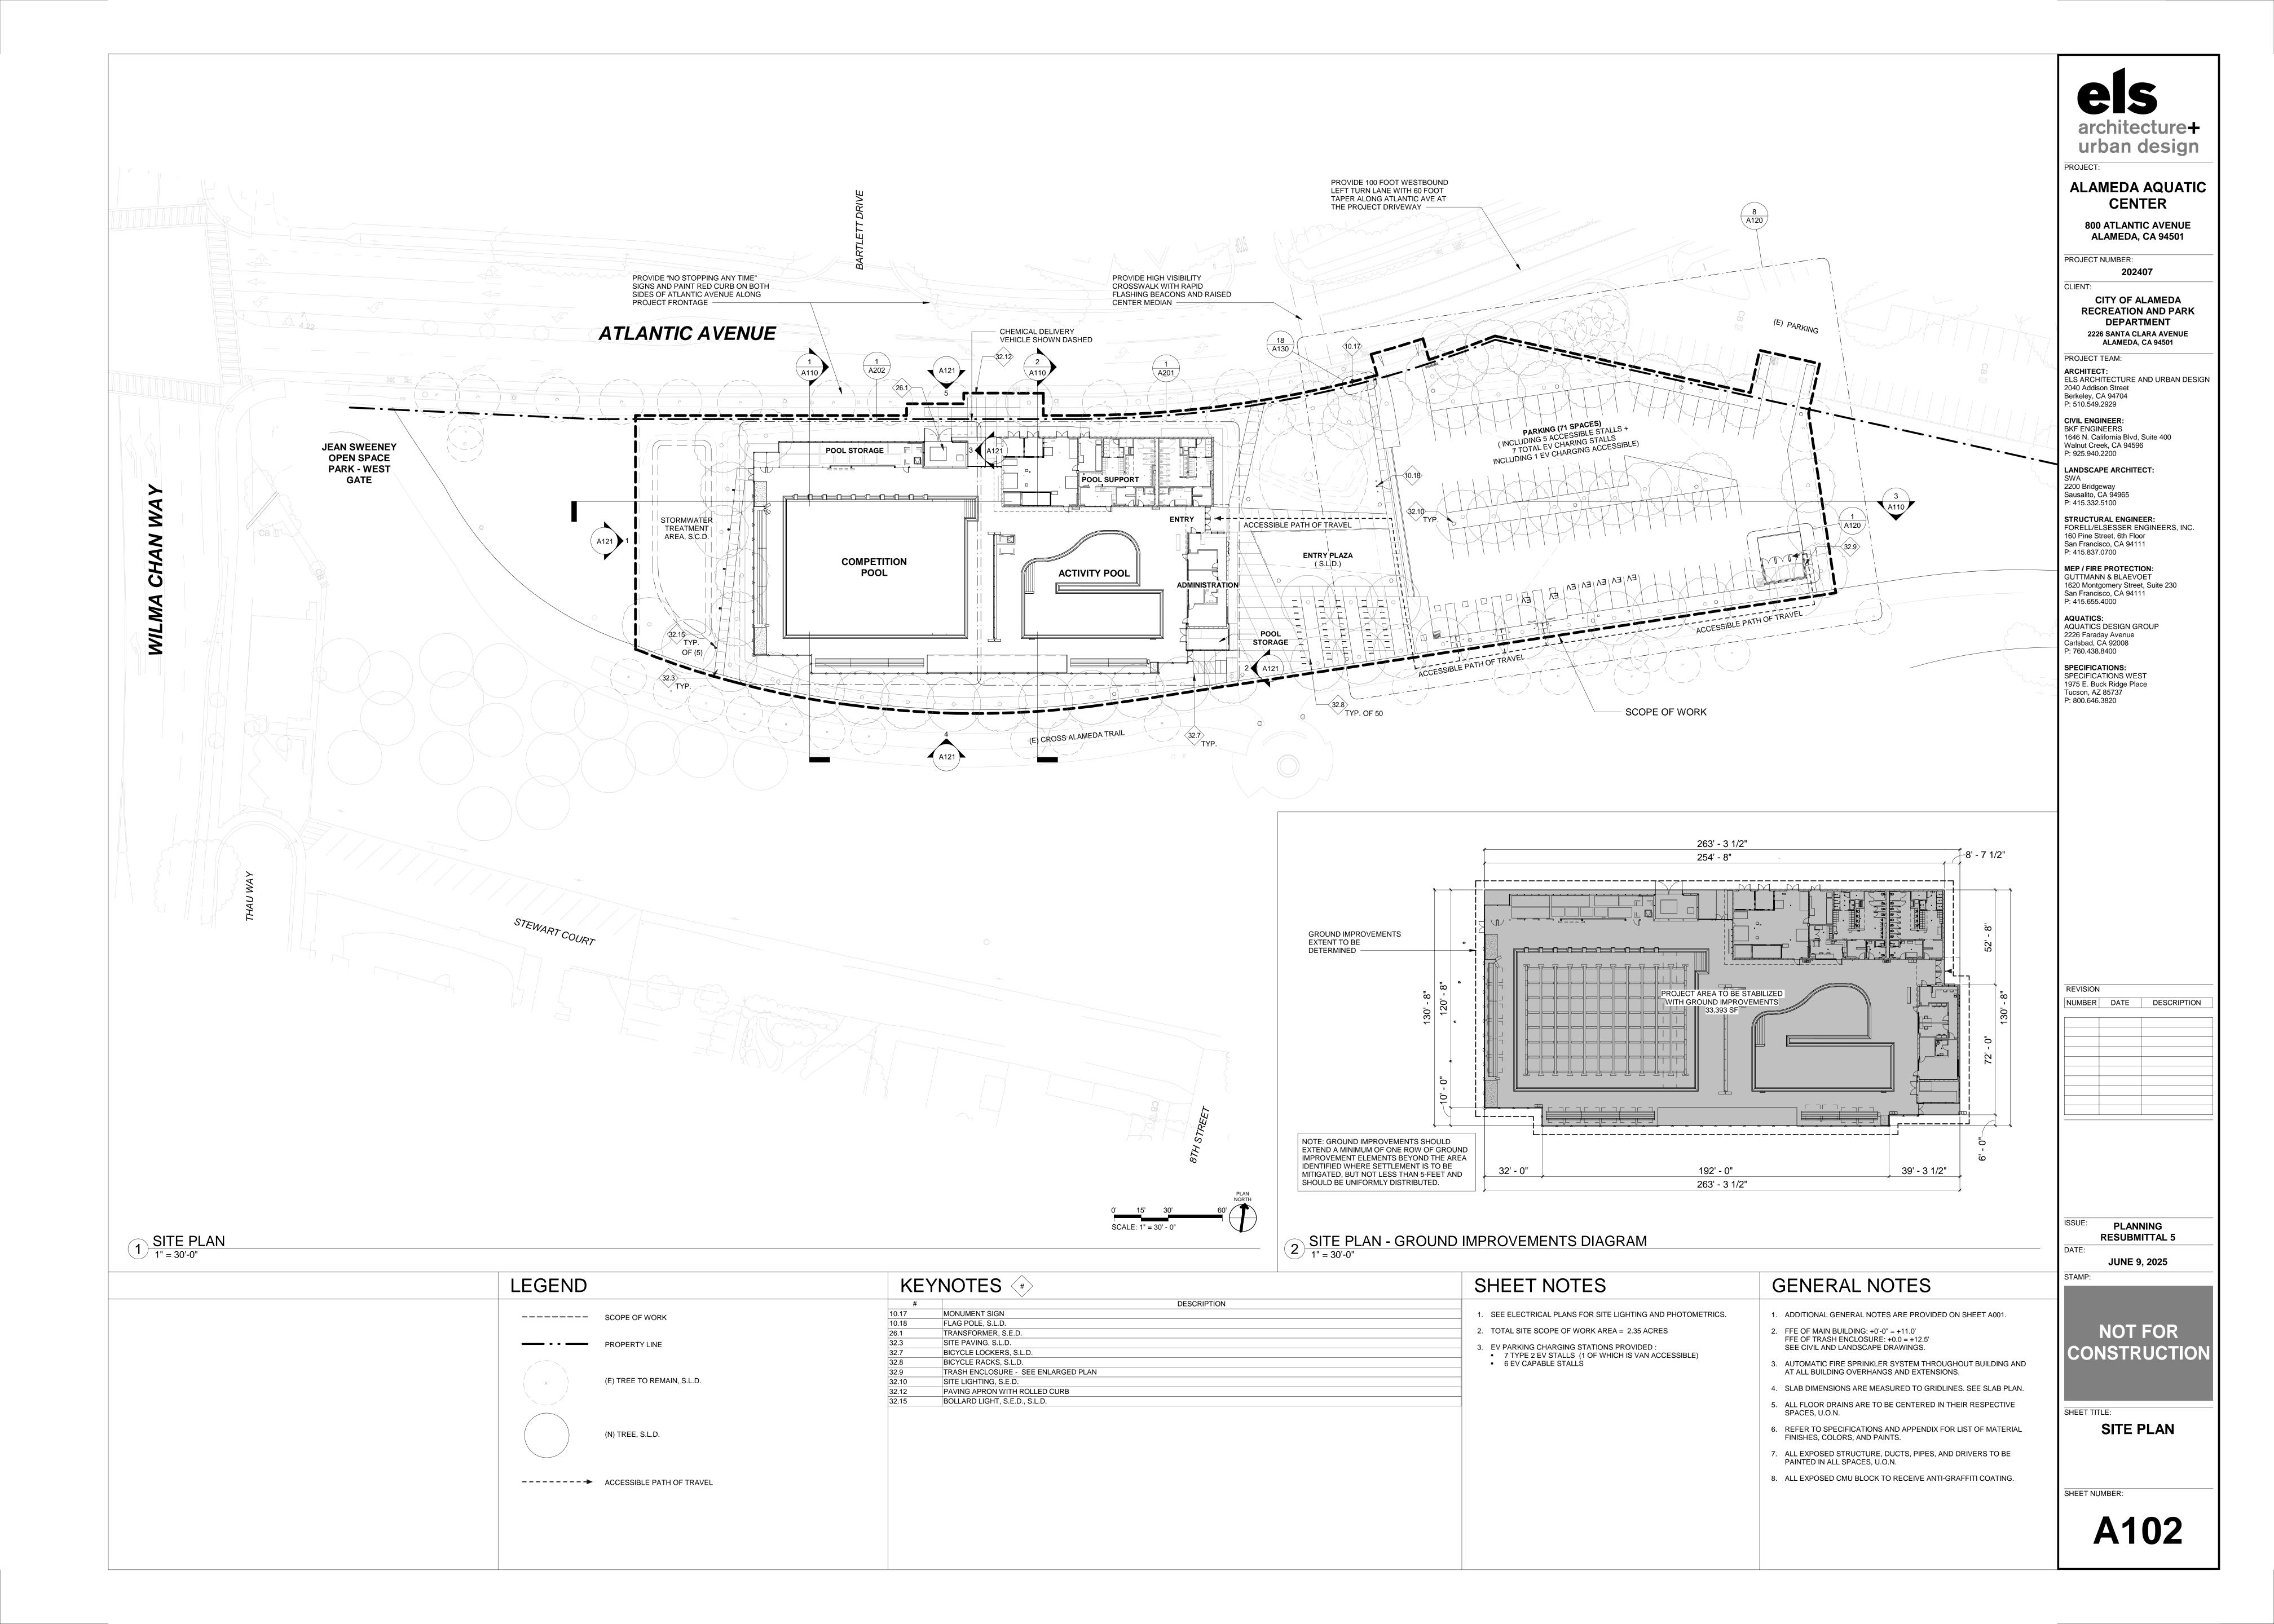
BIKE RACK & LOCKER DETAILS


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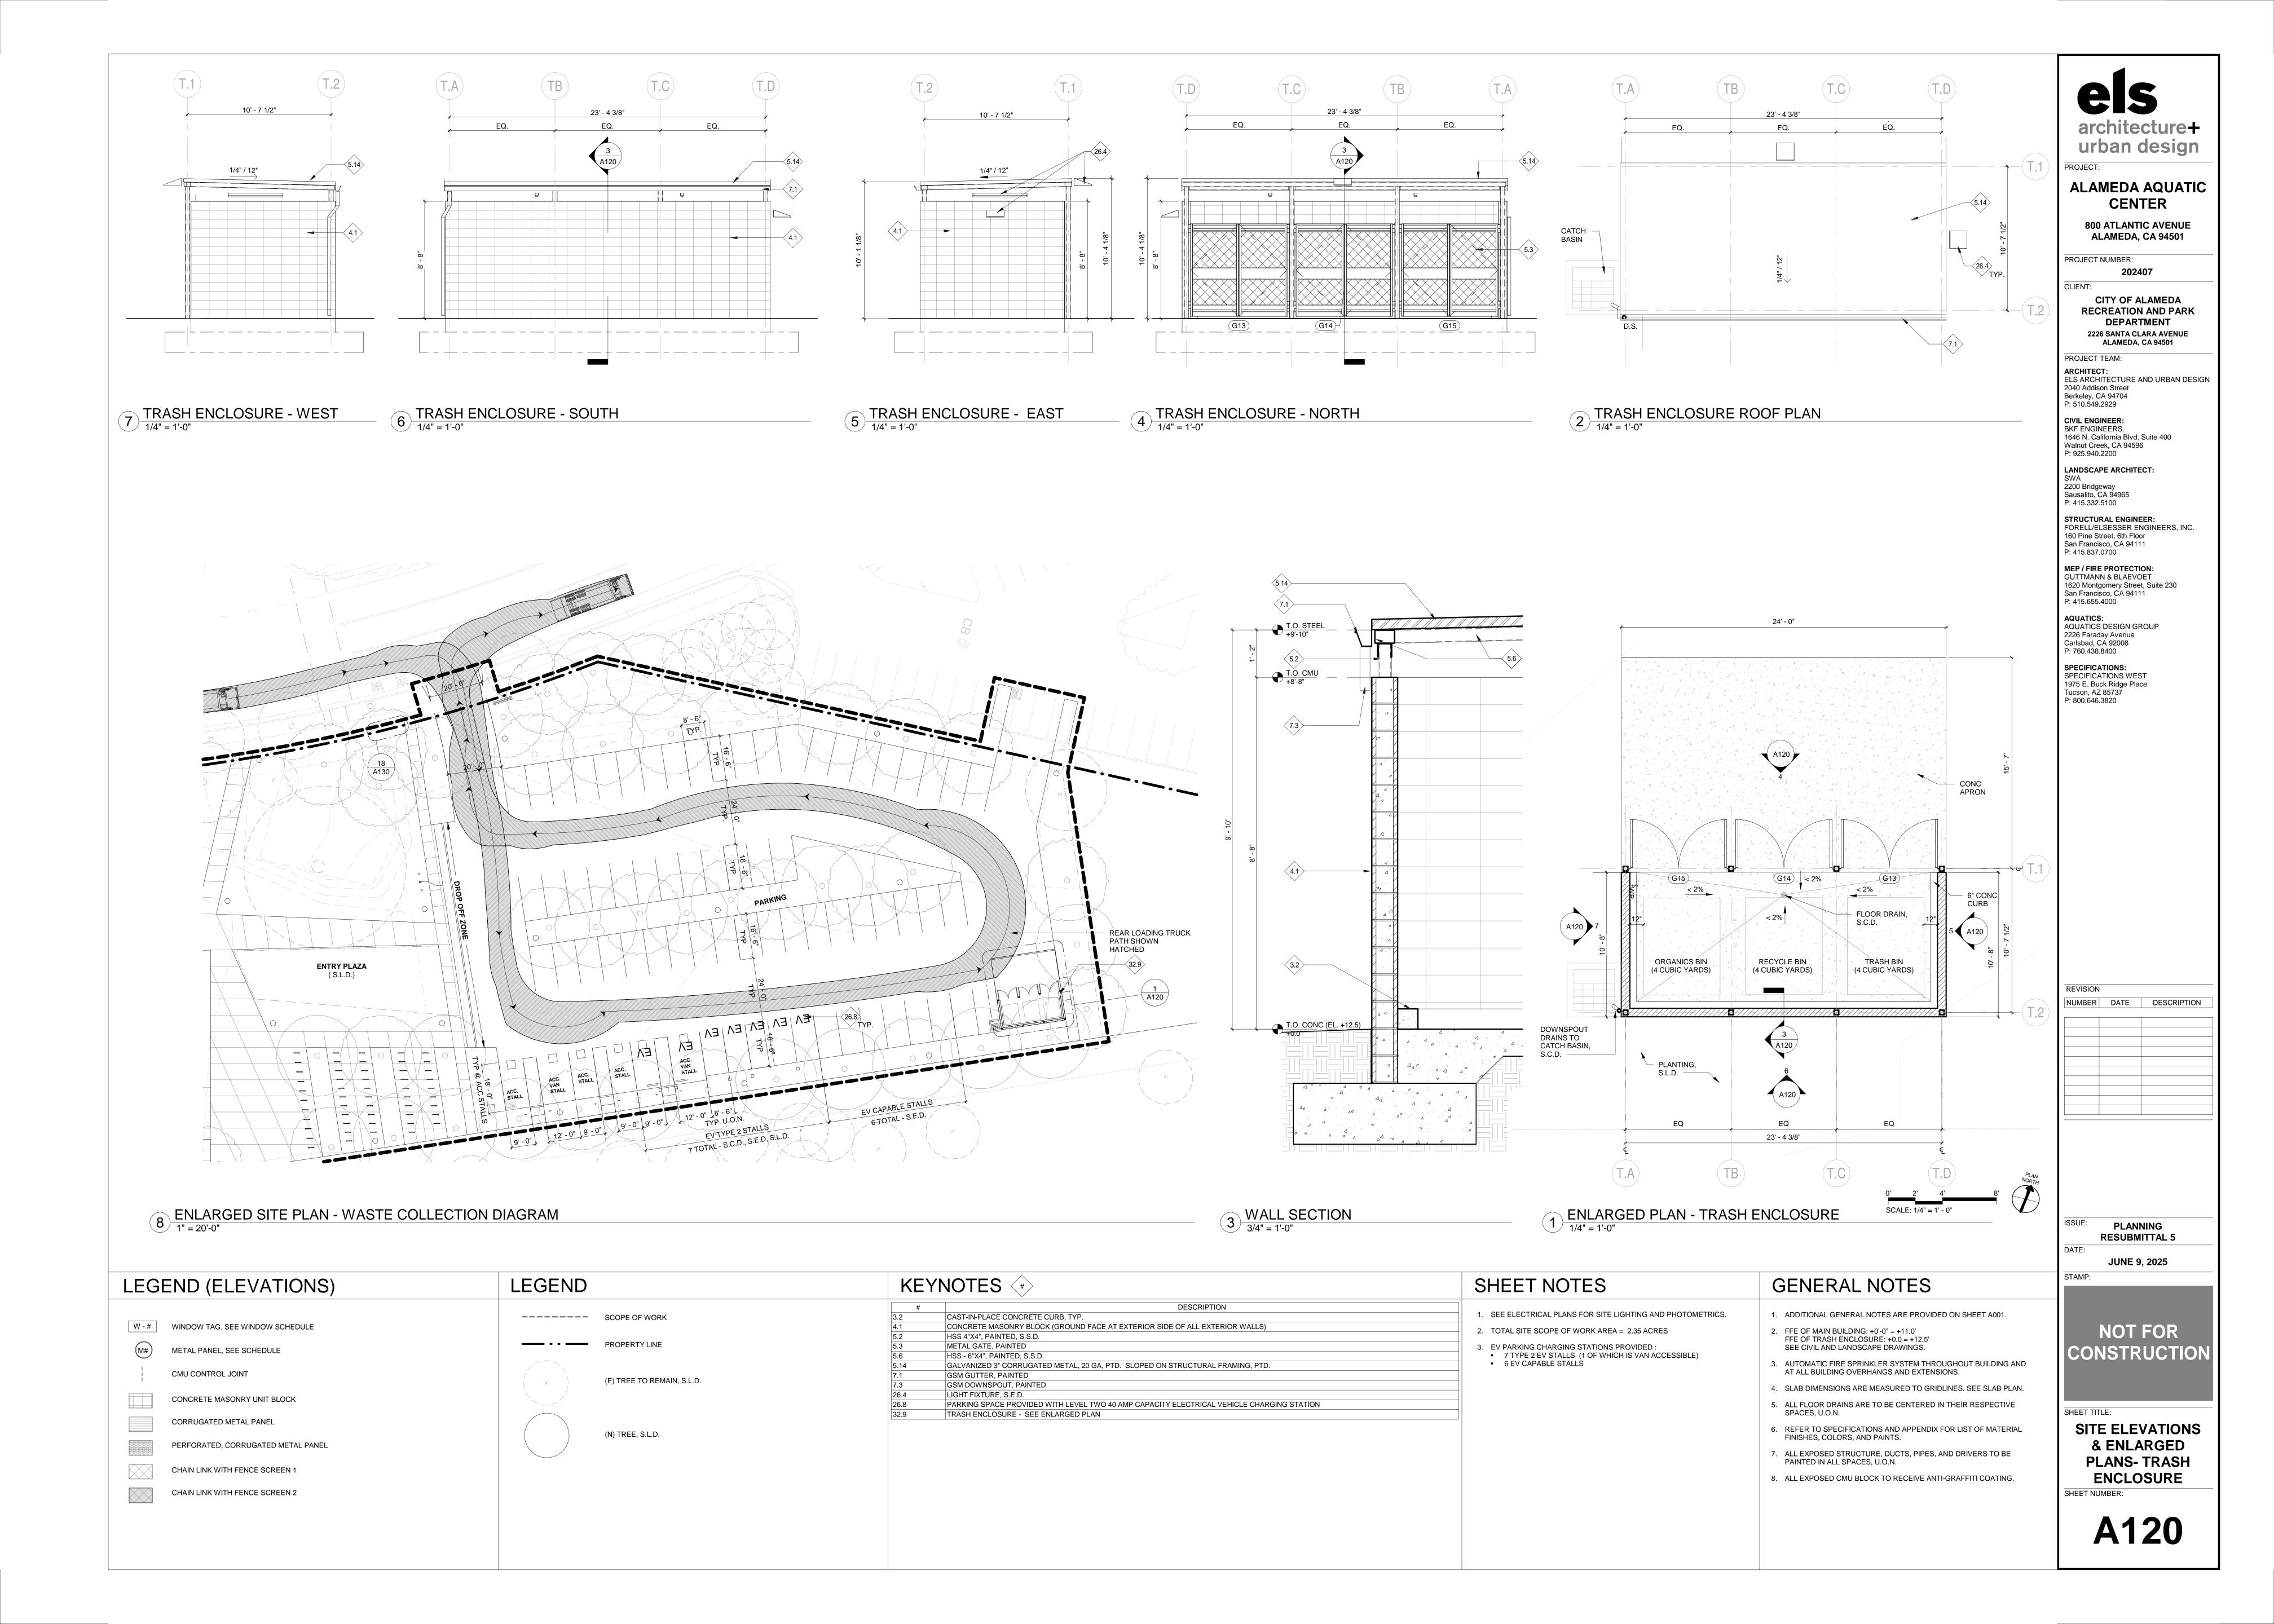
L5.02










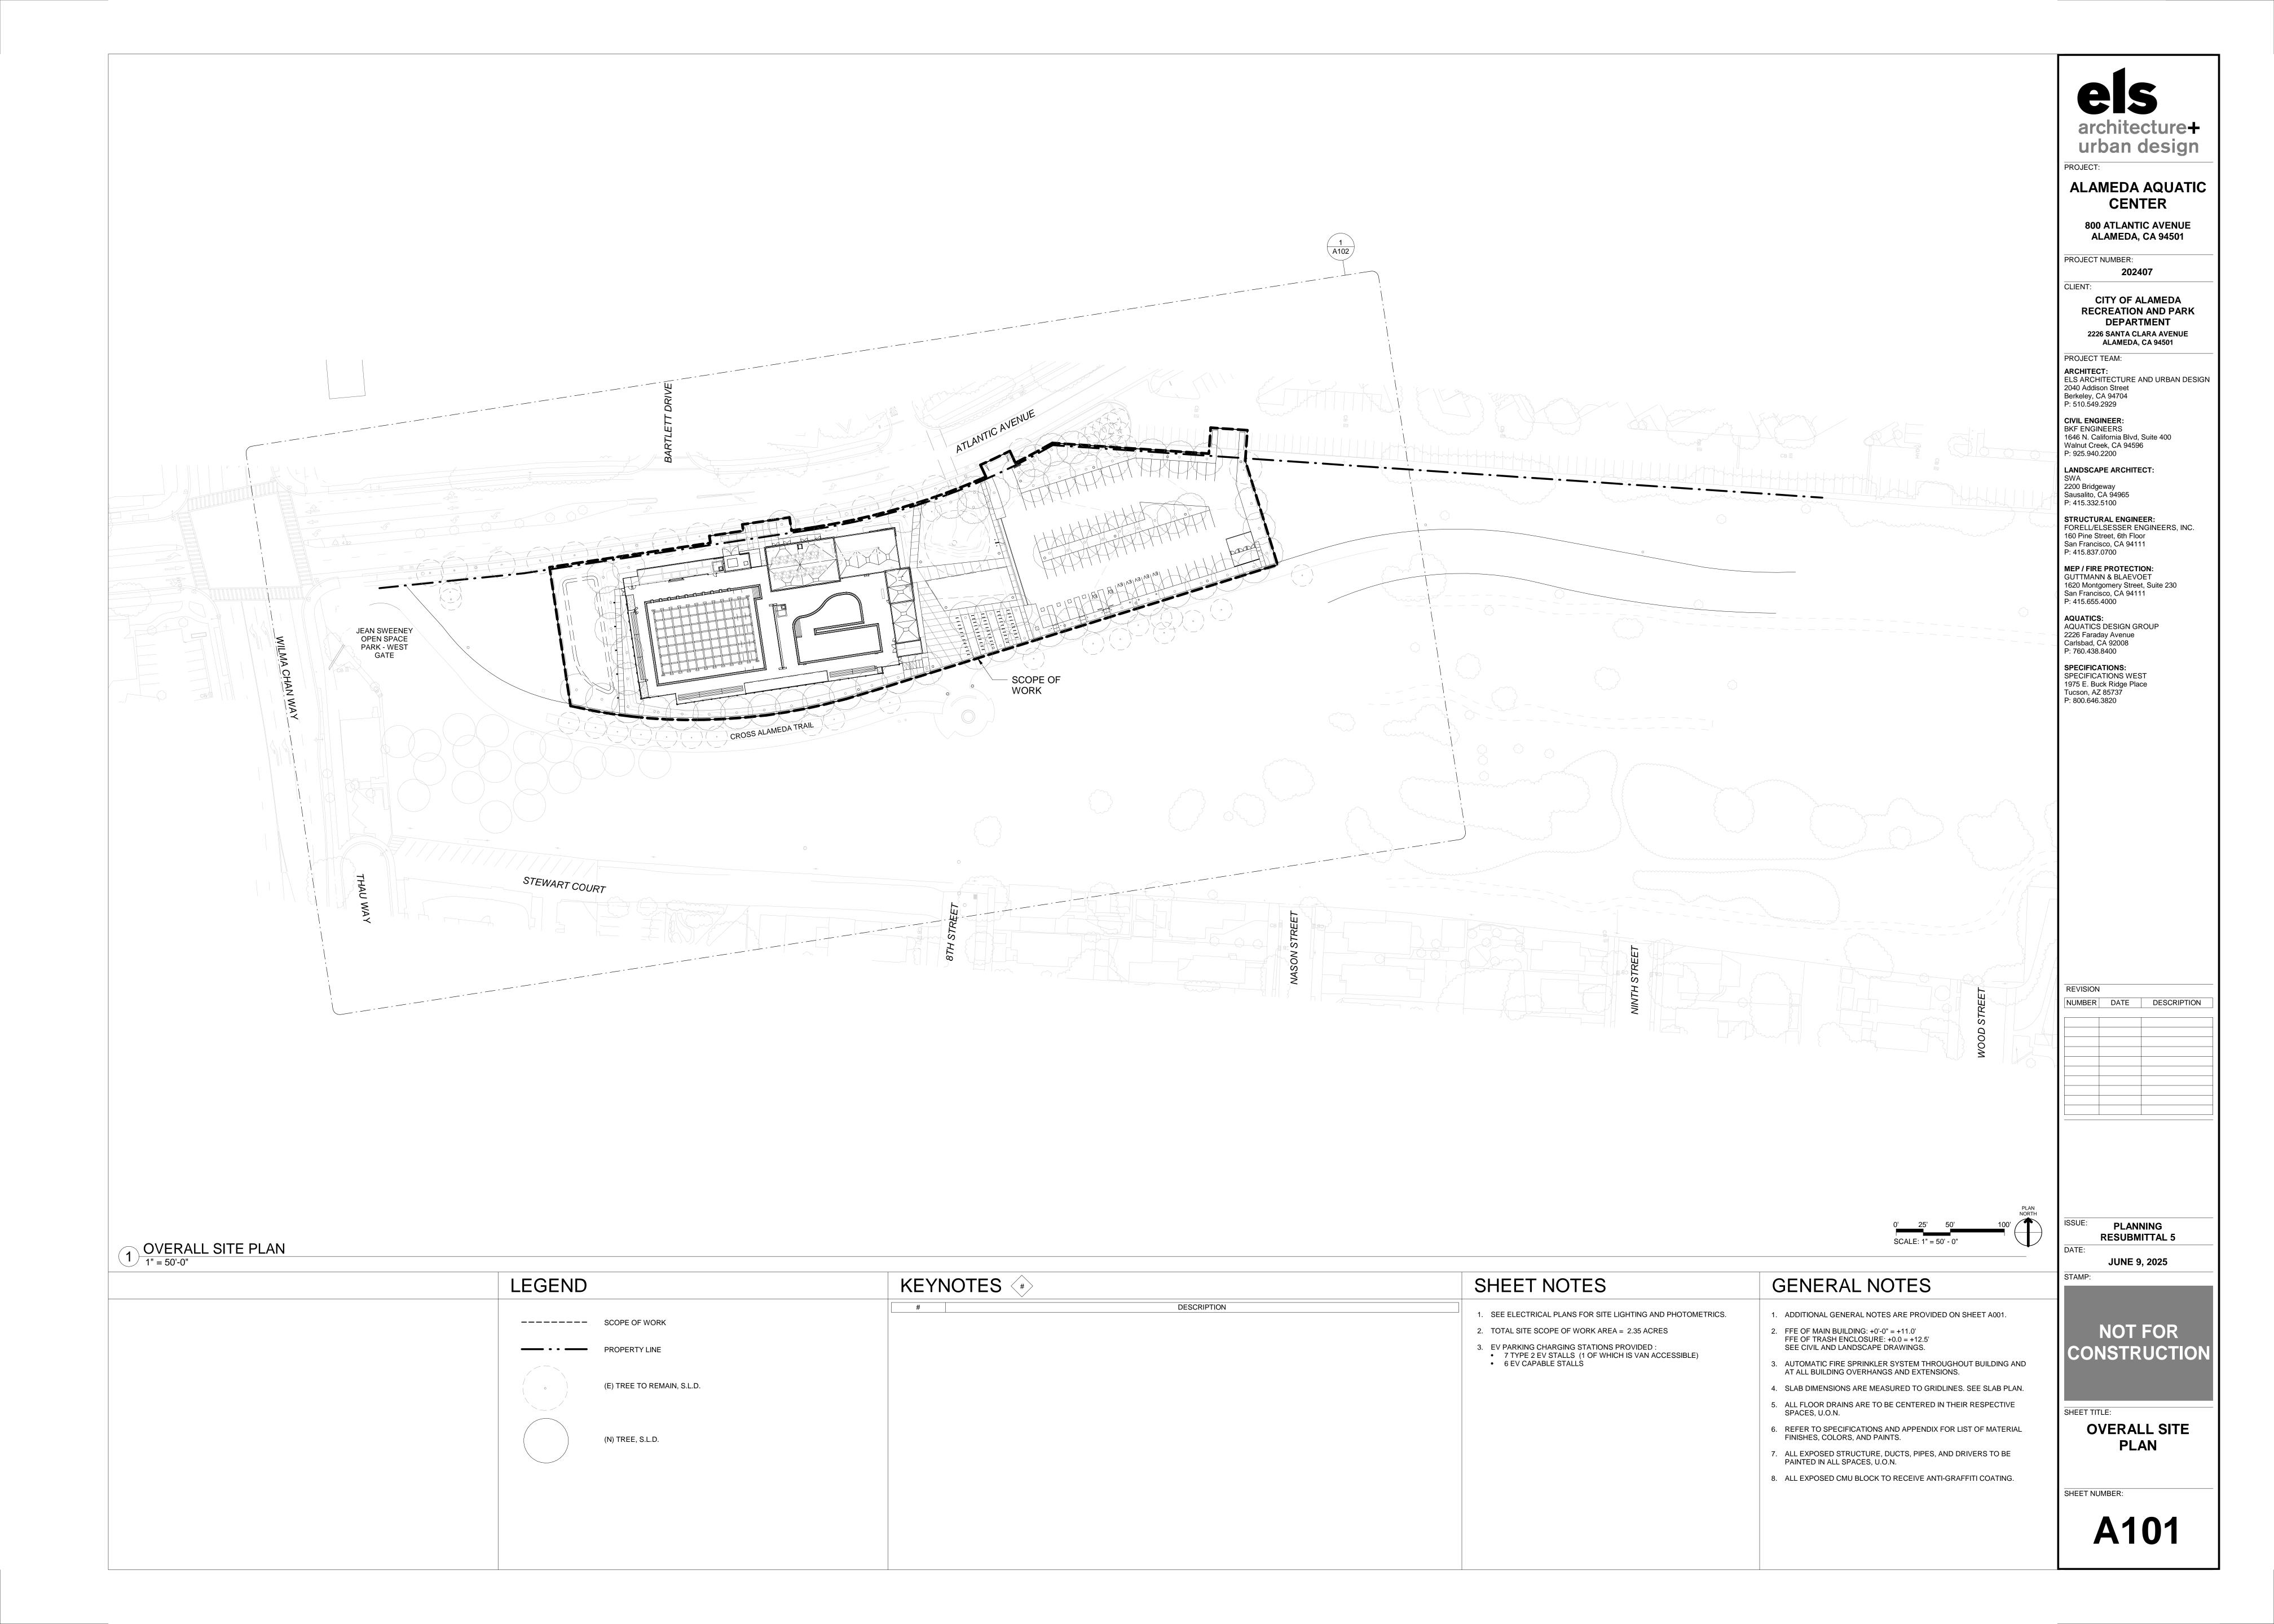

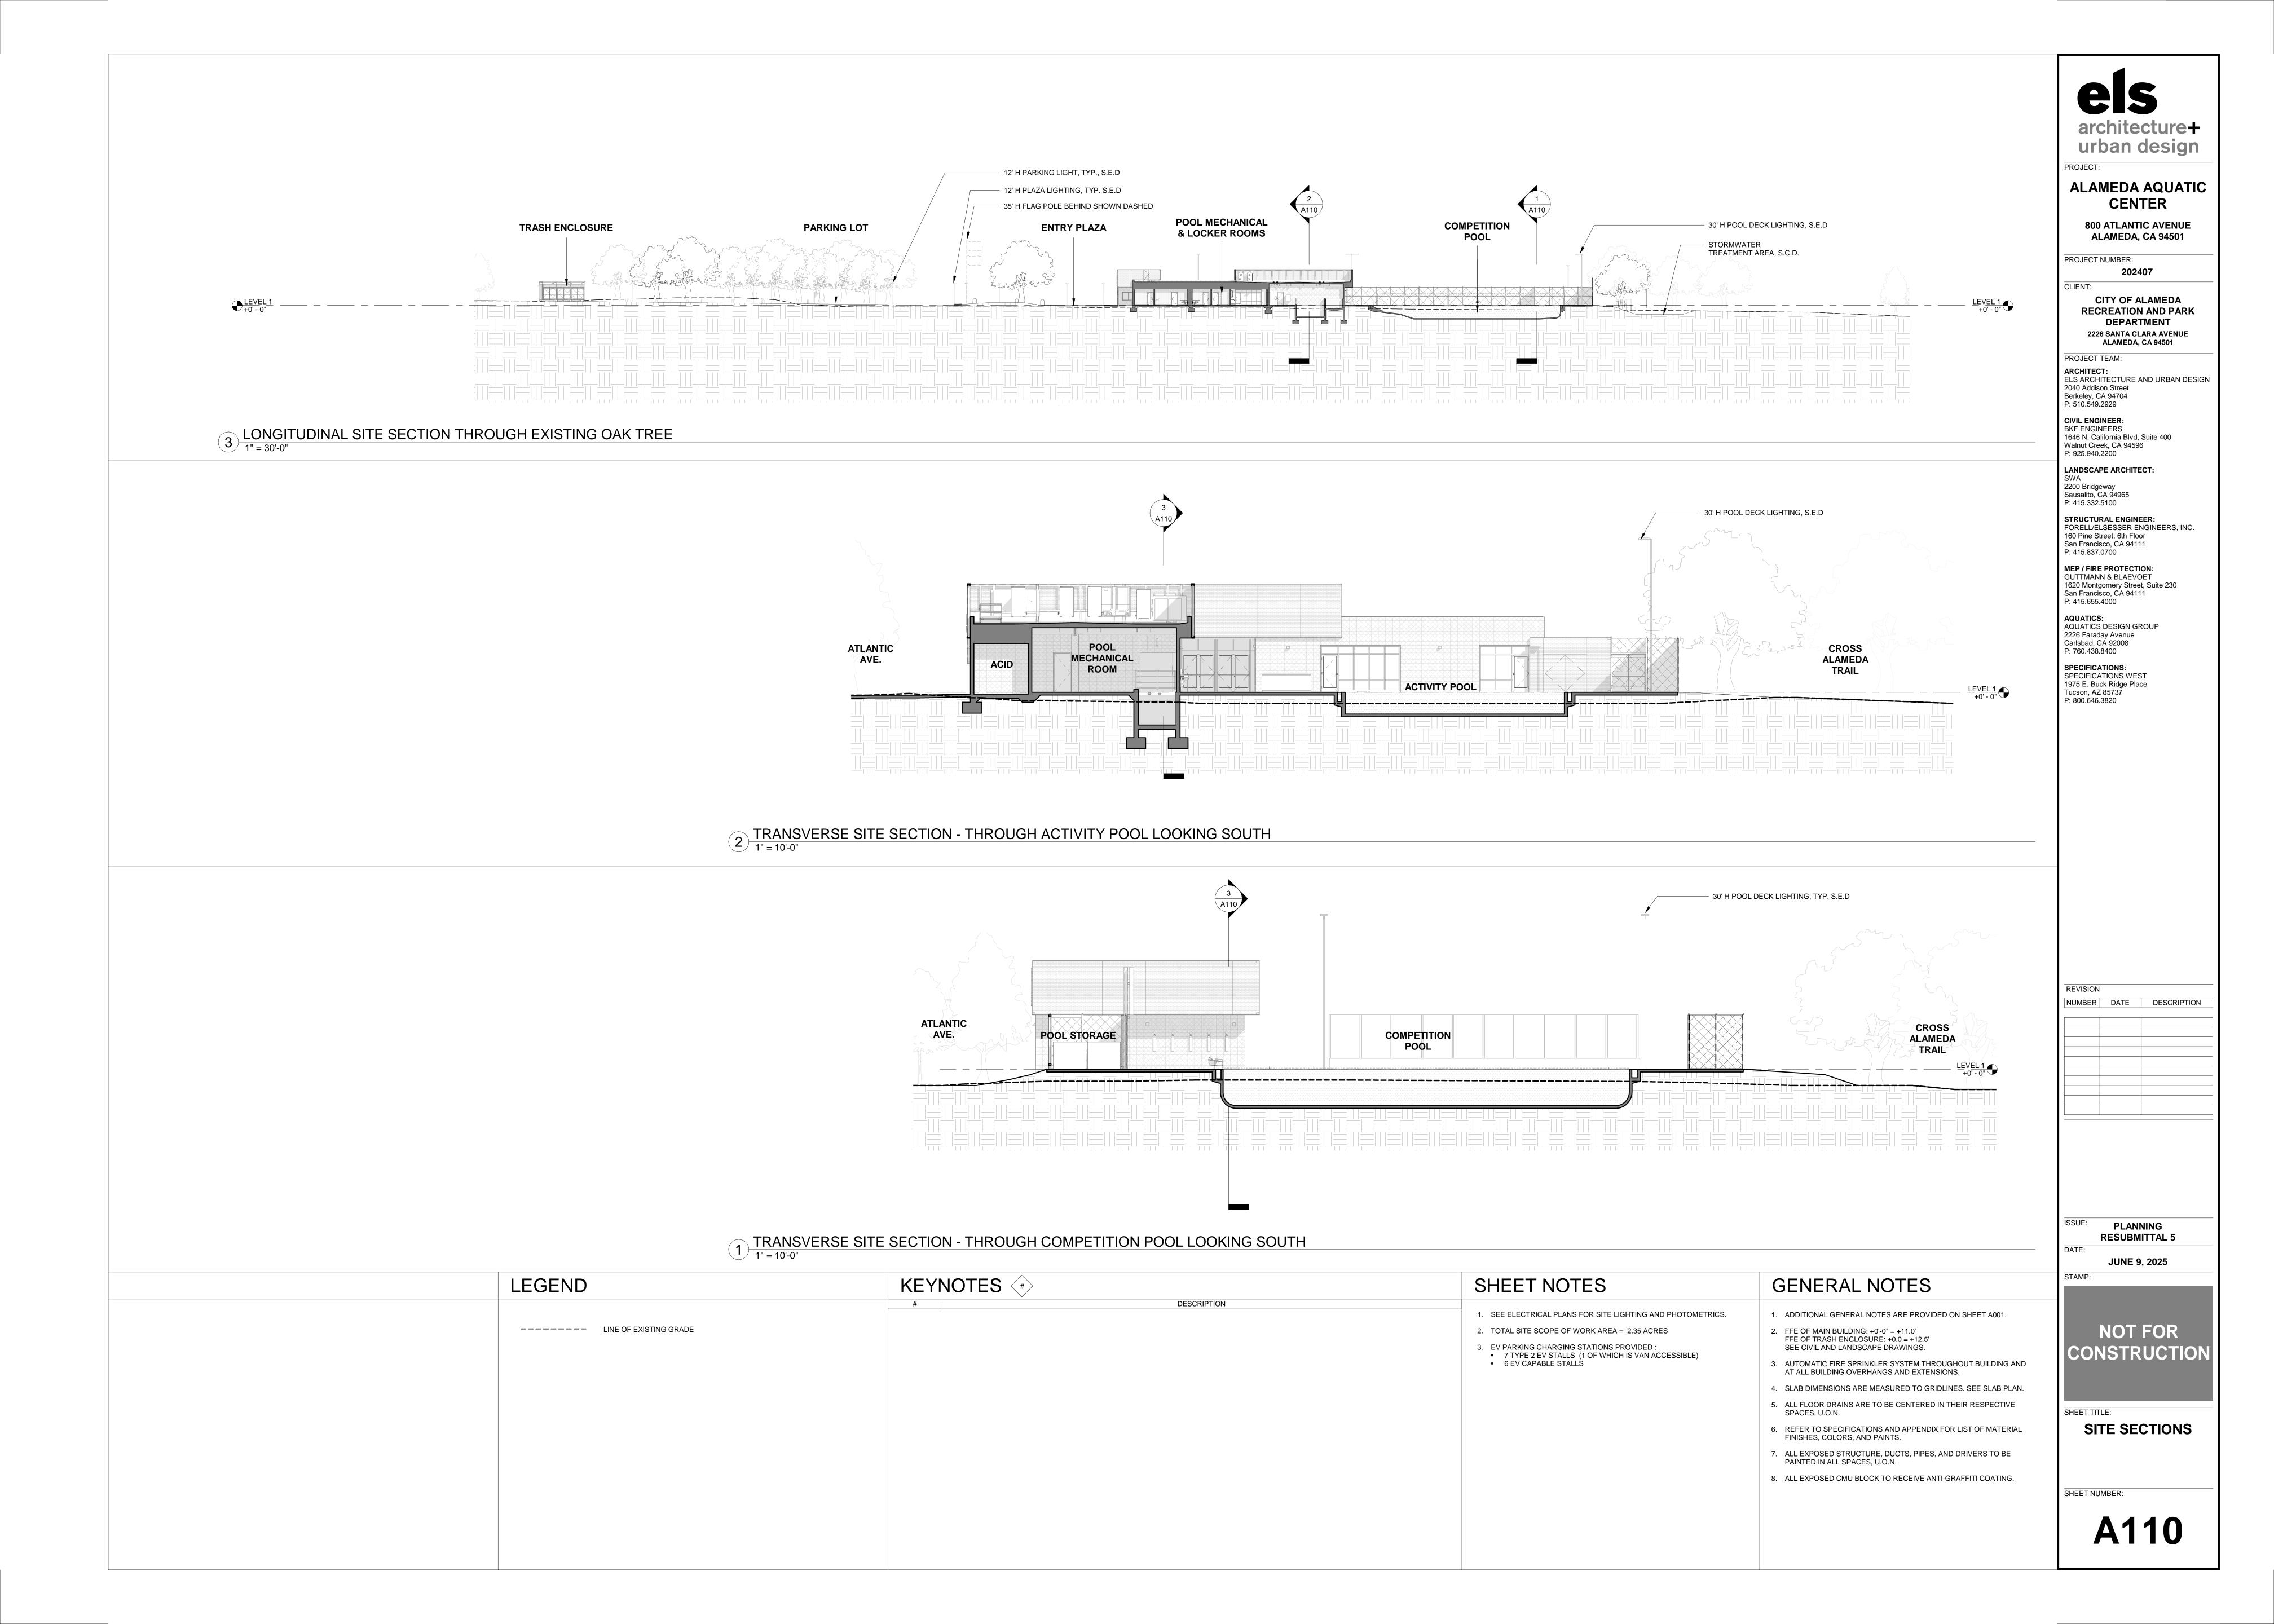


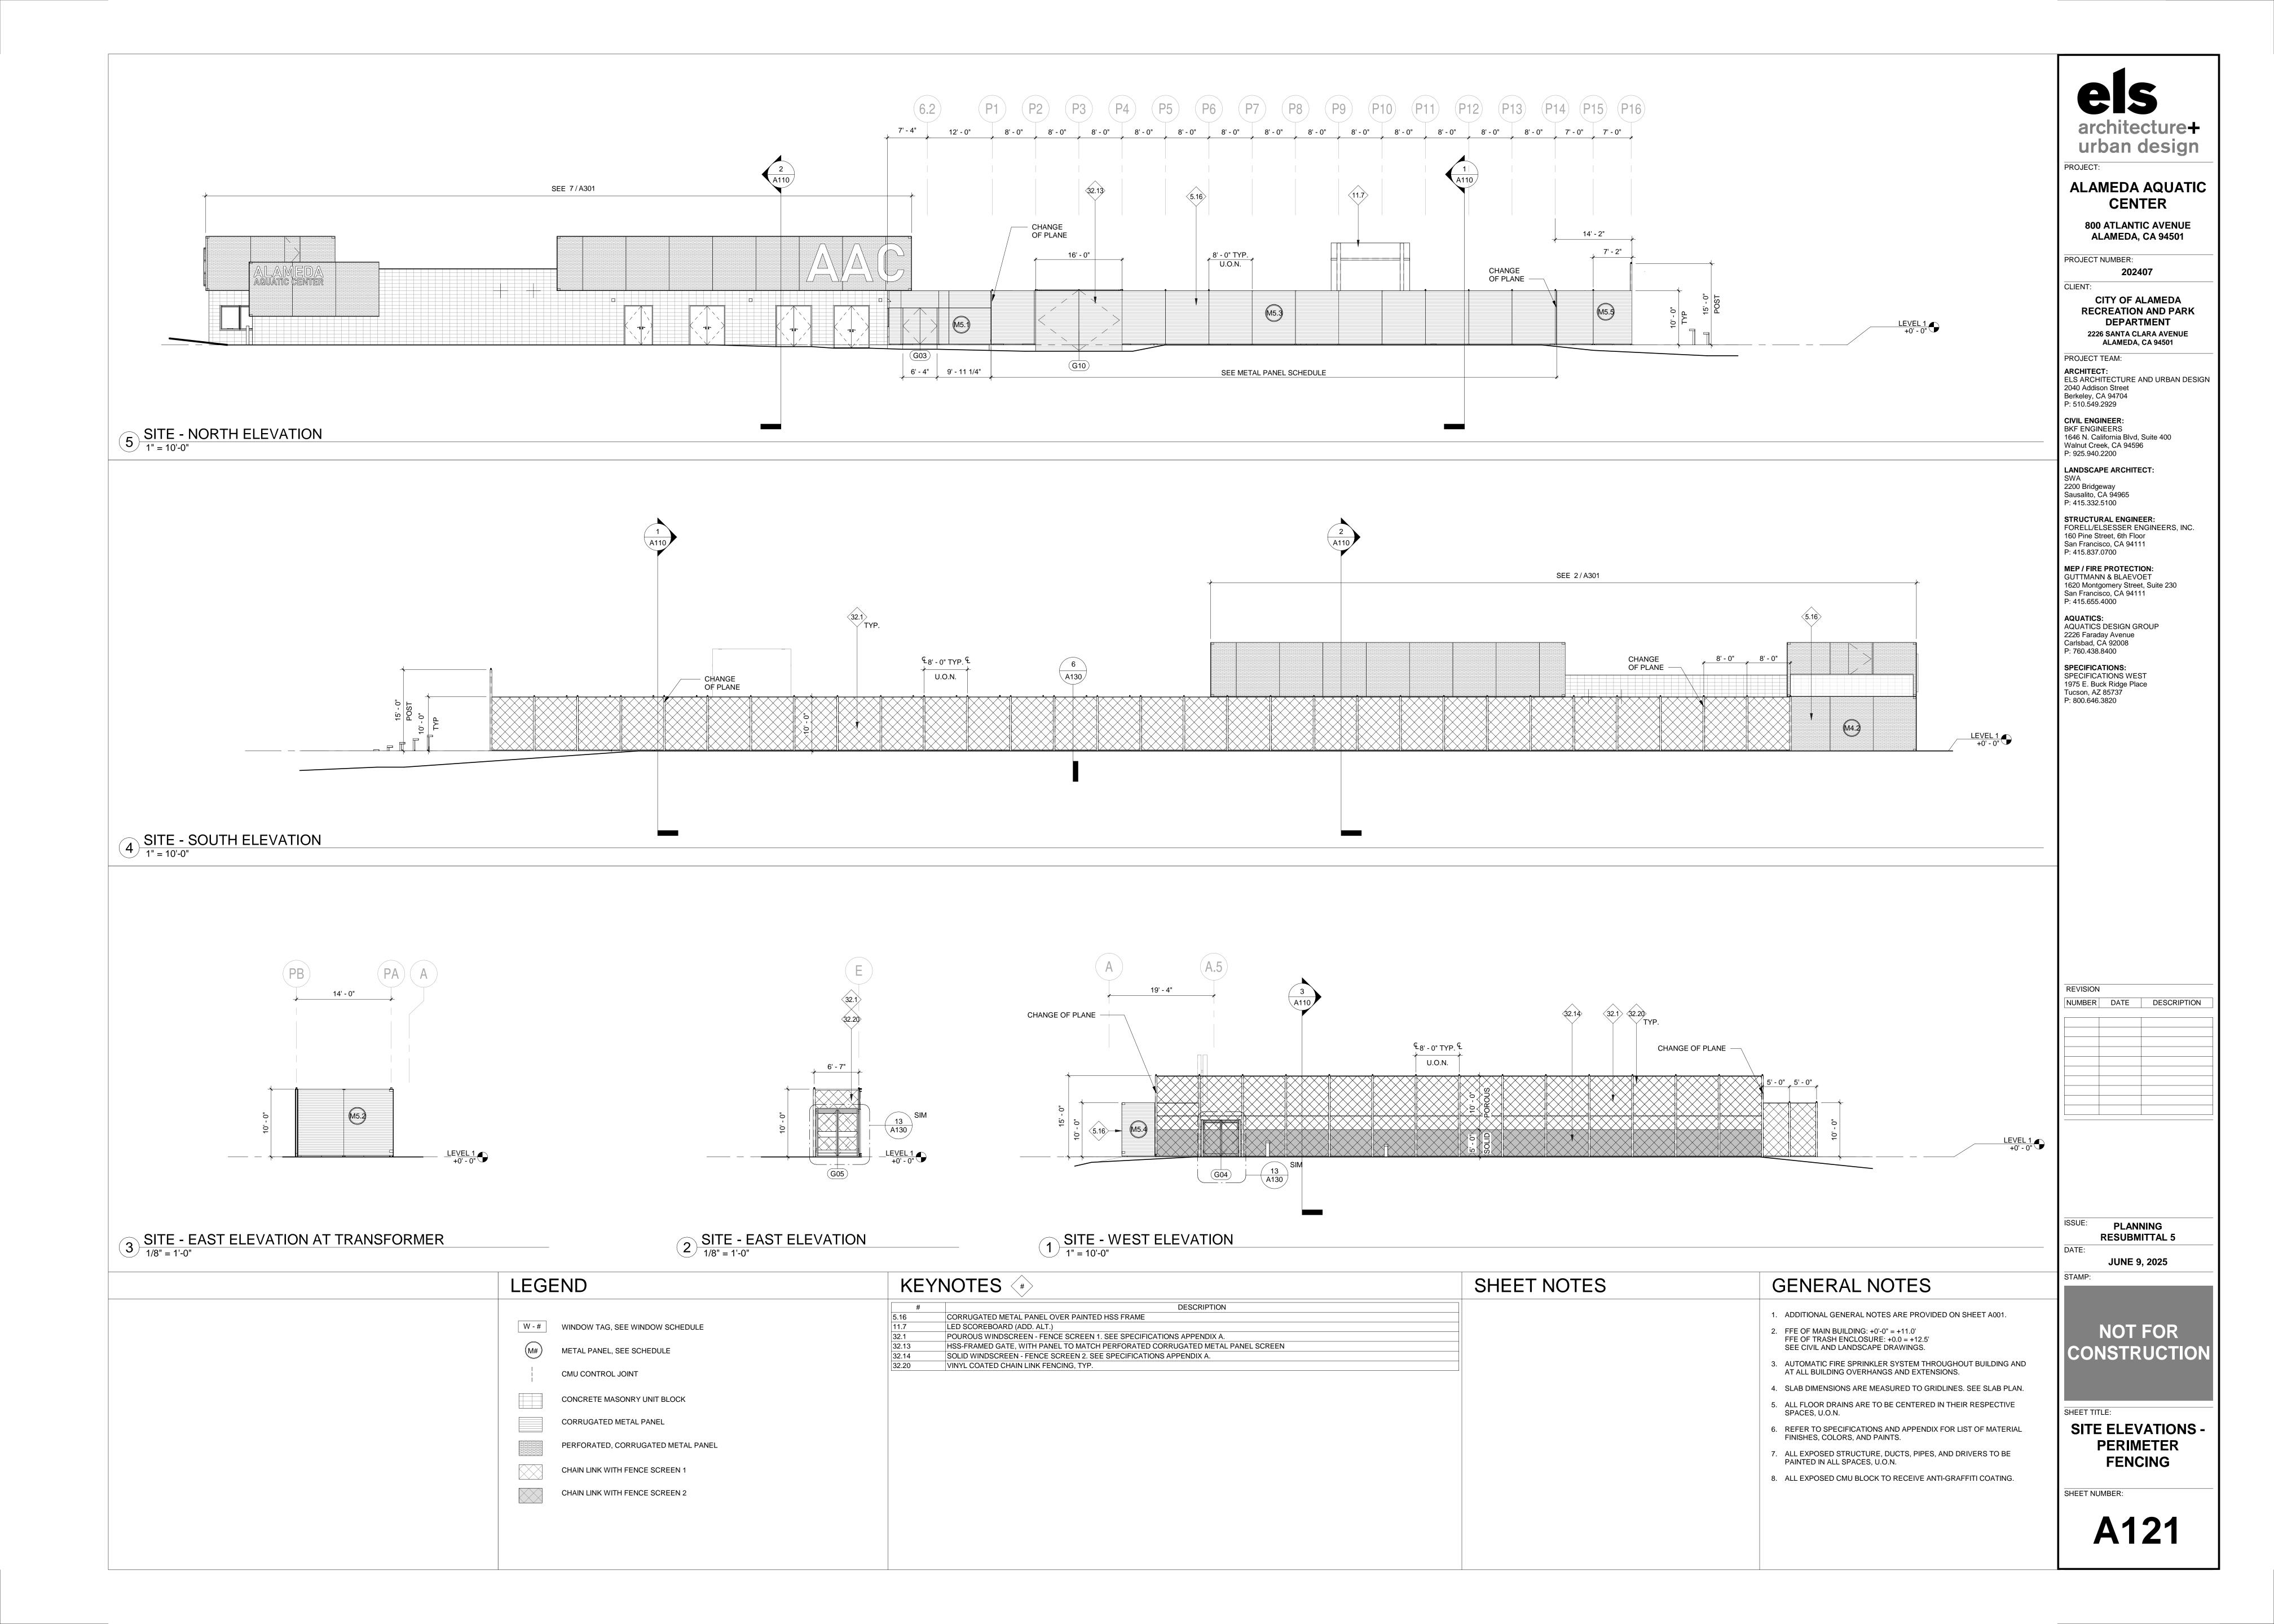


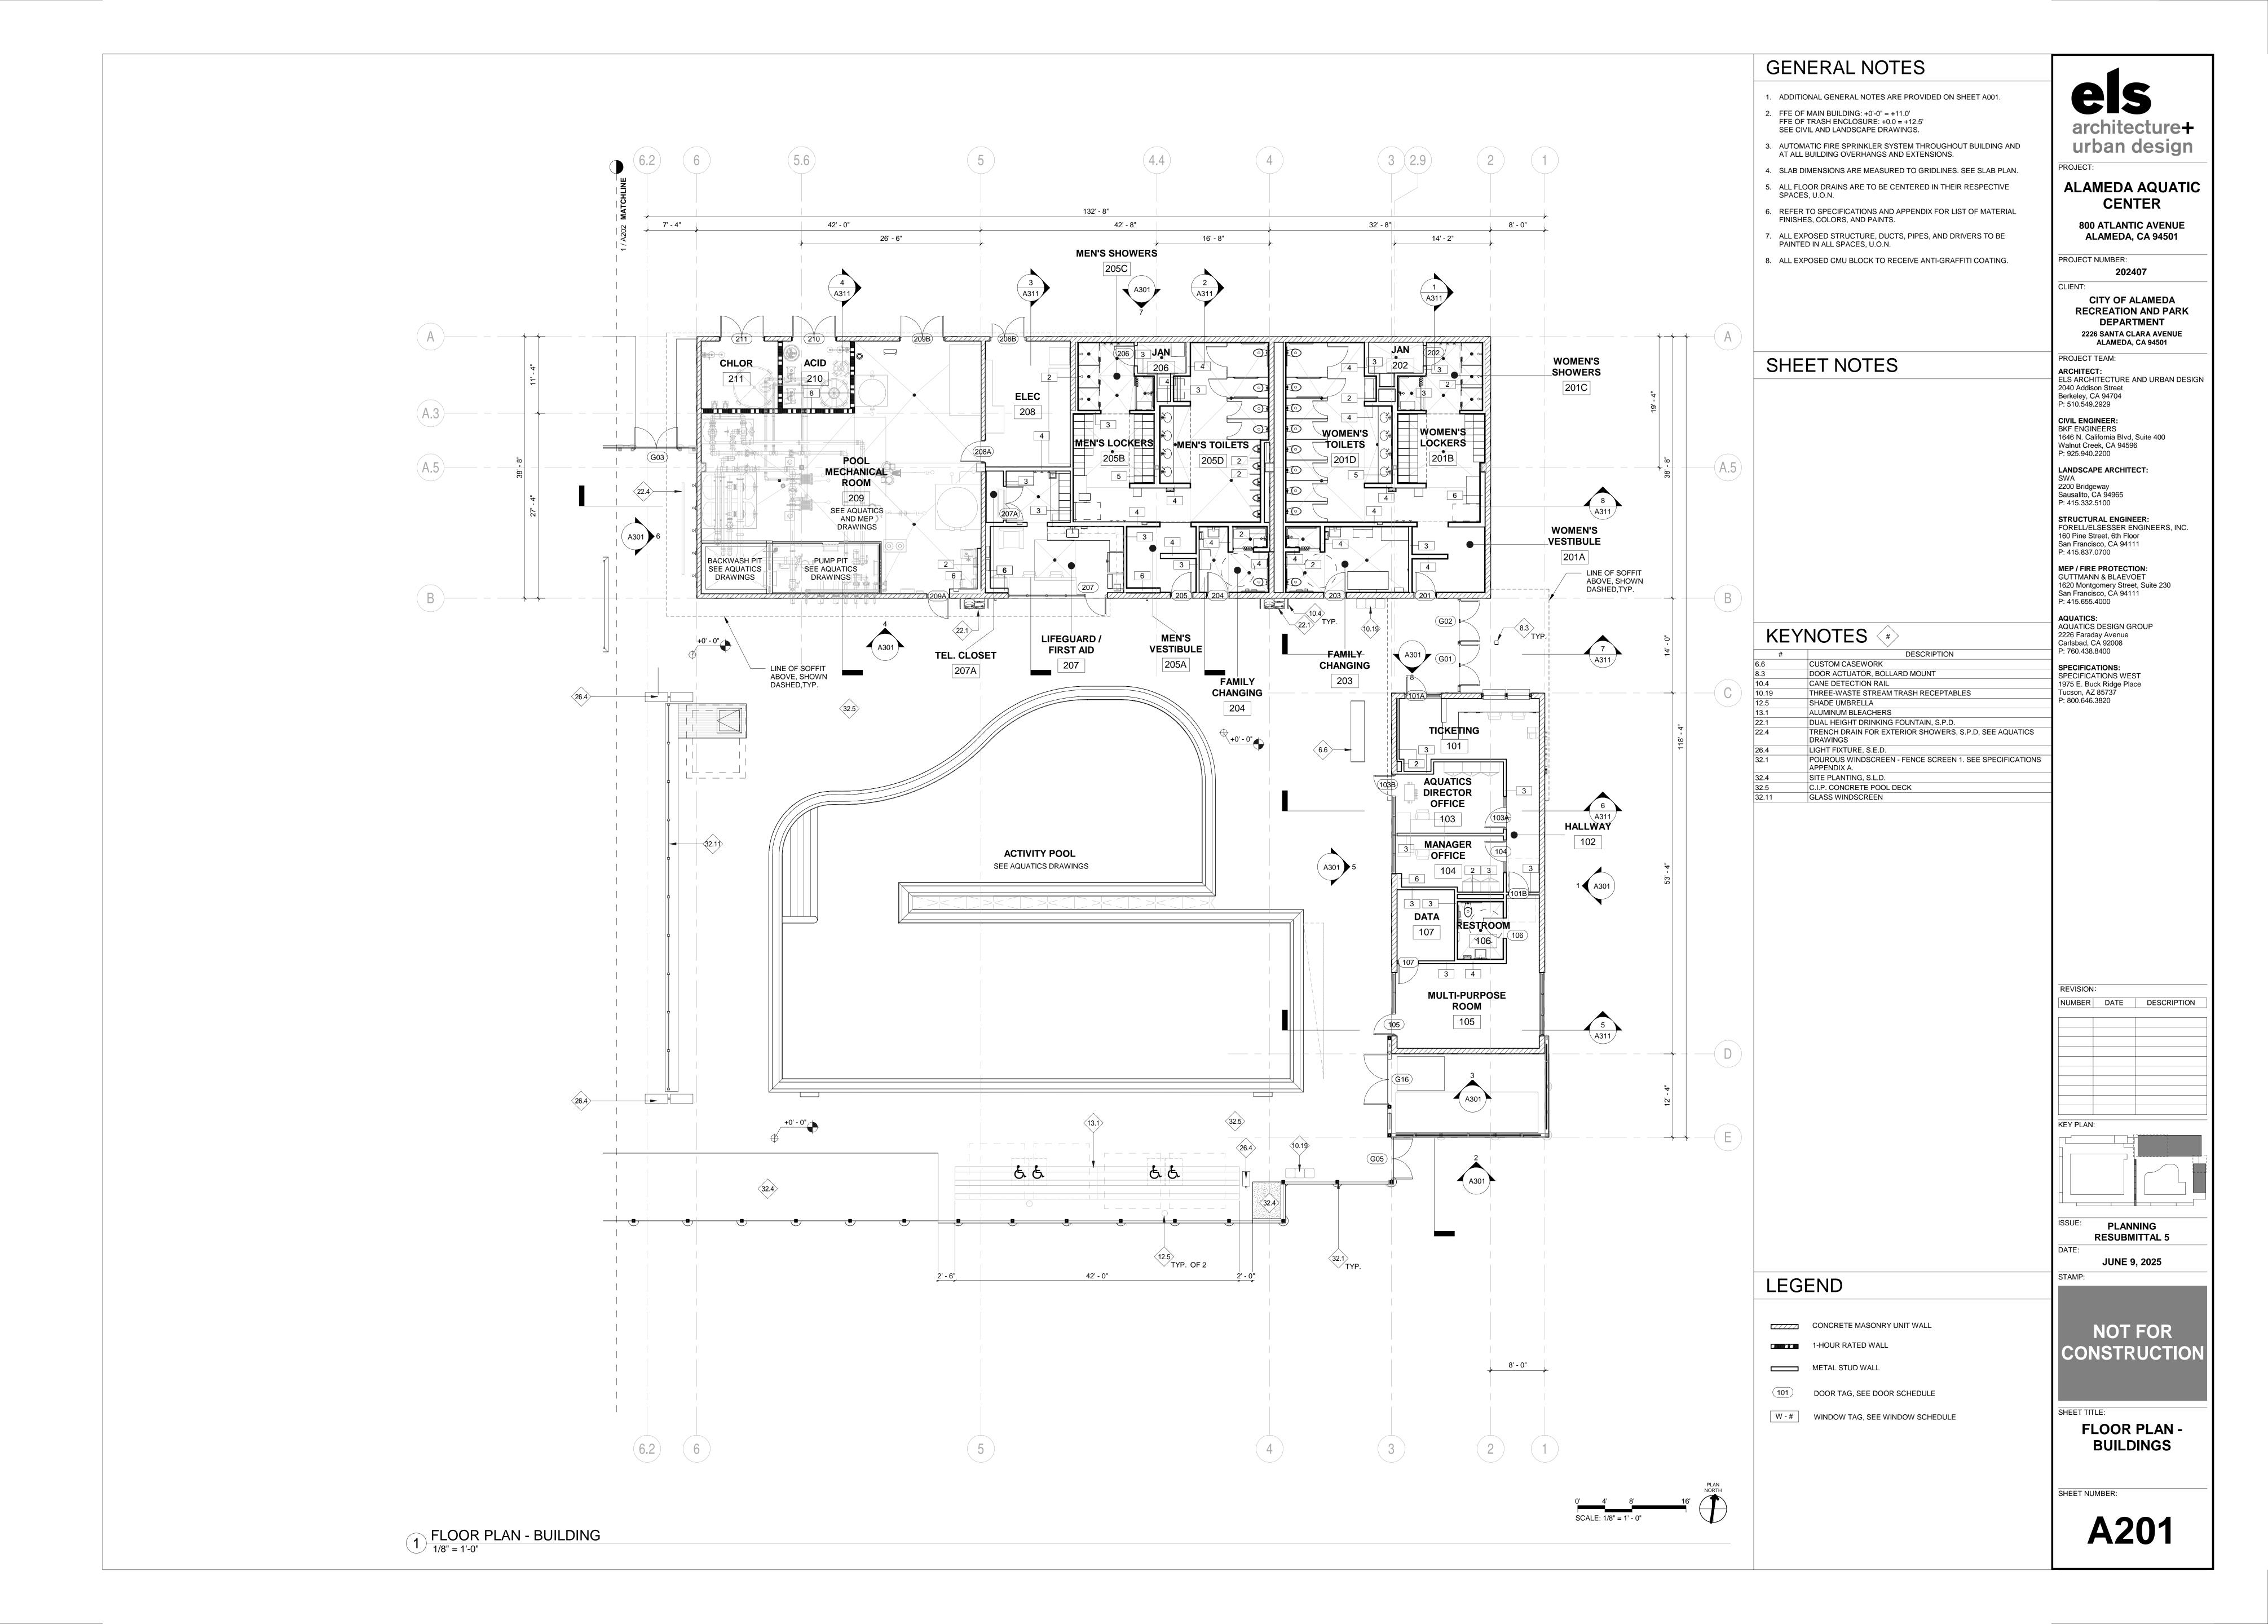


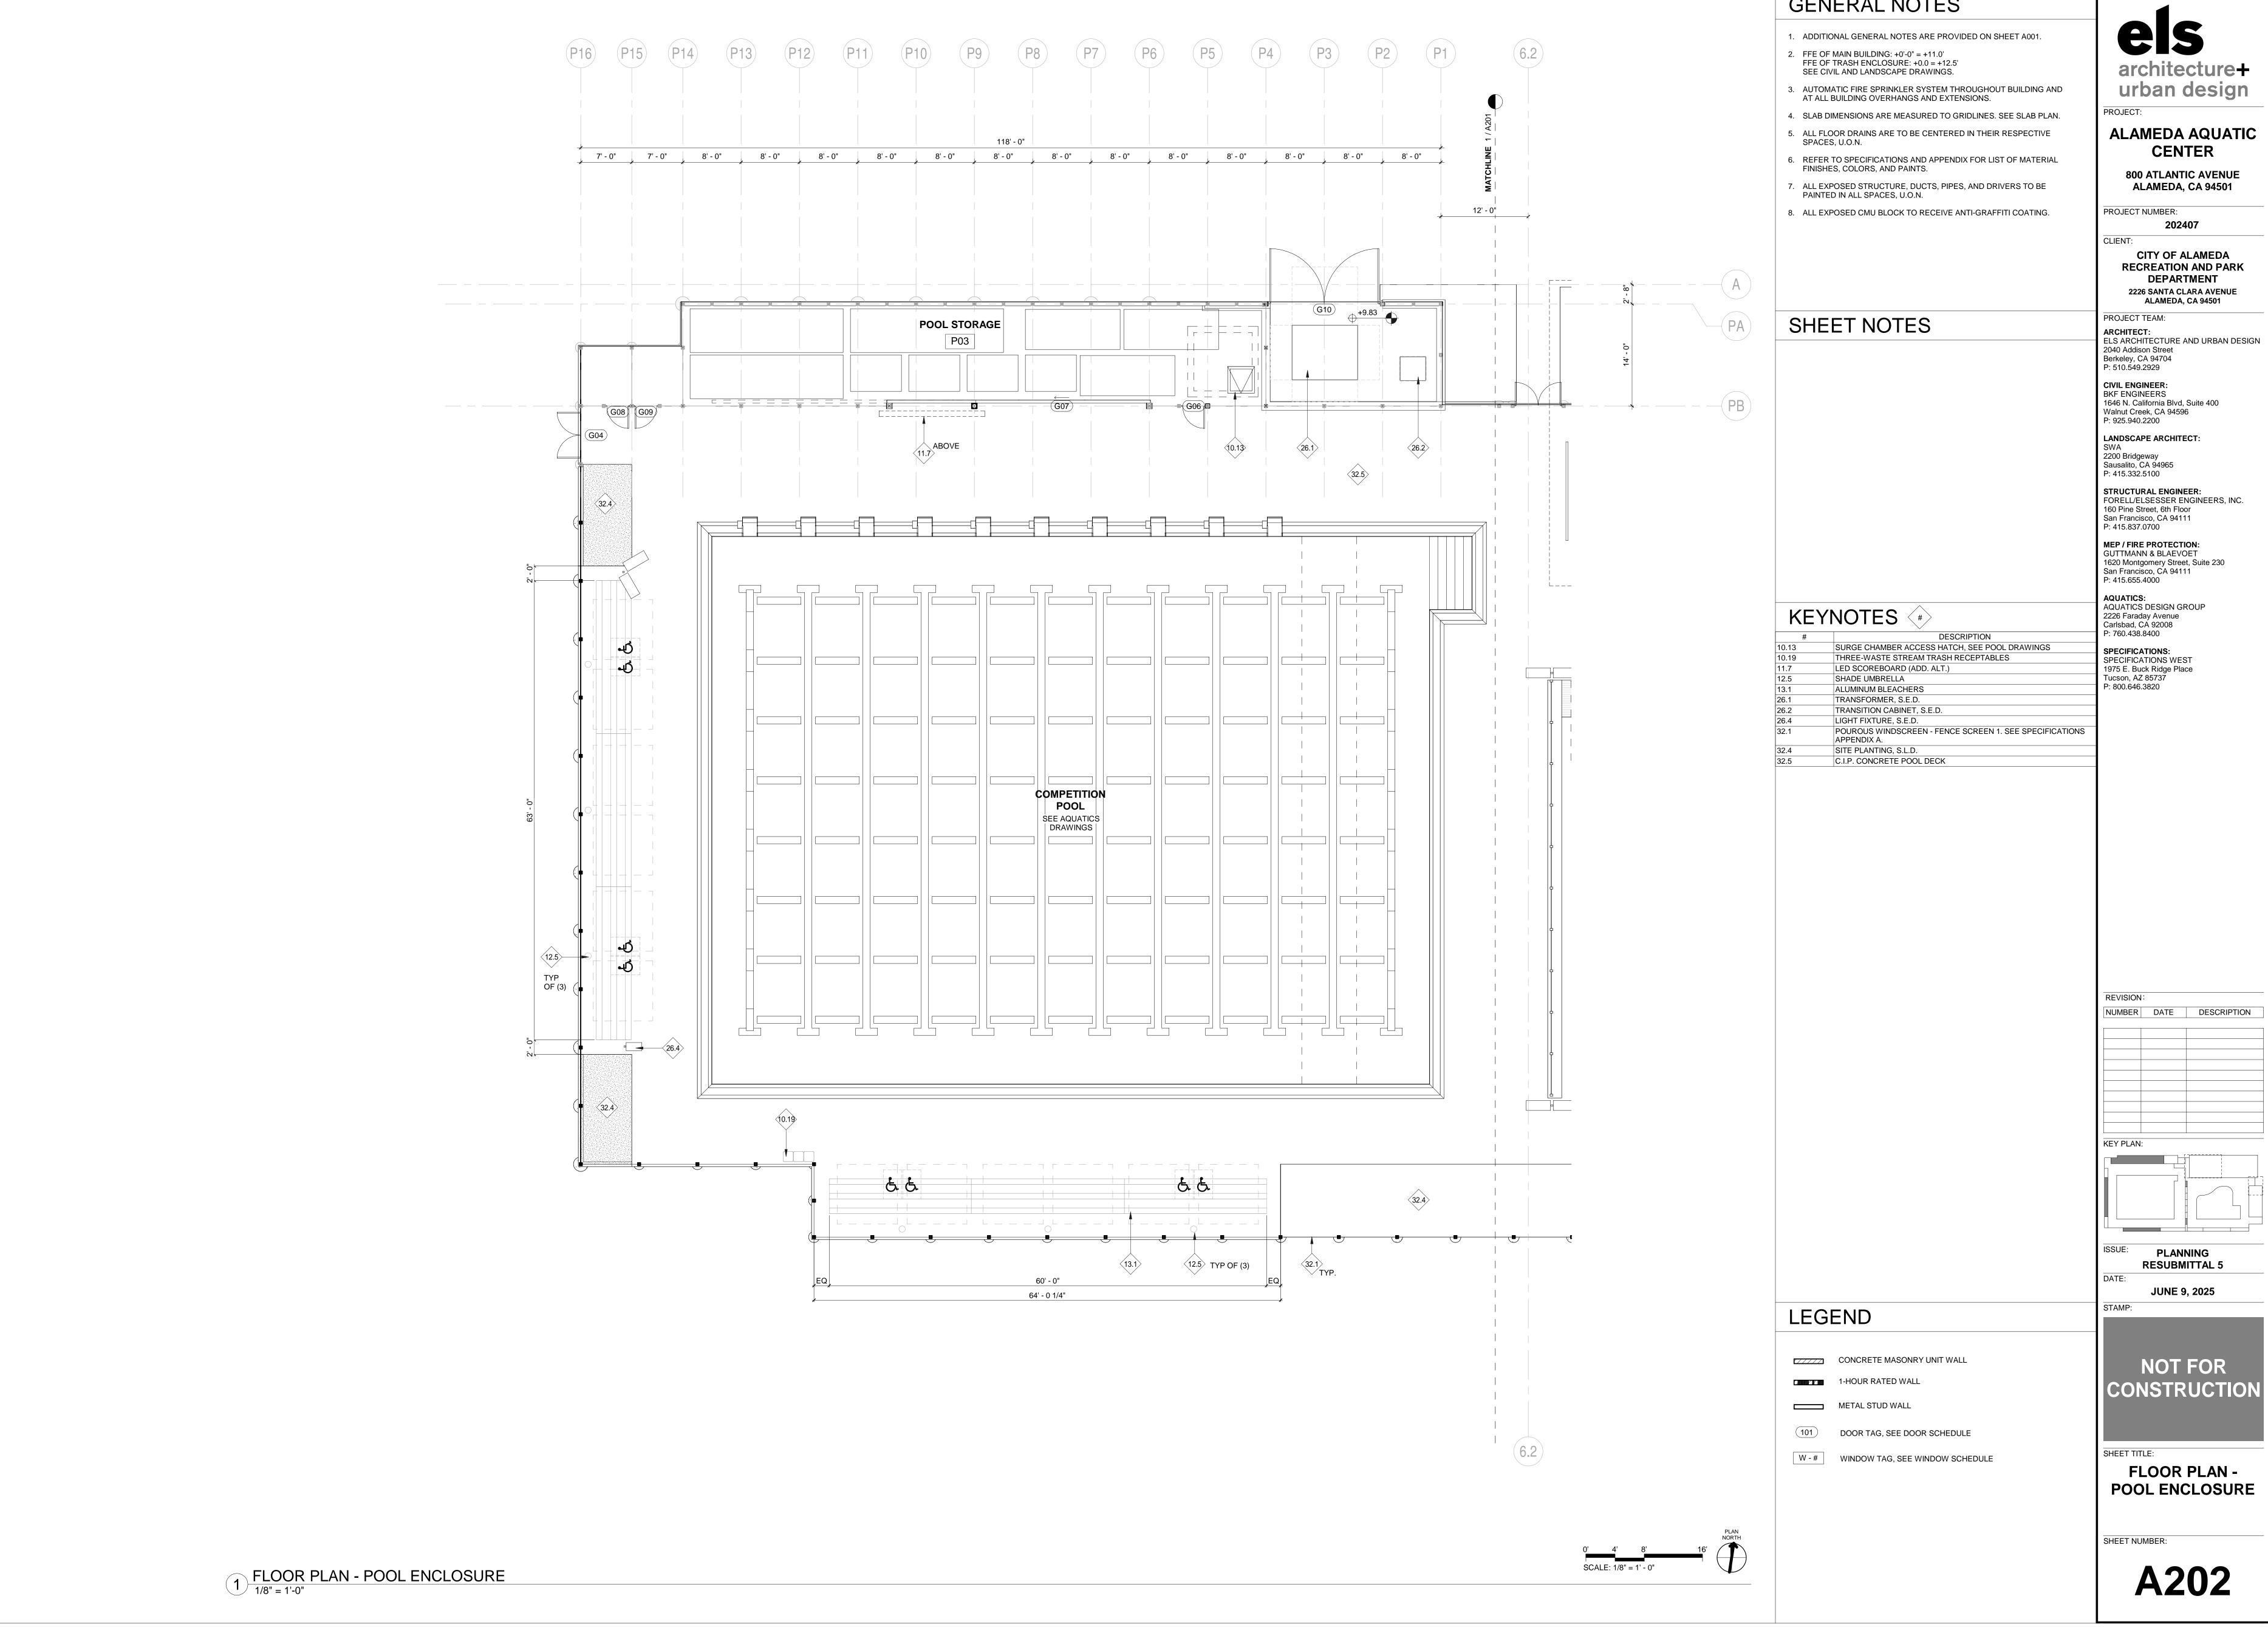



GENERAL NOTES

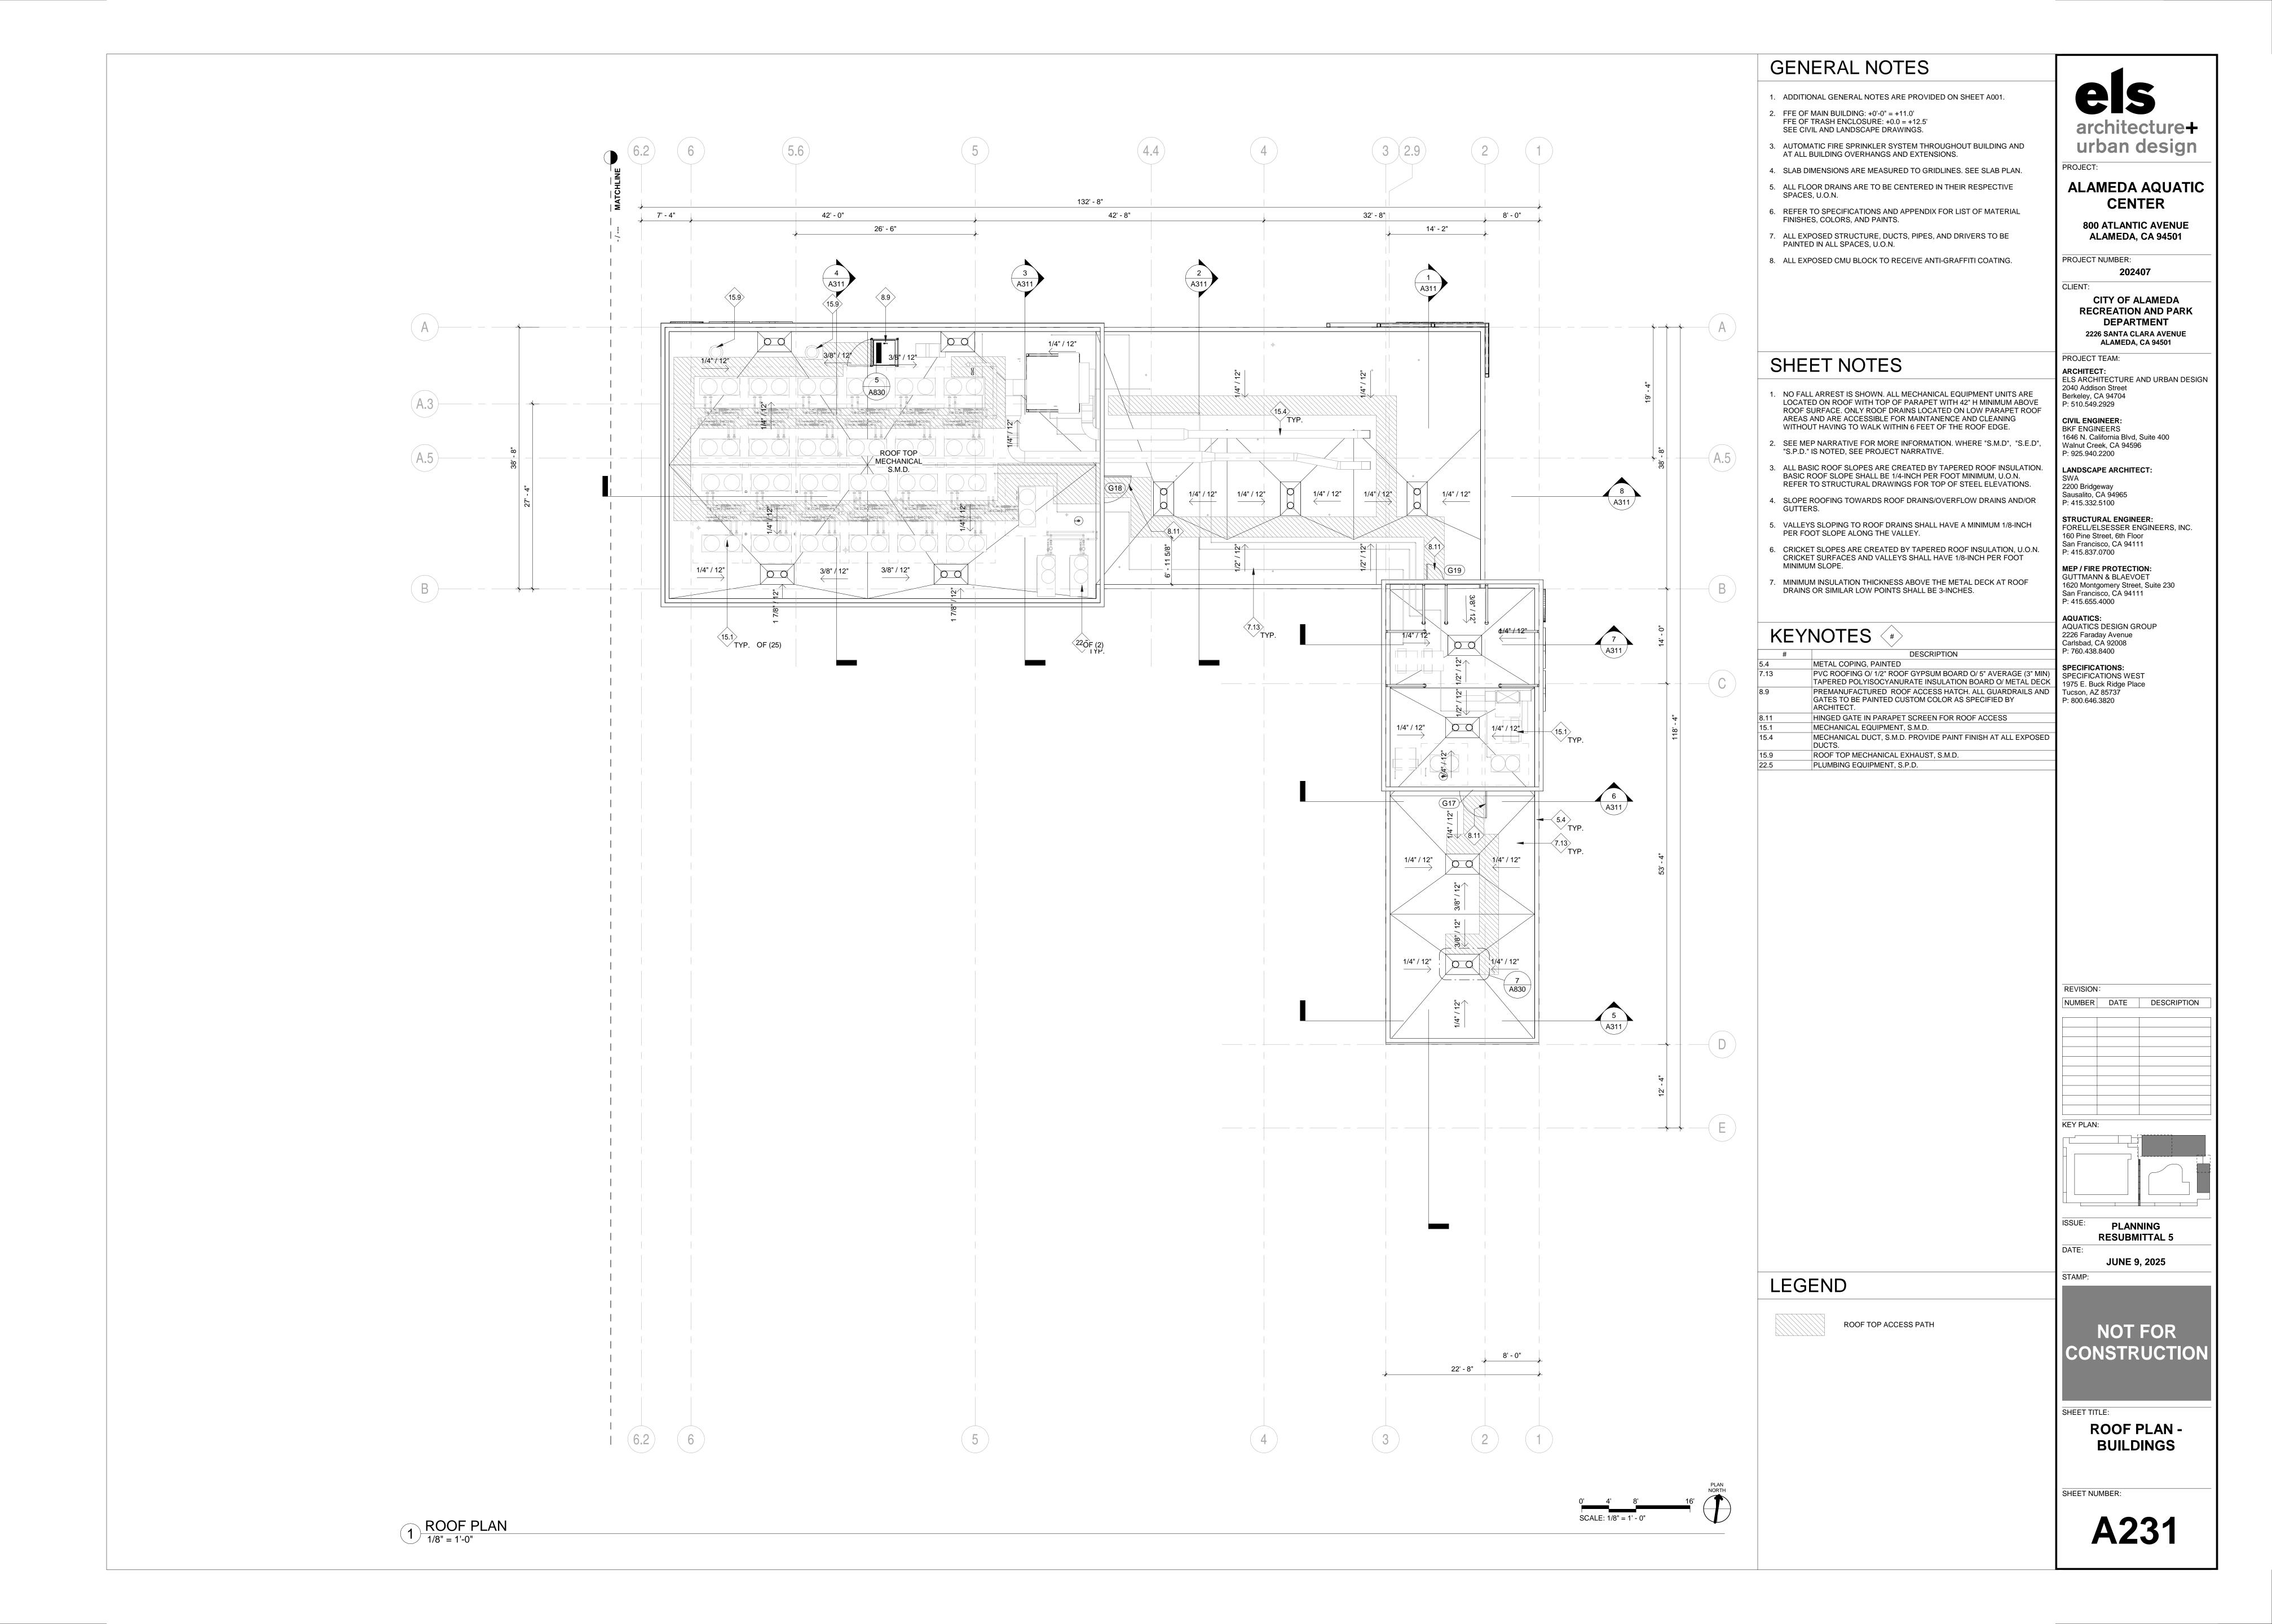

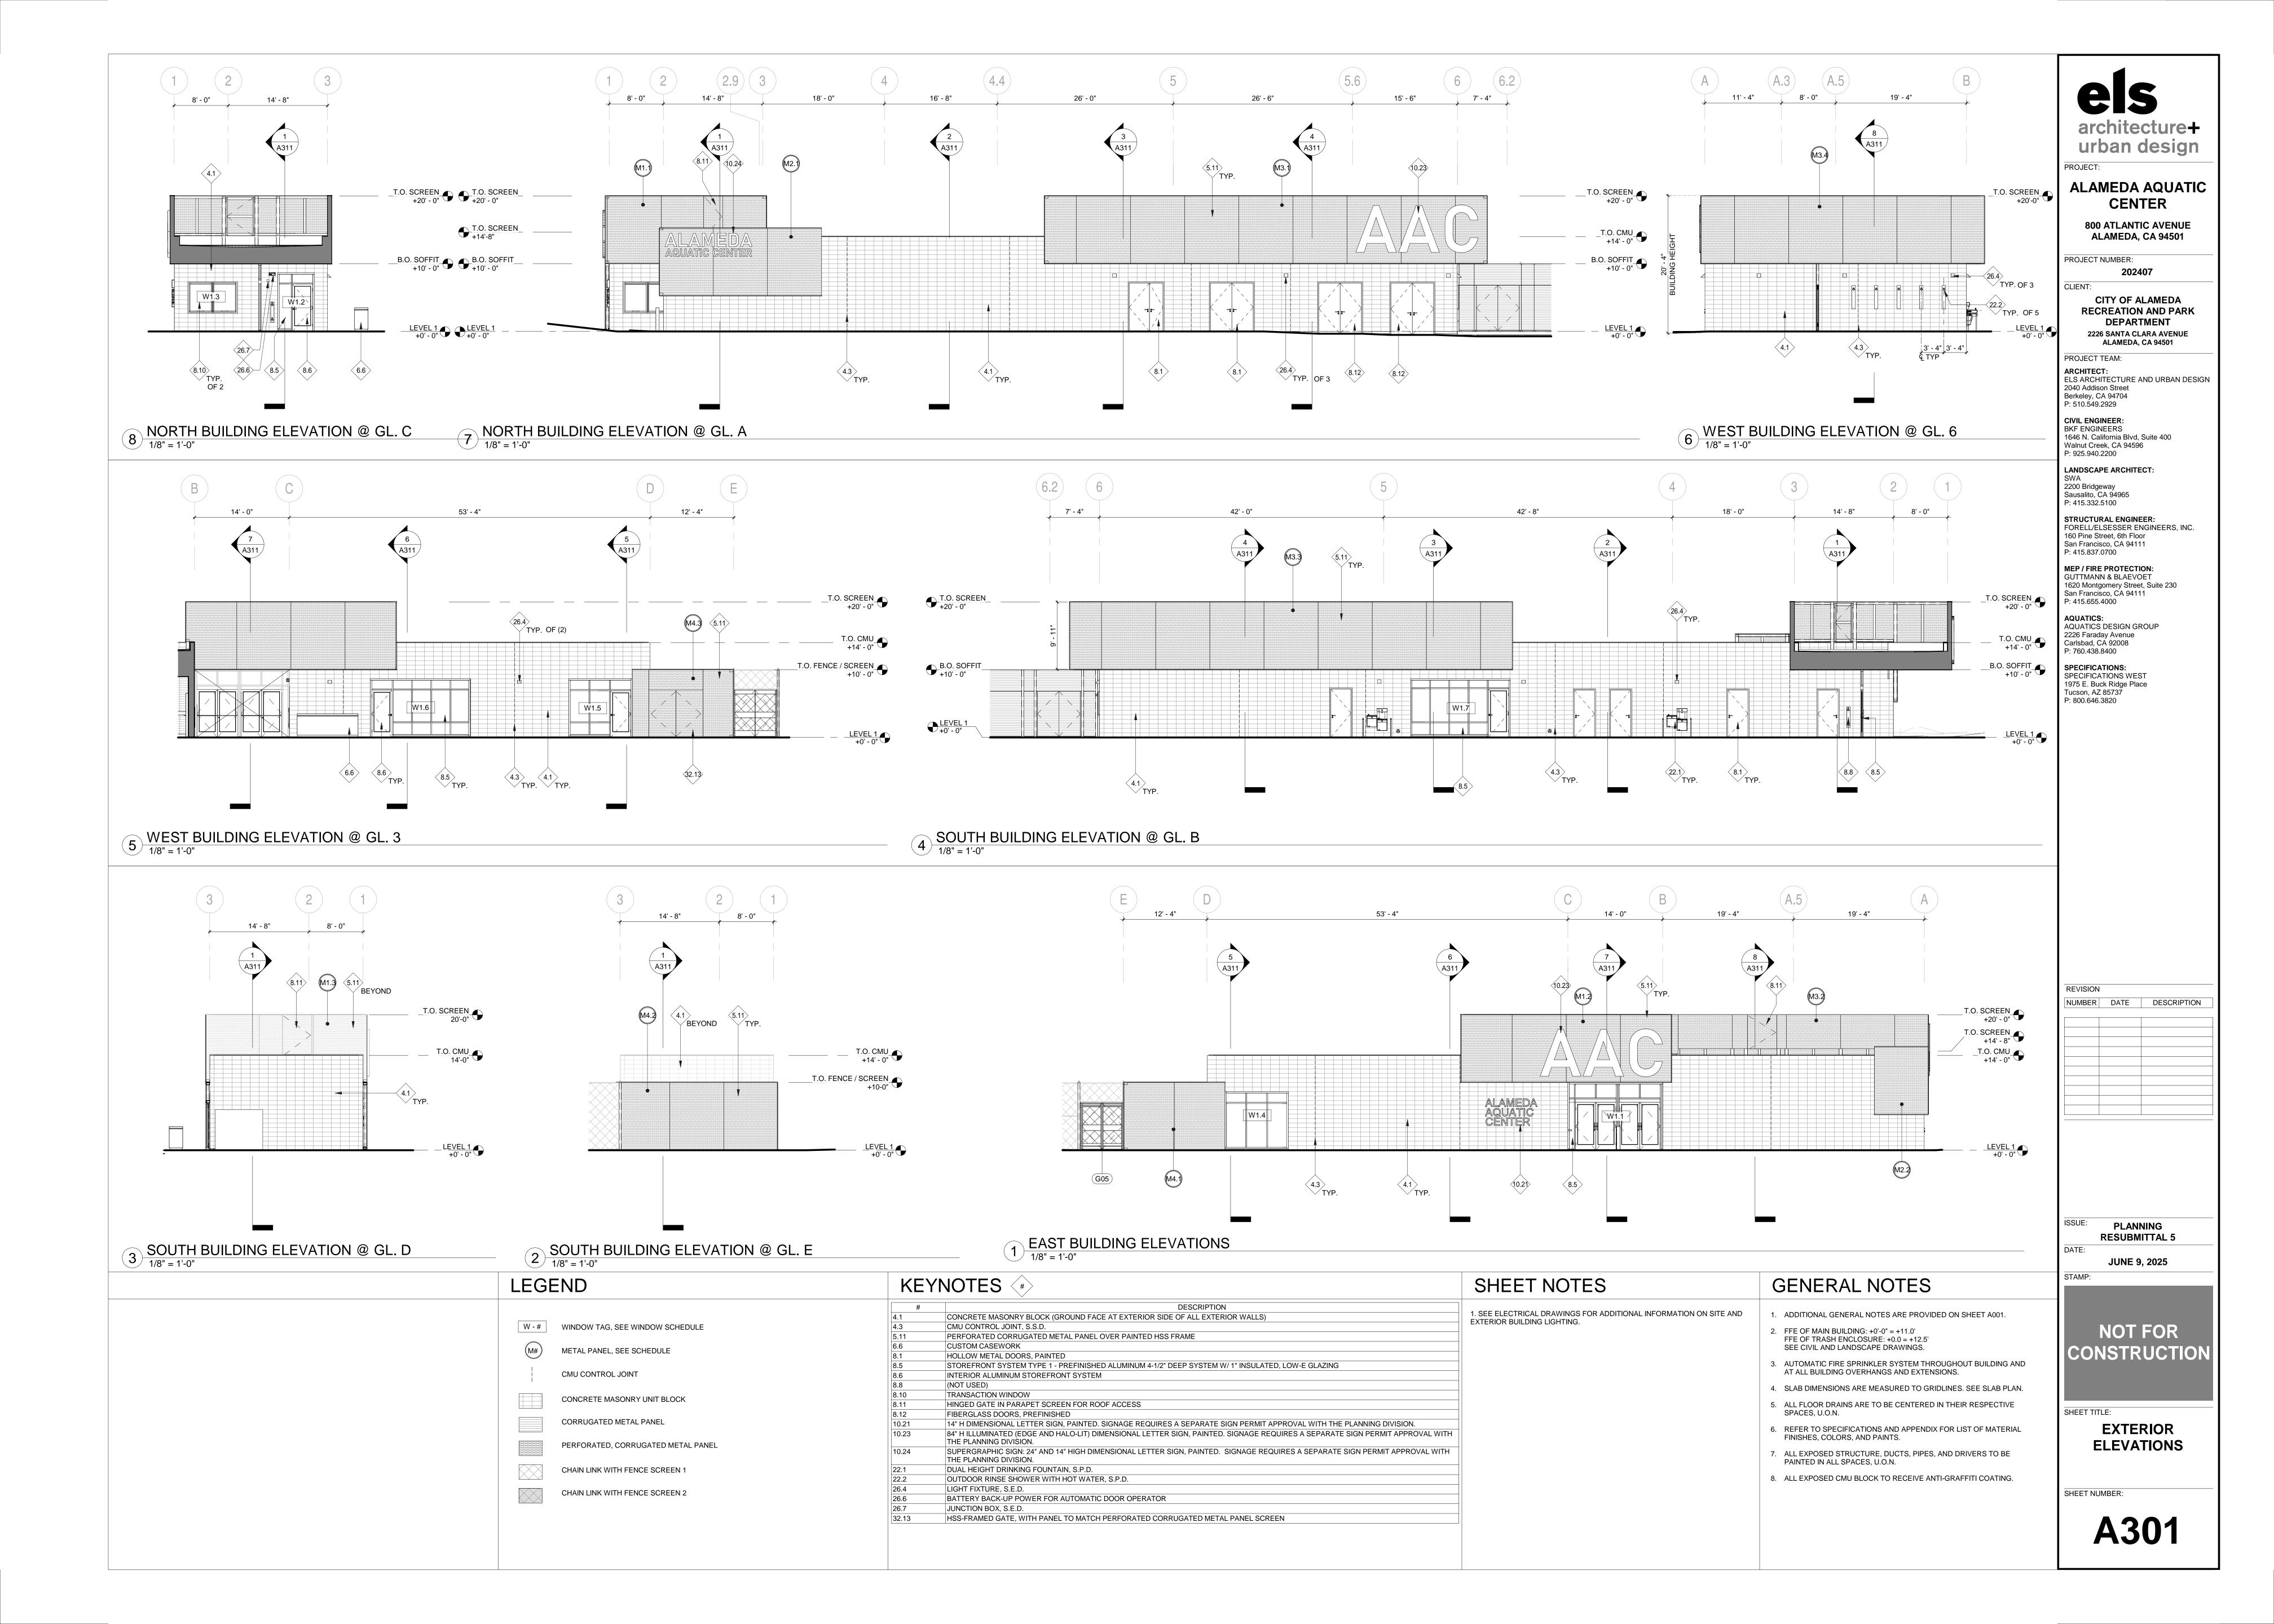

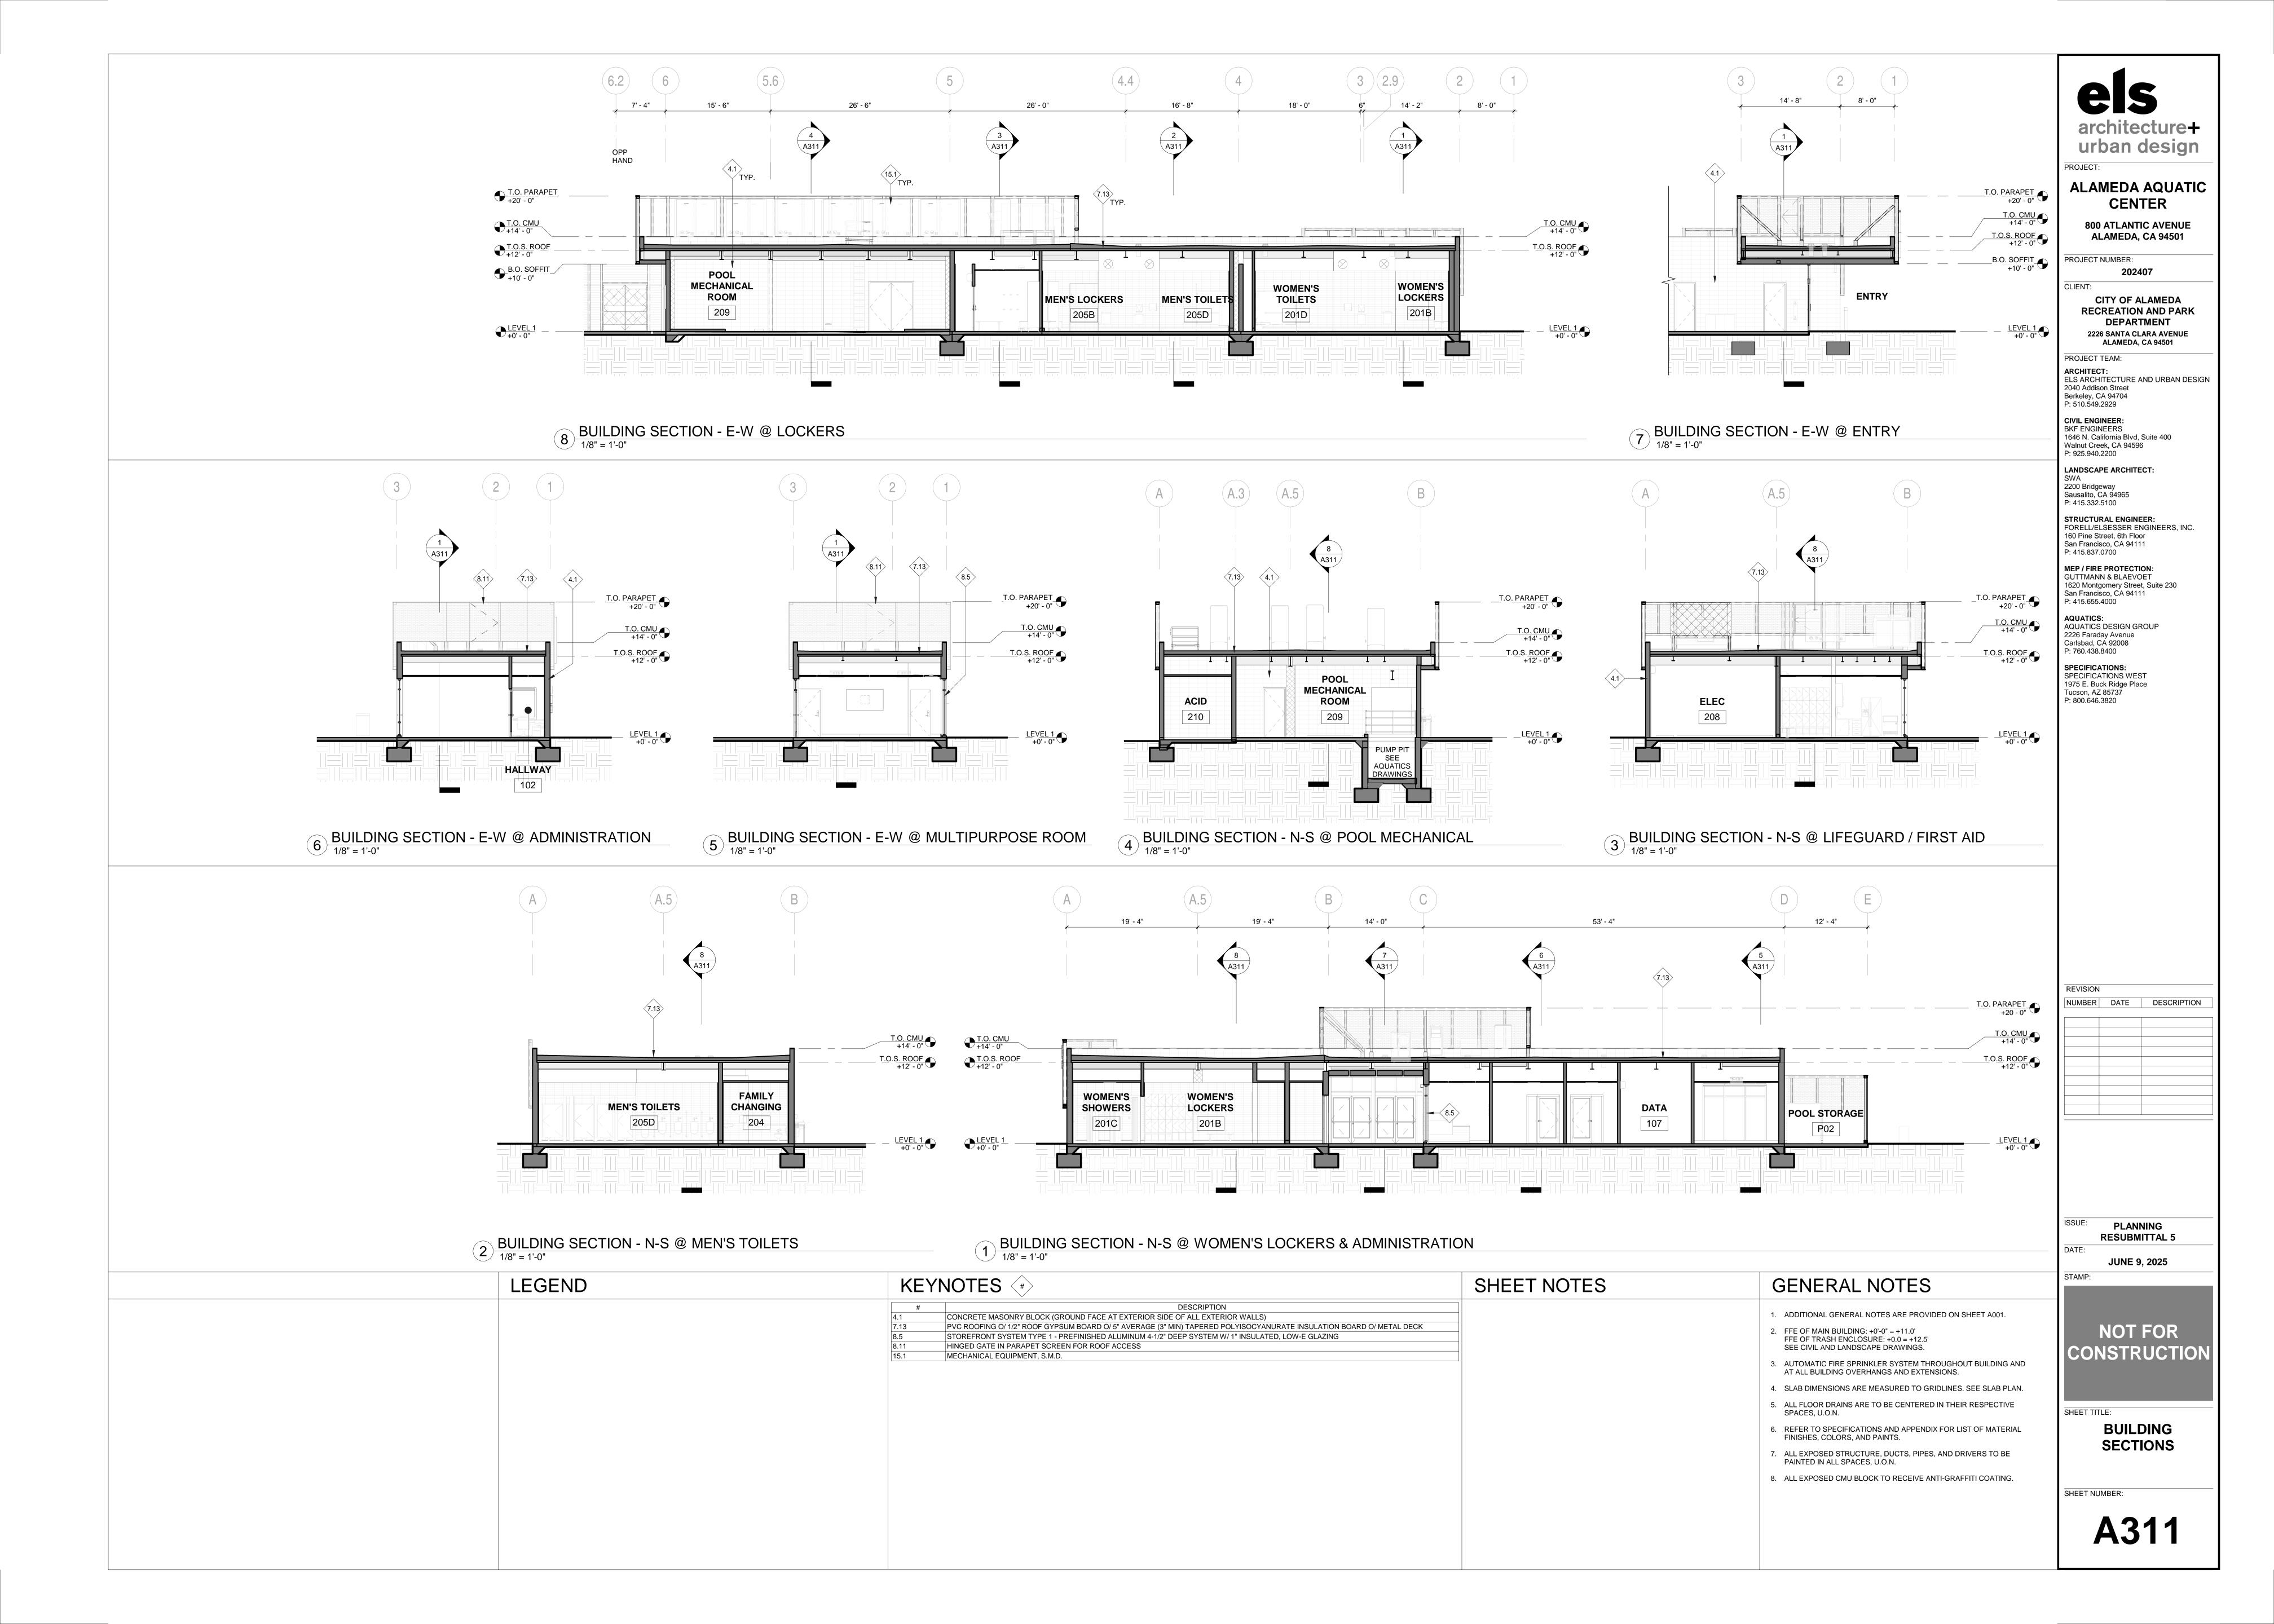

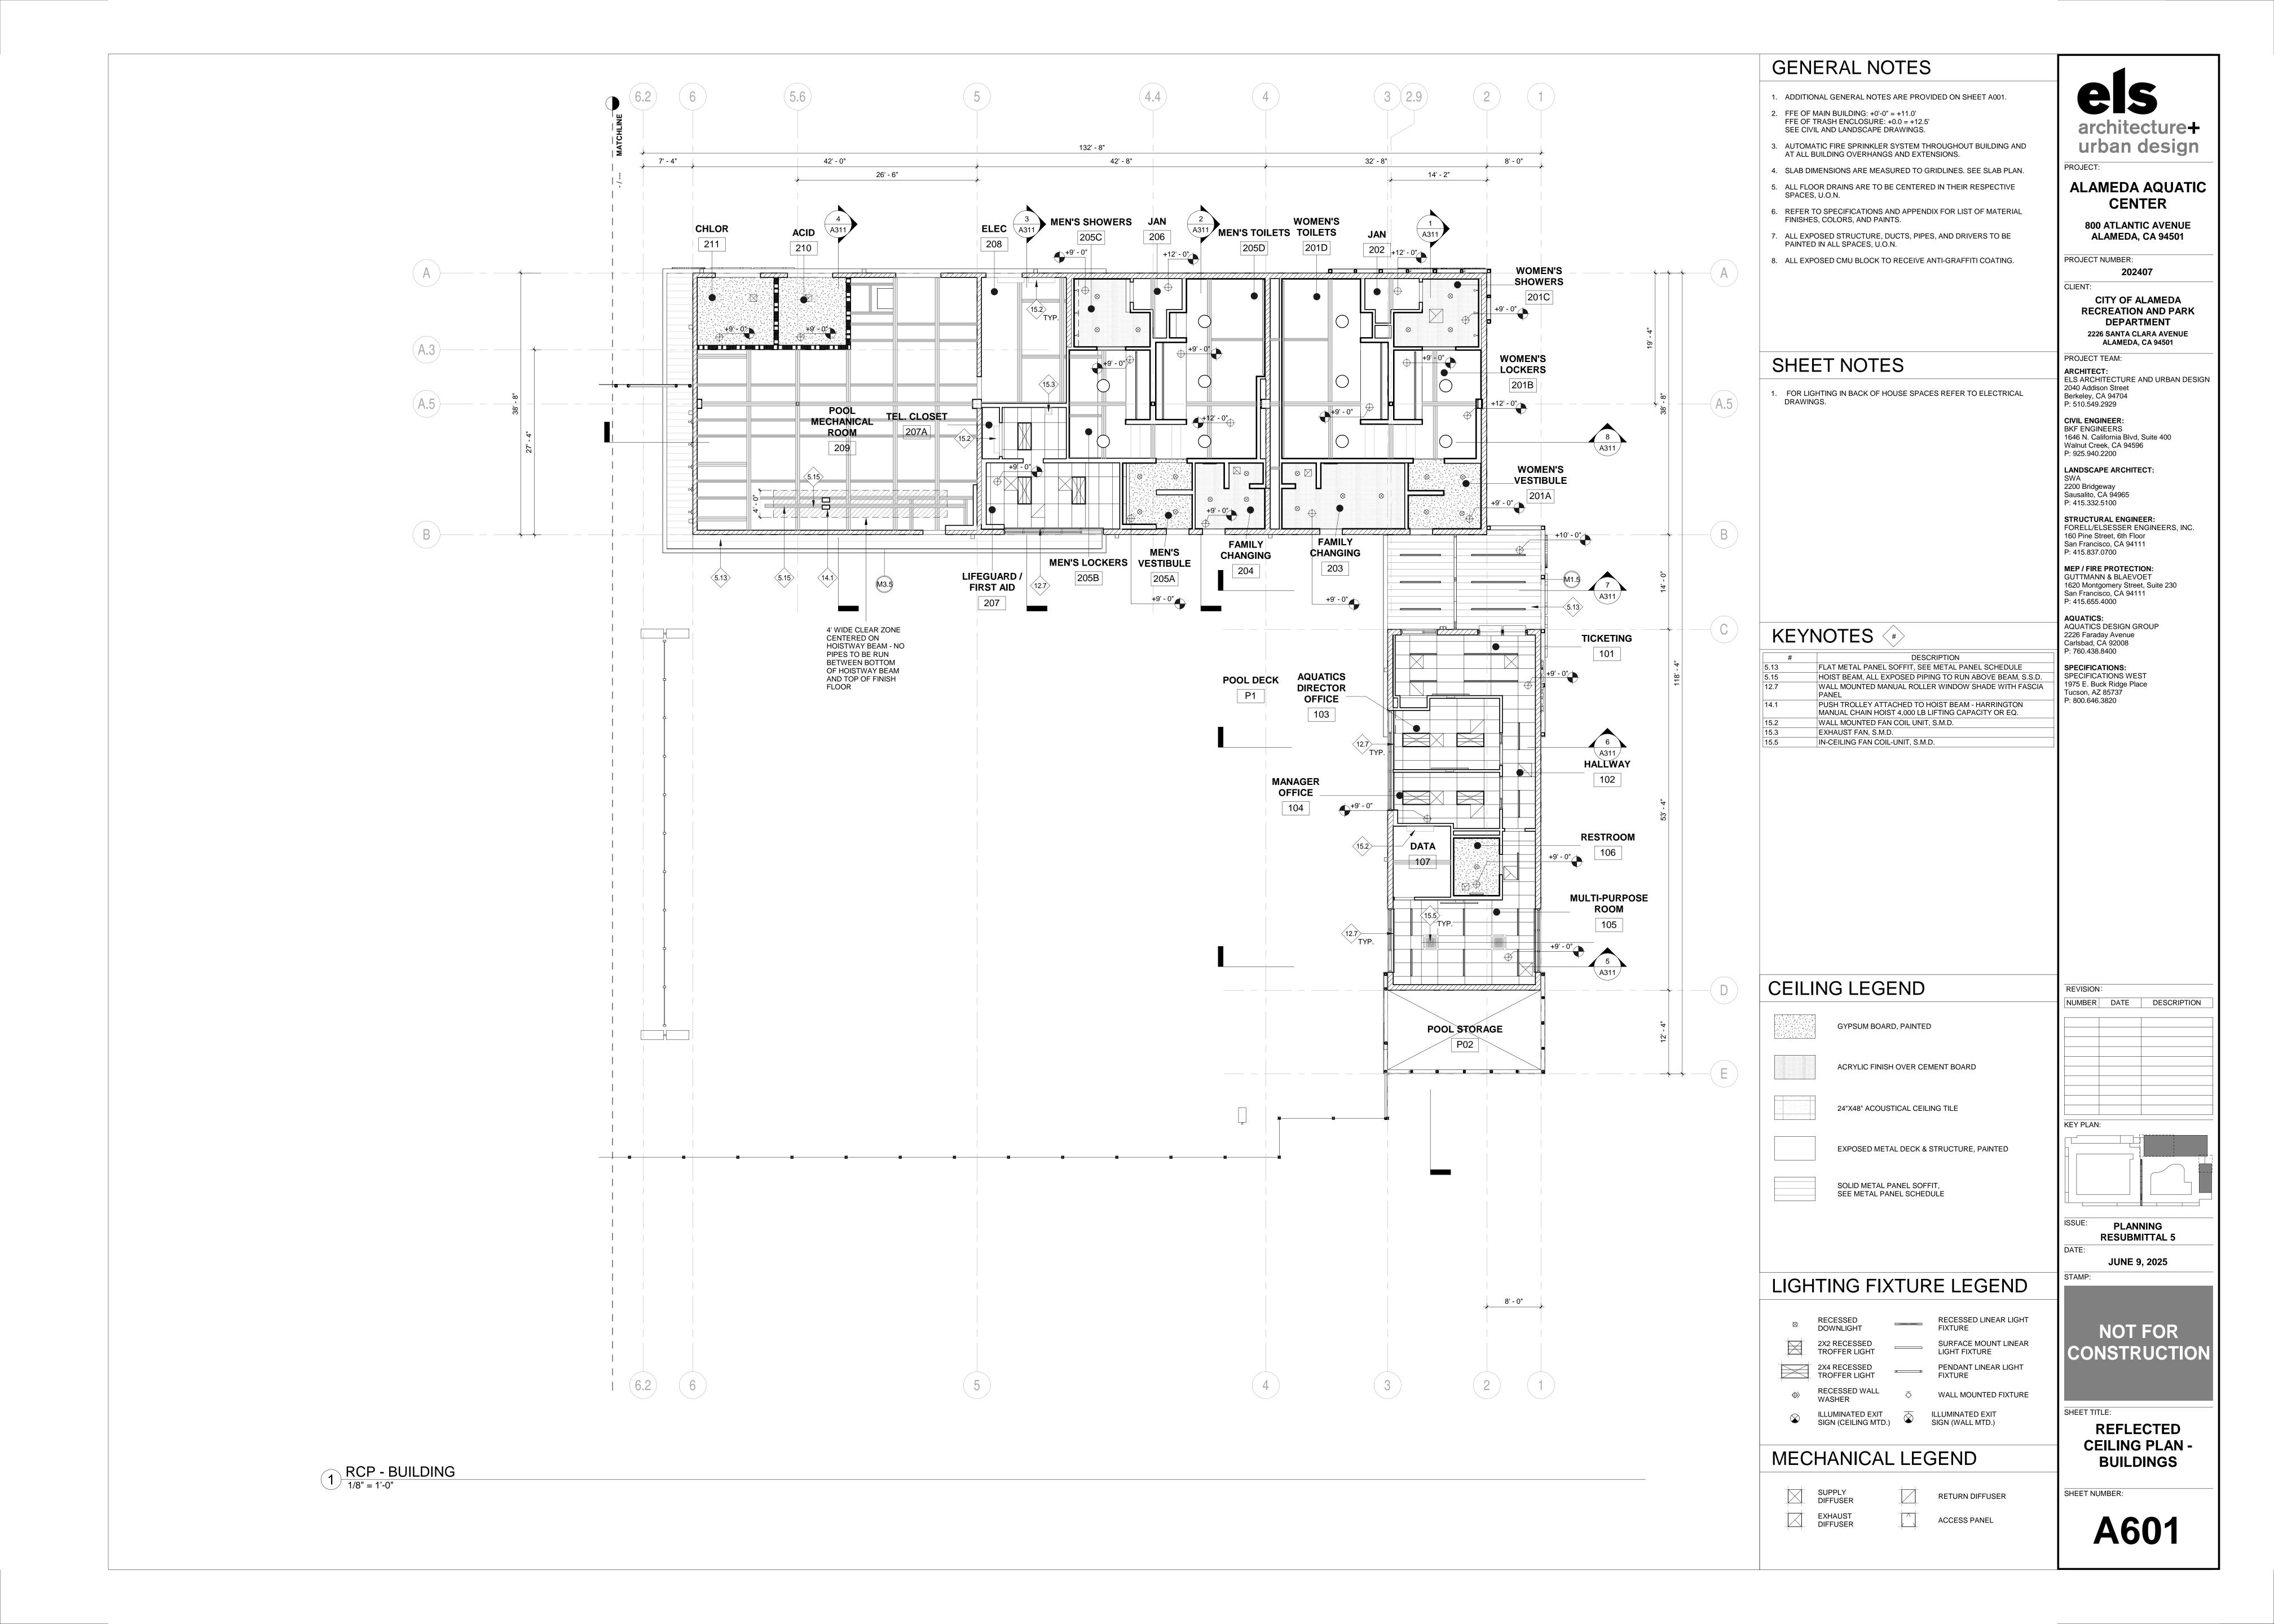


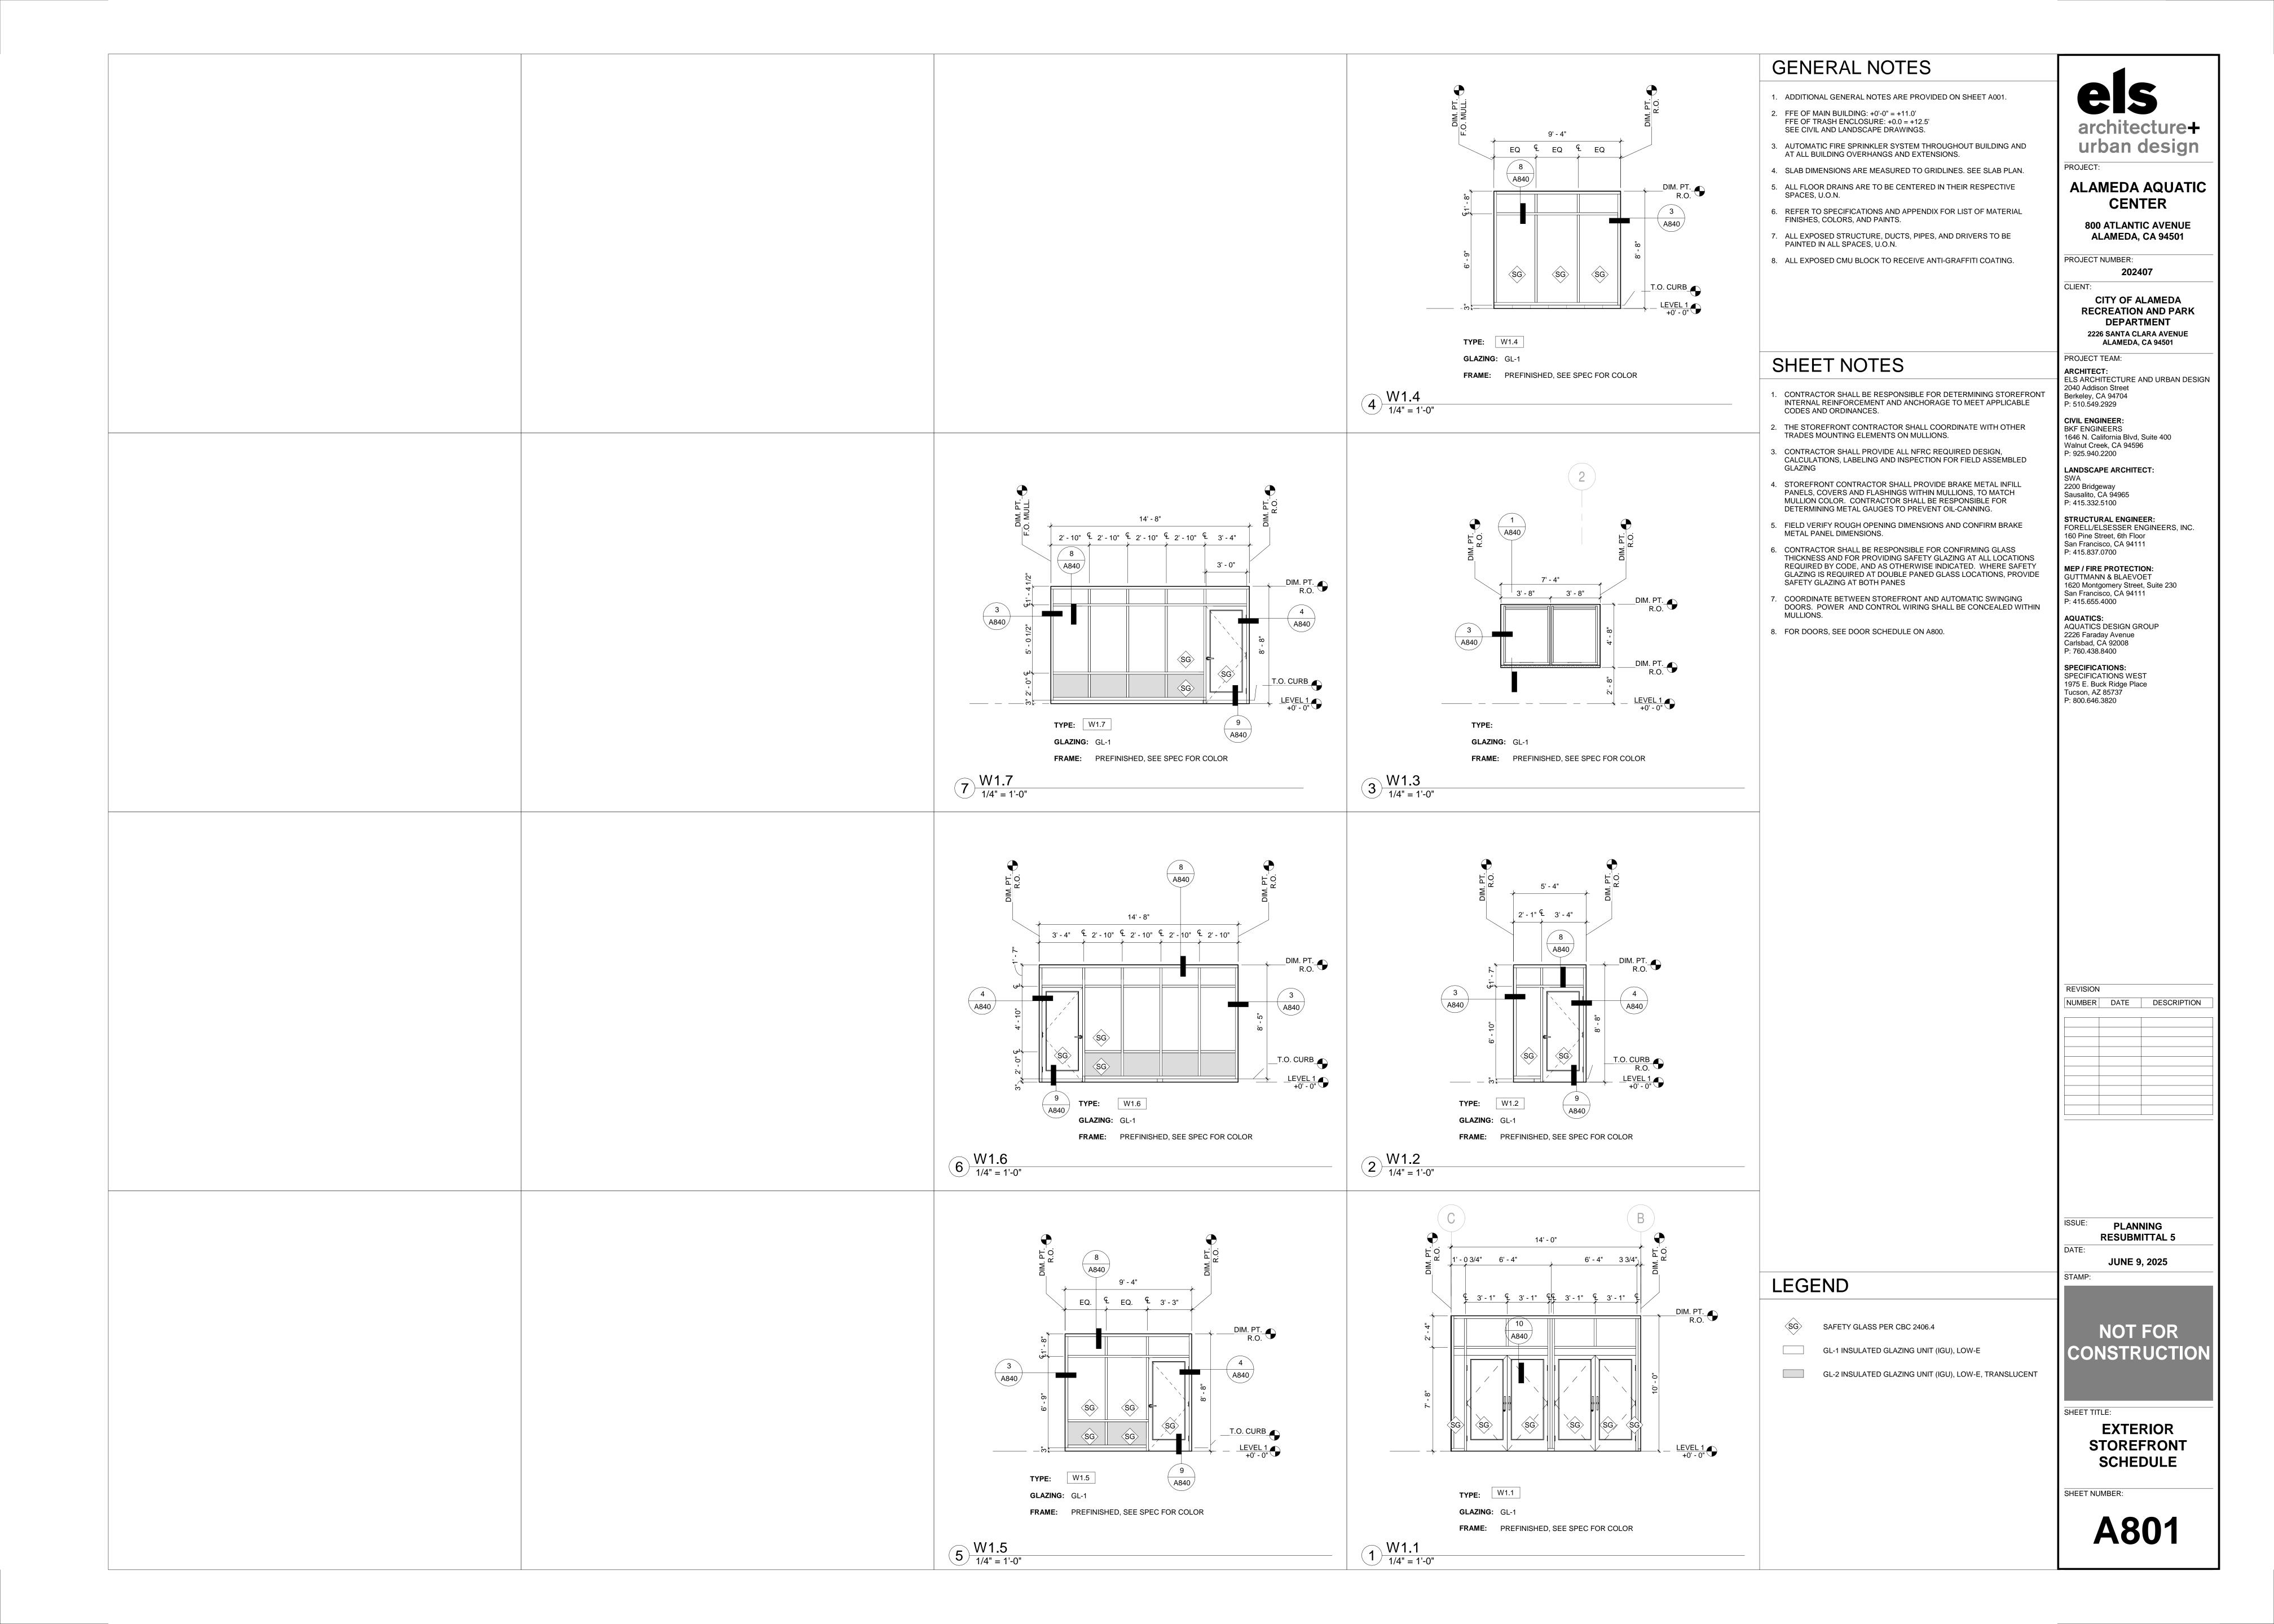


| | POWER LEGEND | | | | | | |
|-----------------|---|--|--|--|--|--|--|
| \bigcirc | SINGLEPLEX RECEPTACLE OUTLET: 125V, 20A, MOUNT AT 18"AFF TO CENTER OF OUTLET, TYP. UON | | | | | | |
| \bigcirc | DUPLEX RECEPTACLE OUTLET: 125V, 20A, MOUNT AT 18"AFF TO CENTER OF OUTLET, TYP. UON | | | | | | |
| | DOUBLE DUPLEX RECEPTACLE OUTLET: 125V, 20A MOUNT AT 18"AFF TO CENTER OF OUTLET, TYP. UON | | | | | | |
| $lackbox{}{}$ | CONTROLLED DUPLEX RECEPTACLE OUTLET: 125V, 20A, TOP HALF SWITCHED VIA OCCUPANCY SENSOR OR VIA ,TIME SWITCH IN OPEN OFFICES. (PLUG LOAD CONTROL) MOUNT AT 18"AFF TO | | | | | | |
| | CENTER OF OUTLET, UON HALF-CONTROLLED DOUBLE DUPLEX OUTLET: 125V, 20A, (ONE DUPLEX CONTROLLED, ONE DUPLEX UNCONTROLLED). MOUNT AT 18"AFF TO CENTER OF OUTLET, UON | | | | | | |
| <u> </u> | COMBINATION 120V/USB DUPLEX RECEPTACLE | | | | | | |
| <u> </u> | FLOOR MOUNTED DUPLEX OUTLET. 125V, 20A | | | | | | |
| | FLOOR MOUNTED POWER DOUBLE DUPLEX OUTLET. 125V, 20A | | | | | | |
| | FLUSH FLOOR MOUNTED POWER OUTLET. FIELD VERIFY EXACT, LOCATION AND TYPE. 125V, | | | | | | |
| | COMBINATION POWER, TELE/DATA & AUDIO VISUAL FLUSH FLOOR MOUNTED SPLIT | | | | | | |
| (AV) | WIRED DUPLEX OUTLET. 125V. 20A COMBINATION POWER, TELE/DATA & AUDIO VISUAL FLUSH FLOOR MOUNTED | | | | | | |
| AV | HALF CONTROLLED QUADRUPLEX OUTLET. 125V. 20A | | | | | | |
| Φ | CEILING MOUNTED DUPLEX OUTLET. 125V, 20A | | | | | | |
| | CEILING MOUNTED DOUBLE DUPLEX OUTLET. 125V, 20A | | | | | | |
| \bigcirc | SPECIAL PURPOSE OUTLET. RATING AS INDICATED. | | | | | | |
| + | CORD DROP OUTLET, TYPE AS NOTED ON PLAN | | | | | | |
| | POWER POLE , TYPE AS NOTED ON PLAN | | | | | | |
| | COMBINATION POKE-THRU (PEDESTAL) DOUBLE DUPLEX RECEPTACLE, AND TELEPHONE/DATA RECEPTACLE. | | | | | | |
| | POKE THRU (FLUSH) COMBINATION TEL/DATA RECEPTACLE. | | | | | | |
| \$ L | LINE VOLTAGE CONTROL SWITCH. | | | | | | |
| | POWER/TELECOM WIREMOLD SURFACE RACEWAY,LENGTH APPROXIMATELY AS SHOWN | | | | | | |
| В | BELL | | | | | | |
| Р | ADA DOOR PUSHPAD | | | | | | |
| | PUSHBUTTON | | | | | | |
| | MOTOR CONNECTION | | | | | | |
| $\frac{1}{(J)}$ | JUNCTION BOX, WALL / CEILING MOUNTED | | | | | | |
| | | | | | | | |
| J | FLOOR FURNITURE FEED/J-BOX | | | | | | |
| FSD | FIRE SMOKE DAMPER WITH SINGLE POLE DISCONNECT | | | | | | |
| FSD | FIRE SMOKE DAMPER WITH SINGLE POLE DISCONNECT | | | | | | |
| | FIRE SMOKE DAMPER WITH SINGLE POLE DISCONNECT ECEPTACLE SUBSCRIPT LEGEND | | | | | | |
| | | | | | | | |
| | ECEPTACLE SUBSCRIPT LEGEND | | | | | | |
| | ECEPTACLE SUBSCRIPT LEGEND AC = ABOVE COUNTER +XX "AFF" = SPECIAL MOUNTING HEIGHT D = DEDICATED CIRCUIT | | | | | | |
| | ECEPTACLE SUBSCRIPT LEGEND AC = ABOVE COUNTER +XX "AFF" = SPECIAL MOUNTING HEIGHT | | | | | | |
| | ECEPTACLE SUBSCRIPT LEGEND AC = ABOVE COUNTER +XX "AFF" = SPECIAL MOUNTING HEIGHT D = DEDICATED CIRCUIT G = GROUND FAULT CIRCUIT INTERRUPTER IG = ISOLATED GROUND | | | | | | |
| | ECEPTACLE SUBSCRIPT LEGEND AC = ABOVE COUNTER +XX "AFF" = SPECIAL MOUNTING HEIGHT D = DEDICATED CIRCUIT G = GROUND FAULT CIRCUIT INTERRUPTER IG = ISOLATED GROUND WP = WEATHERPROOF | | | | | | |
| | ECEPTACLE SUBSCRIPT LEGEND AC = ABOVE COUNTER +XX "AFF" = SPECIAL MOUNTING HEIGHT D = DEDICATED CIRCUIT G = GROUND FAULT CIRCUIT INTERRUPTER IG = ISOLATED GROUND | | | | | | |
| | AC = ABOVE COUNTER +XX "AFF" = SPECIAL MOUNTING HEIGHT D = DEDICATED CIRCUIT G = GROUND FAULT CIRCUIT INTERRUPTER IG = ISOLATED GROUND WP = WEATHERPROOF a = SUBSCRIPT(S) INDICATES | | | | | | |
| | ECEPTACLE SUBSCRIPT LEGEND AC = ABOVE COUNTER +XX"AFF" = SPECIAL MOUNTING HEIGHT D = DEDICATED CIRCUIT G = GROUND FAULT CIRCUIT INTERRUPTER IG = ISOLATED GROUND WP = WEATHERPROOF B = SUBSCRIPT(S) INDICATES SWITCH CONTROL 6 = NUMBER INDICATES CIRCUIT | | | | | | |
| RE | AC = ABOVE COUNTER +XX "AFF" = SPECIAL MOUNTING HEIGHT D = DEDICATED CIRCUIT G = GROUND FAULT CIRCUIT INTERRUPTER IG = ISOLATED GROUND WP = WEATHERPROOF a = SUBSCRIPT(S) INDICATES SWITCH CONTROL 6 = NUMBER INDICATES CIRCUIT NUMBER | | | | | | |
| WORK | AC = ABOVE COUNTER +XX "AFF" = SPECIAL MOUNTING HEIGHT D = DEDICATED CIRCUIT G = GROUND FAULT CIRCUIT INTERRUPTER IG = ISOLATED GROUND WP = WEATHERPROOF a = SUBSCRIPT(S) INDICATES SWITCH CONTROL 6 = NUMBER INDICATES CIRCUIT NUMBER T = TAMPER RESISTANT TYPE OUTLET | | | | | | |

| | LIGHTING FIXTURE DOWNLIGHT, CEILING (SURFACE OR RECESSED OR PENDANT) MOUNTED | | | | | |
|-------------------|---|--|--|--|--|--|
| | LIGHTING FIXTURE, WALL OR SURFACE MOUNTED | | | | | |
| | LIGHTING FIXTURE, LENGTH AS SHOWN, (SURFACE OR WALL OR RECESSED O PENDANT) MOUNTED | | | | | |
| OR EM EM | EMERGENCY LIGHTING FIXTURE (POWERED FROM EM GENERATOR OR INVERTER OR INTEGRAL BATTERY SYSTEM) | | | | | |
| NLNL | NIGHT LIGHT (UNSWITCHED LIGHTING) | | | | | |
| \Diamond | WALL WASHER, CEILING (SURFACE OR RECESSED OR PENDANT) MOUNTED | | | | | |
| > | LIGHTING FIXTURE(S), POLE MOUNTED | | | | | |
| 0 | CIRCULAR PEDESTRIAN POLE (POST TOP LIGHTING) | | | | | |
| | FIXTURE DESIGNATION: | | | | | |
| F1 | LIGHTING FIXTURE TYPE | | | | | |
| a — 2 | INDICATES SWITCH CONTROL | | | | | |
| | INDICATES CIRCUITING | | | | | |
| DZP | DZP = DAYLIGHTING ZONE PRIMARY DZS = DAYLIGHTING ZONE SECONDARY DZK = DAYLIGHTING ZONE SKYLIGHT | | | | | |
| ▼ | EXIT SIGN, WALL MOUNTED SHADING = ILLUMINATED FACE ARROWS AS SHOWN | | | | | |
| ▼ P | EXIT SIGN, CEILING MOUNTED P = PENDANT MOUNTED SHADING = ILLUMINATED FACE ARROWS AS SHOWN | | | | | |
| → | EXIT SIGN, LOW LEVEL, RECESSED IN WALL. SHADING = ILLUMINATED FACE. ARROWS AS SHOWN +12" AFF TO BOT OF FIXTURE, U.O.N. | | | | | |
| - <mark></mark> a | OCCUPANCY SENSOR, WALL MOUNTED. SUBSCRIPT(S) INDICATES FIXTURE(S) CONTROLLED. a = SINGLE RELAY. a,b = DOUBLE RELAYS. | | | | | |
| | COMBINATION DIMMER & OCCUPANCY SENSOR, WALL MOUNTED | | | | | |
| <\objection="1">a | OCCUPANCY SENSOR, CEILING MOUNTED. SUBSCRIPT(S) INDICATES FIXTURE(S) CONTROLLED. | | | | | |
| a | DAYLIGHTING PHOTOCELL. SUBSCRIPT(S) INDICATES LIGHTING CONTROLLED. | | | | | |
| PC | OUTDOOR PHOTOCELL SENSOR | | | | | |
| LIGH | T SWITCH SUBSCRIPT LEGEND | | | | | |
| \$ a | LOW VOLTAGE CONTROL SWITCH, SUBSCRIPT(S) INDICATES ASSOCIATED LIGHT FIXTURE(S) / EQUIPMENT CONTROLLED. NO SUBSCRIPT INDICATES ALL LIGHT FIXTURE(S) / EQUIPMENT CONTROLLED INSIDE ROOM. MOUNT AT +42" AFF. SUBSCRIPT (K) INDICATES . UNLESS OTHERWISE NOTED. | | | | | |
| | a = SINGLE BUTTON CONTROLLER | | | | | |
| | a,b = MULTI BUTTON CONTROLLER K = KEYED TYPE SWITCH | | | | | |
| | 3 = THREE WAY SWITCH F = COMBINATION FAN LIGHT CONTROL | | | | | |
| | BY MANUFACTURER WP = WATER PROOF | | | | | |
| | OV = OVERRIDE CONTROL SWITCH. PROVIDE LABEL INDICATING "OVERRIDE LTG/REC CONTROL". L = INDICATES LINE VOLTAGE | | | | | |
| | - INDICATES LINE VOLTAGE | | | | | |
| D_a | LOW VOLTAGE DIMMER CONTROL | | | | | |
| | a = SINGLE BUTTON CONTROLLER a,b = MULTI BUTTON CONTROLLER | | | | | |
| | K = KEYED TYPE OR PROVIDE WITH LOCKABLE CLEAR PLASTIC COVER | | | | | |
| | L = INDICATES LINE VOLTAGE | | | | | |

| | ELECTRICAL EQUIPMENT | | | | |
|-----------------|---|--|--|--|--|
| | CONTROL PANEL SURFACE, WALL MOUNTED EXAMPLES: LCP, SECURITY, BMS | | | | |
| | CONTROL PANEL FLUSH, WALL MOUNTED EXAMPLES: LCP, SECURITY, BMS | | | | |
| | PANELBOARD SURFACE, WALL MOUNTED | | | | |
| | PANELBOARD FLUSH MOUNTED | | | | |
| | BUSWAY RISER WITH PLUG IN UNIT | | | | |
| | BUSWAY HORIZONTAL | | | | |
| СТВ | CABLE TAP BOX | | | | |
| Т | STEP DOWN TRANSFORMER | | | | |
| | HEAVY DUTY DISCONNECT SWITCH | | | | |
| | HEAVY DUTY DISCONNECT SWITCH WITH FUSE | | | | |
| | MOTOR STARTER | | | | |
| | COMBINATION MOTOR STARTER/DISCONNECT SWITCH | | | | |
| VFD | VARIABLE FREQUENCY DRIVE | | | | |
| | GROUND BUS BAR | | | | |
| | GROUND ROD | | | | |
| CR | ACCESS CONTROL CARD READER BACK BOX | | | | |
| \$ xx | MS = MOTORIZED SHADE CONTROLLER (FBO) PS = PROJECTION SCREEN CONTROLLER (FBO) | | | | |
| \$ _T | THERMAL OVERLOAD/DISCONNECT SWITCH | | | | |
| EPO | RED PUSH BUTTON MUSHROOM TYPE WITH CLEAR LEXAN PROTECTIVE SHROUD COVER. EPO = EMERGENCY POWER OFF | | | | |
| S | SINGLE LINE DIAGRAM | | | | |
| G | GENERATOR | | | | |
| | CIRCUIT BREAKER | | | | |
| | SWITCH AND FUSE | | | | |
| <<>> | DRAWOUT TYPE CIRCUIT BREAKER | | | | |
| < <u></u> | DRAWOUT TYPE SWITCH AND FUSE | | | | |
| СВ | CIRCUIT BREAKER IN ENCLOSURE | | | | |
| { | CURRENT TRANSFORMER | | | | |
| (M) | CURRENT TRANSFORMER AND KWH METER | | | | |
| —GFP | GROUND FAULT PROTECTION RELAY | | | | |
| SPD | SURGE PROTECTIVE DEVICE | | | | |
| | NORMALLY OPEN CONTACT | | | | |
| | NORMALLY CLOSED CONTACT | | | | |
| | TRANSFORMER | | | | |
| N O OE | AUTOMATIC TRANSFER SWITCH | | | | |
| LSIG | LONG TIME / SHORT TIME / INSTANTANEOUS / GROUND FAULT PROTECTION | | | | |
| | ENERGY METER | | | | |
| <u> </u> | | | | | |
| N E | AUTOMATIC TRANSFER SWITCH WITH BYPASS ISOLATION | | | | |

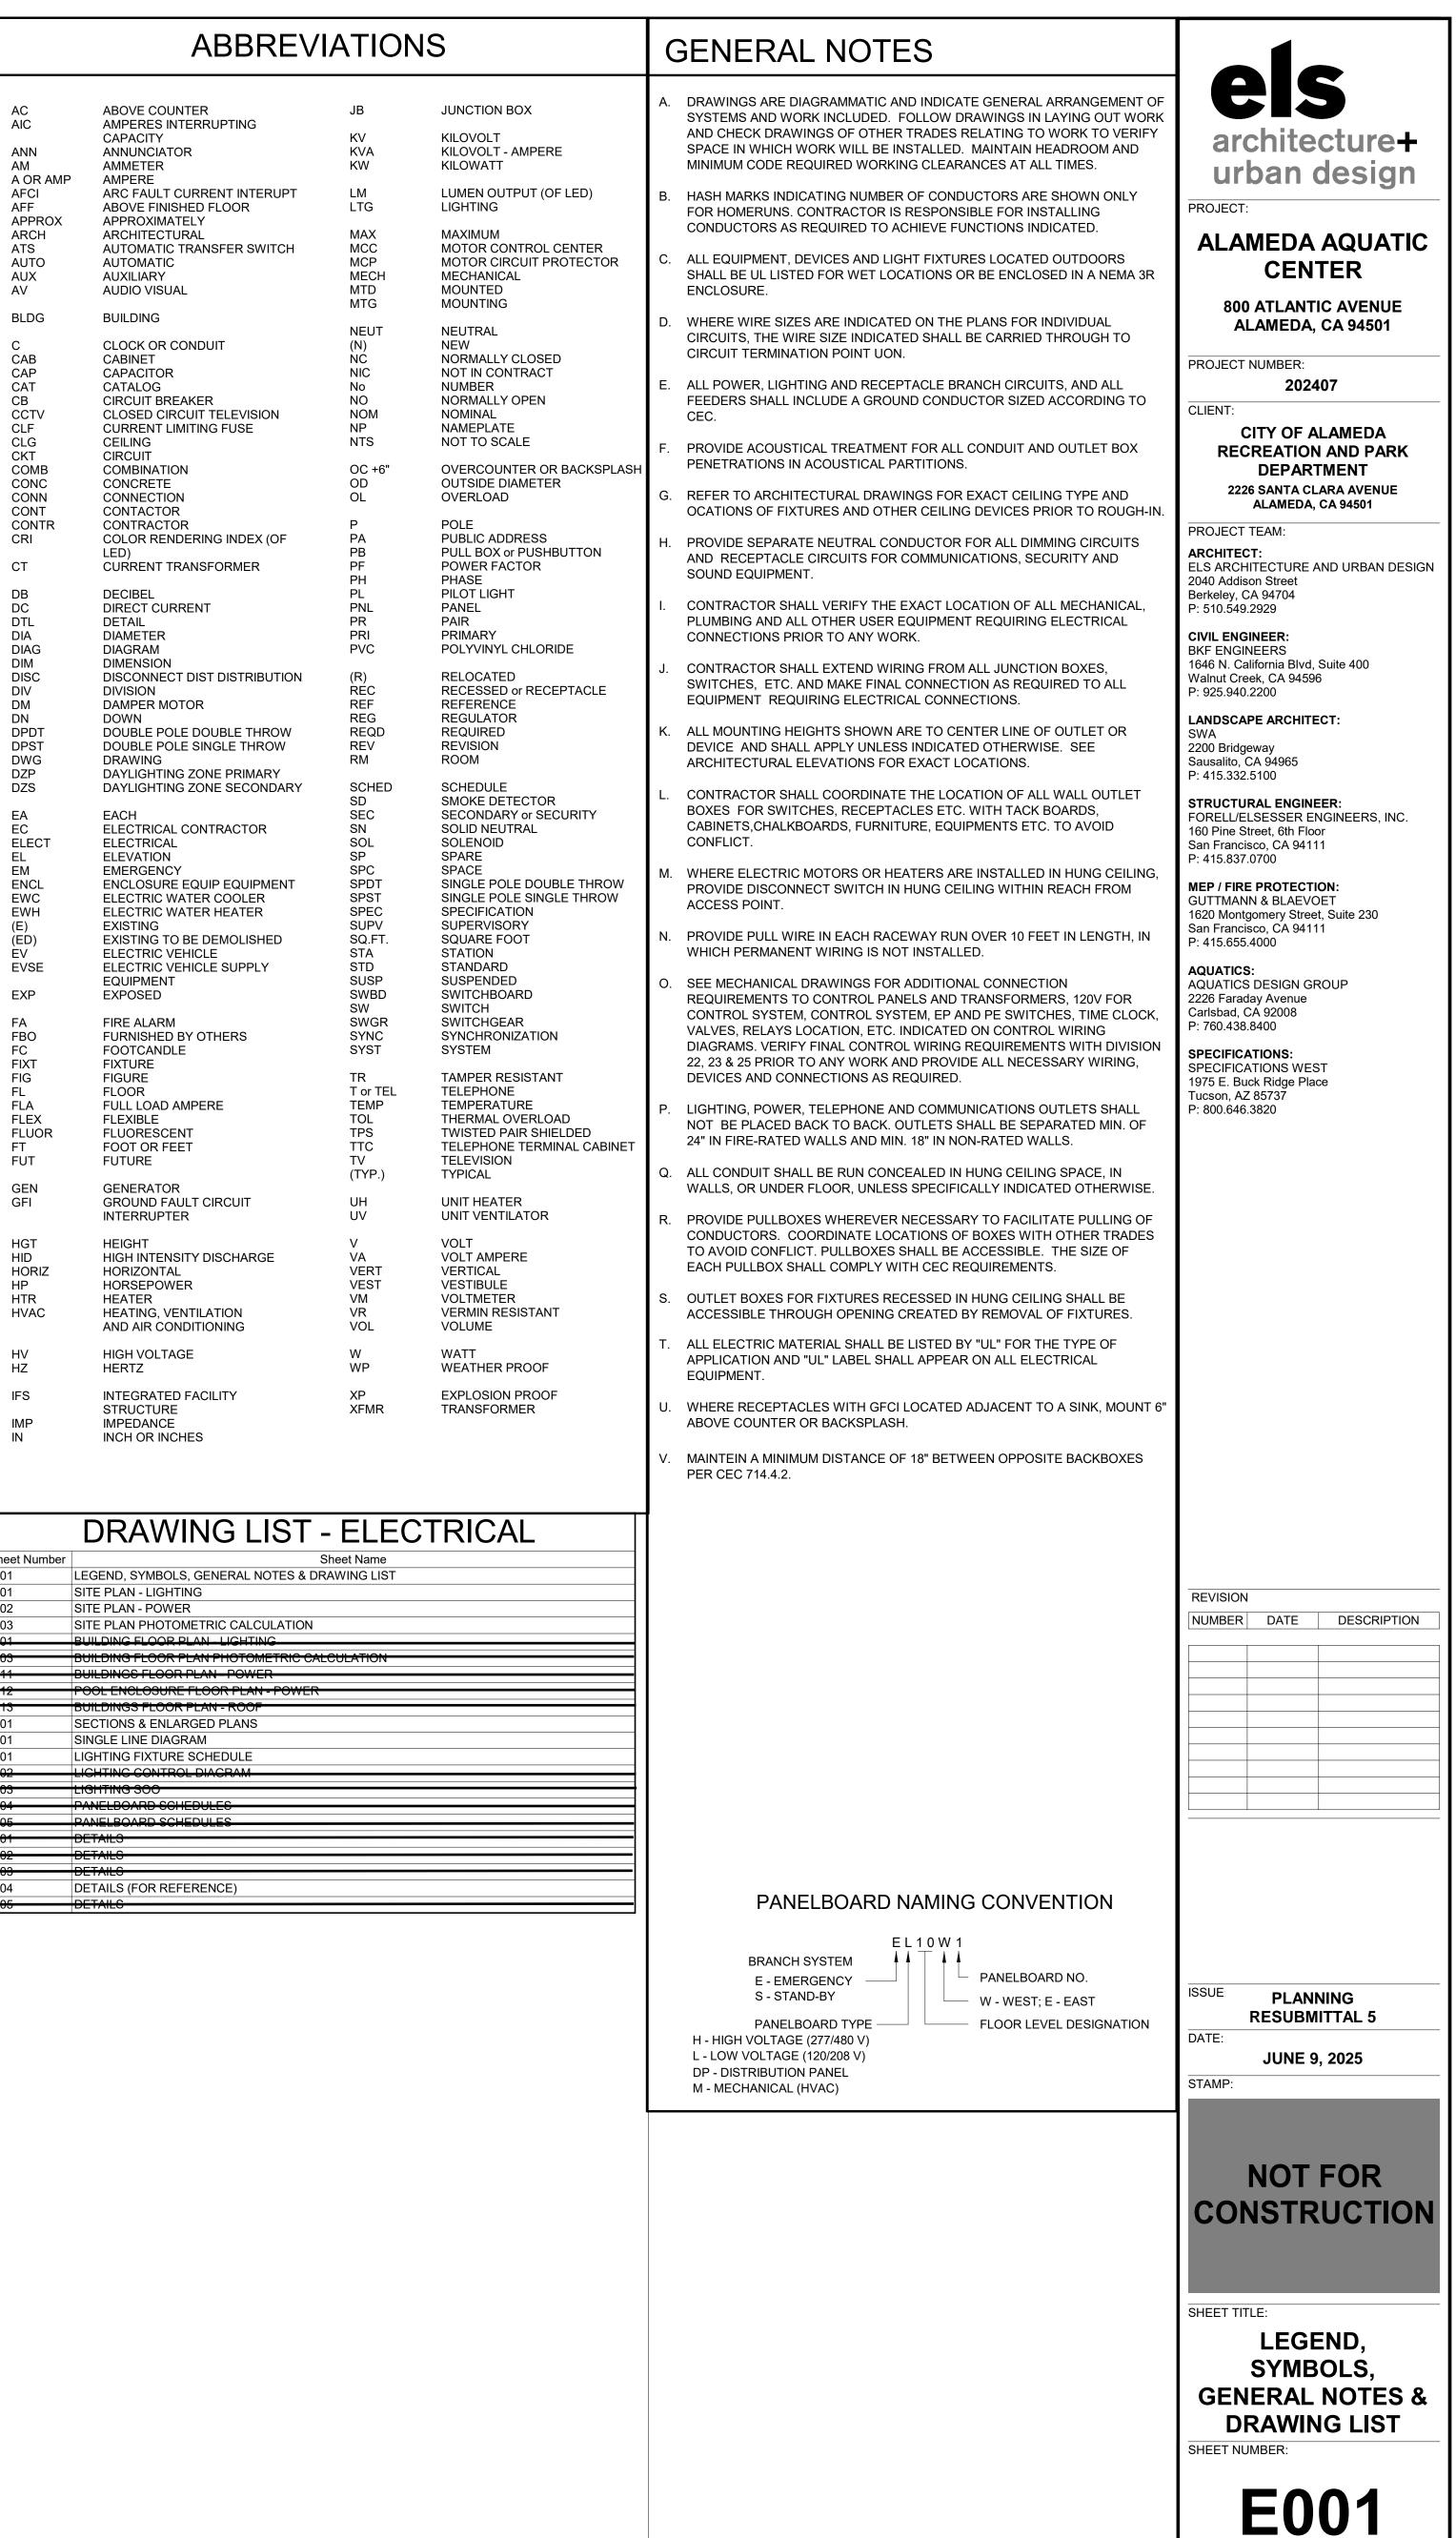

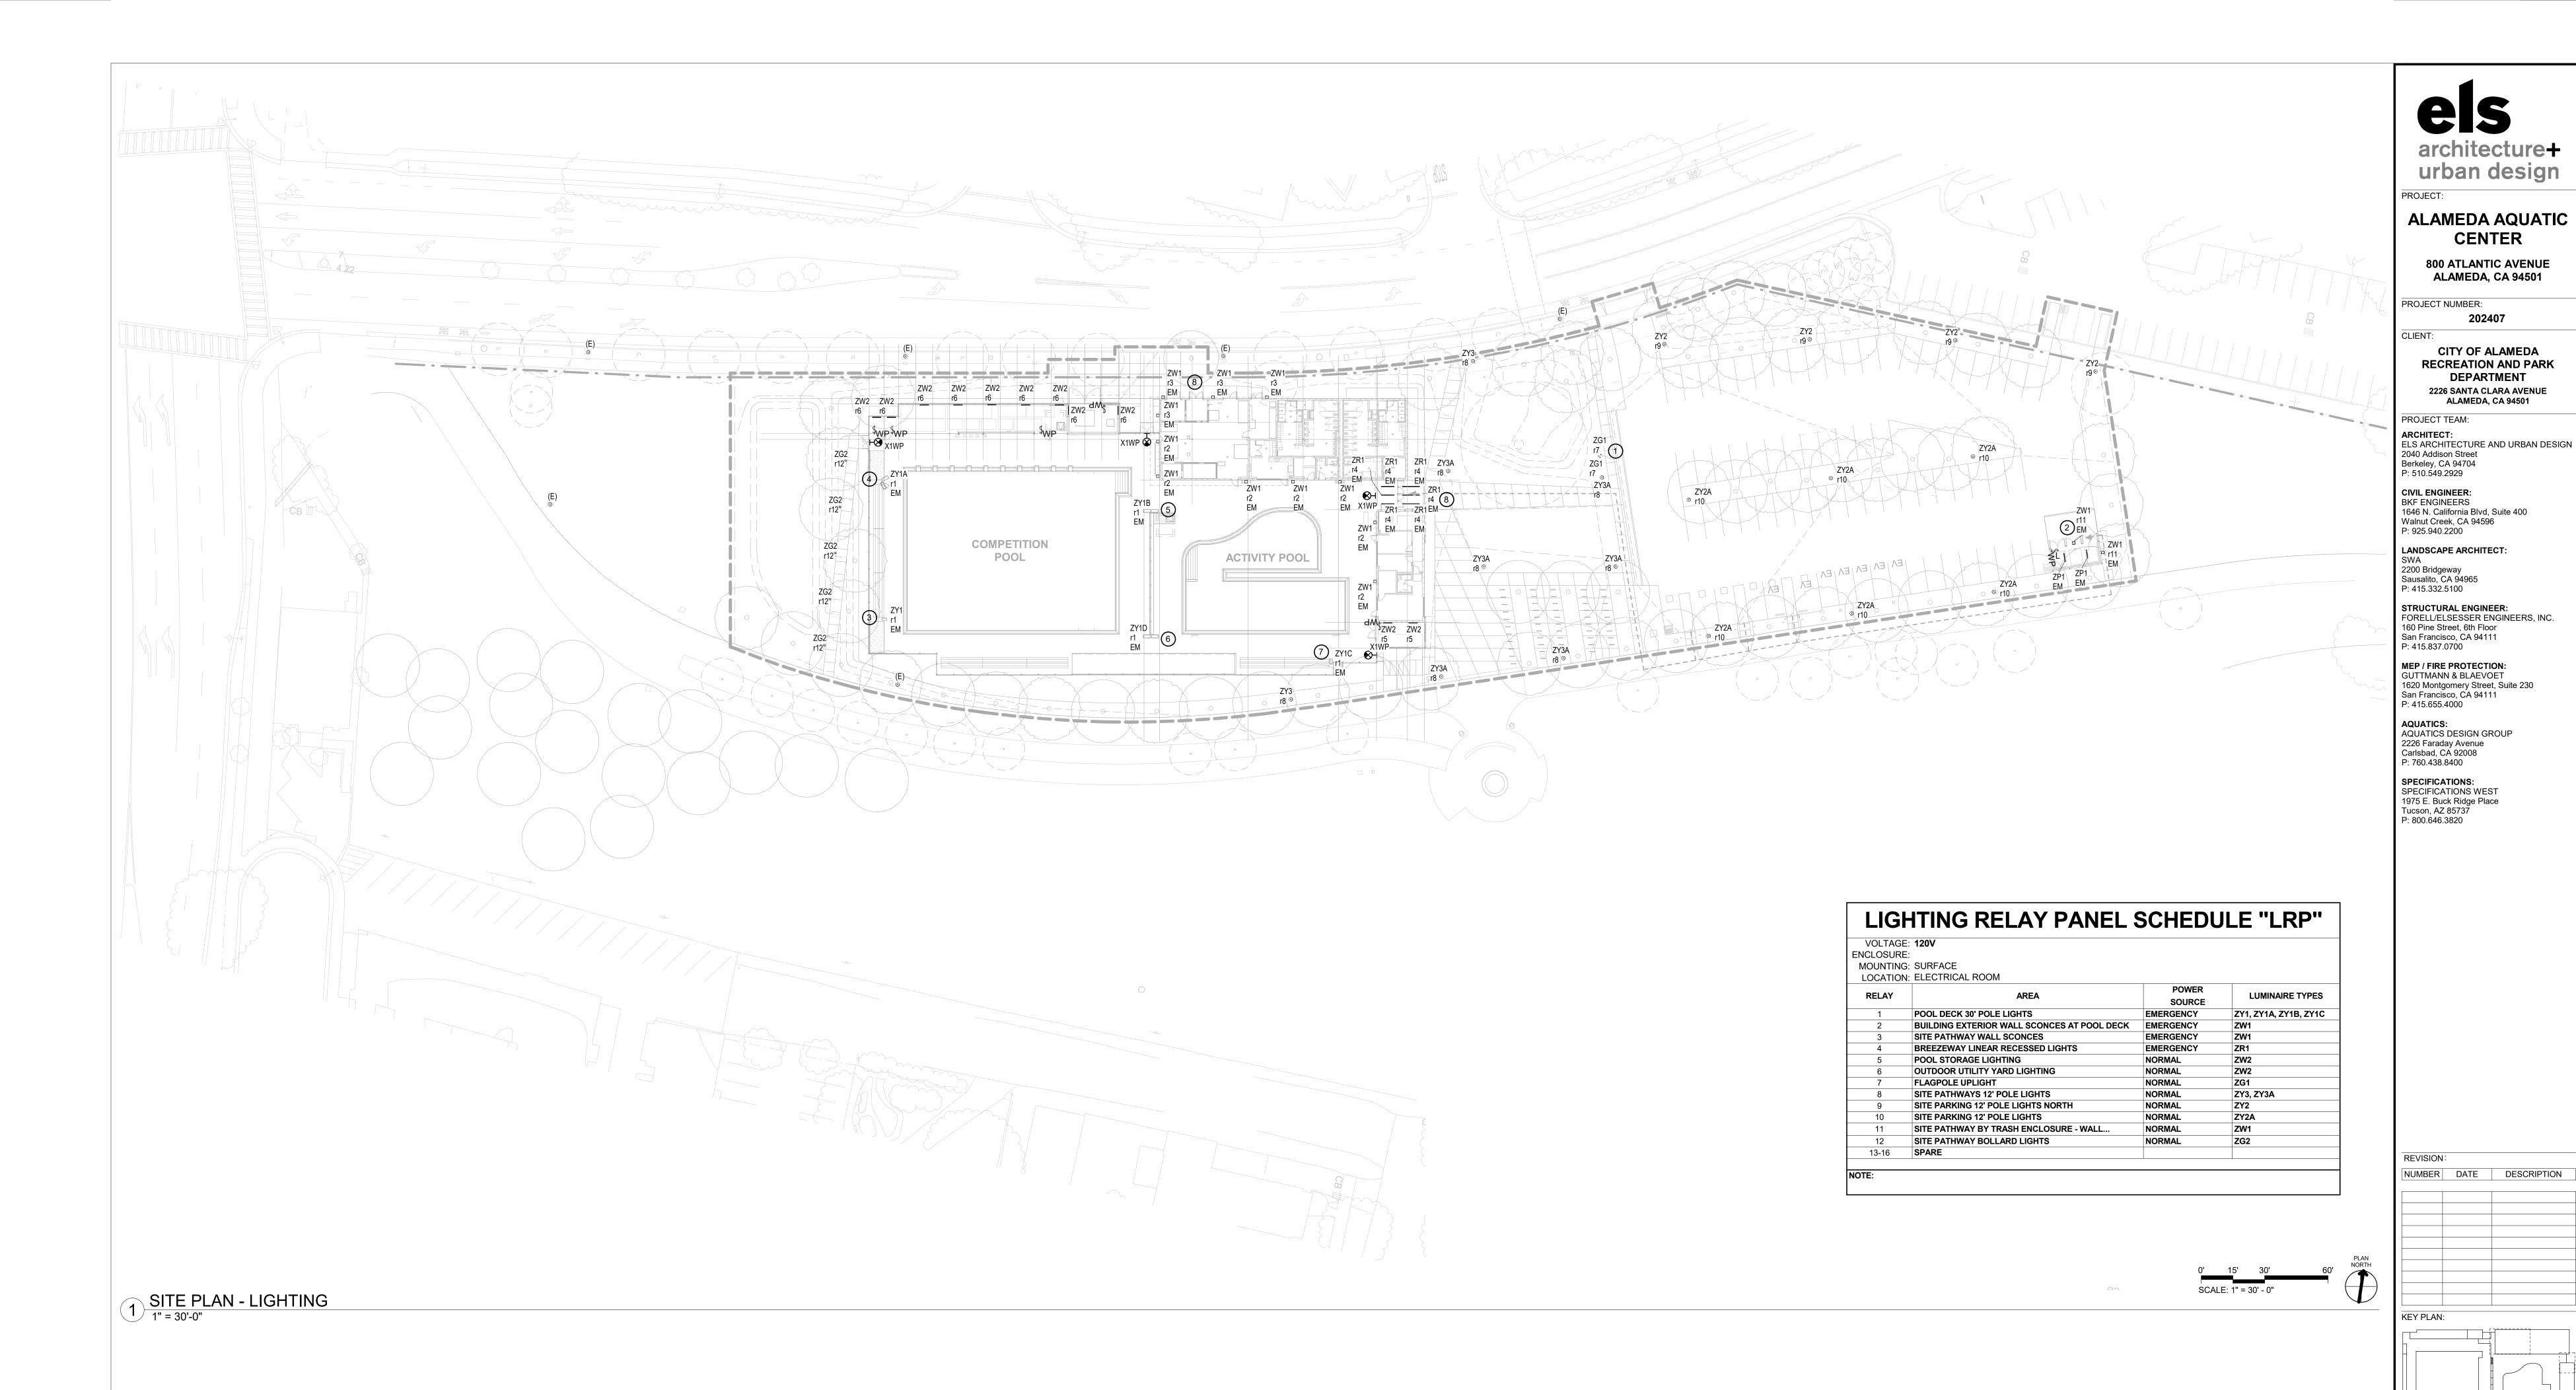

EXTERIOR LIGHTING FIXTURES



TYPE ZG1 **BK LIGHTING** HP2 LED





DAY BRITE VAPORLUME

TYPE ZR1



FINELITE HP2

TYPE ZW1 BEGA 22449



GARDCO POWERFORM

TYPE ZY1, ZY1A, TYPE ZY2, ZY2A, ZY1B, ZY1C, ZY1D ZY3, ZY3A

VISIONAIRE PRE 2 M

SHEET NOTES

- 1 FLAGPOLE LIGHT TYPE ZG1 TO BE INSTALLED AT THE BASE OF THE POLE, PER DETAIL #2 ON SHEET L5.01. AIM LIGHTS POST INSTALLATION
- TOWARDS THE FLAG. 2 TYPE ZW1 TO BE SURFACE MOUNTED TO THE SIDE OF THE SLOPED METAL DECK, RAISING IT'S MOUNTING HEIGHT ABOVE THE +8"-0" AFF DIRECTION STATED IN THE FIXTURE SCHEDULE ON SHEET E601. REFER TO ELEVATIONS 6 AND 7 ON SHEET A120 FOR MOUNTING HEIGHTS.
- REFER TO FIXTURE SCHEDULE ON SHEET E601 FOR SPECIFICATION. HEAD 1 (H1) IS CLOSER TO THE OUTDOOR UTILITY YARD AND TILTED UP 17 DÈGREES. HEAD 2 (H2) IS TILTED UP 16 DEGREES. C/L OF POLE TO BE ORIENTED 22 DEGREES TOWARDS THE OUTDOOR UTILITY YARD SUCH

THAT HEADS ARE ORIENTED WITH RESPECT TO THE EDGE OF THE POOL

- AS SHOWN IN DRAWING. (5) REFER TO FIXTURE SCHEDULE ON SHEET E601 FOR SPECIFICATION. HEAD

 (6) ALL EXTERIOR LIGHTING ARE CONTROLLED BY LIGHTING RELAY PANEL LR

 (7) PER INDICATED RELAY NUMBER # ON PLAN (TYPICAL UNLESS OTHERWISE) 1 (H1) IS AIMED TOWARDS THE ACTIVITY POOL AND TILTED UP 25
- DÈGREES. HEAD 2 (H2) IS AIMED TOWARDS THE COMPETITION POOL AND TILTED UP 12 DEGREES. 6 REFER TO FIXTURE SCHEDULE ON SHEET E601 FOR SPECIFICATION. HEAD 1 (H1) IS AIMED TOWARDS THE ACTIVITY POOL AND TILTED UP 20
- DÈGREES. HEAD 2 (H2) IS AIMED TOWARDS THE COMPETITION POOL AND TILTED UP 12 DEGREES.
- 7 REFER TO FIXTURE SCHEDULE ON SHEET E601 FOR SPECIFICATION. HEAD IS TILTED UP 18 DEGREES. 8 LIGHTING FOR SIGNAGE HERE IS PROVIDED BY THE SIGNAGE VENDOR. REFER TO ARCHITECTURAL DRAWINGS (SHEETS A931 TO A934) FOR MORE FOR EACH SPACE.


GENERAL NOTES

- 1. ALL WALL AND CONCRETE SLAB PENETRATIONS SHALL BE SEALED AS REQUIRED TO MAINTAIN ORIGINAL FIRE RATING. REFER TO ARCHITECTURAL
- DRAWINGS FOR WALL RATING INFORMATION. 2. PROVIDE A SEPARATE NEUTRAL WIRE FOR EACH CIRCUIT.
- 3. PROVIDE A GROUND WIRE IN EACH CONDUIT.

UNDERGROUND PVC CONDUIT SIZE AS MINIMUM.

- REFER TO FIXTURE SCHEDULE ON SHEET E601 FOR SPECIFICATION. HEAD IS TILTED UP 12 DEGREES.


 4. ALL ELECTRICAL PENETRATIONS (FEEDERS AND BRANCH CIRCUITS) SHALL BE GROUPED TOGETHER WITHIN CMU CELLS, WHERE PENETRATING CMU WALLS (COORDINATE WITH STRUCTURAL).
 - 5. ACCESS AND WORKING SPACE SHALL BE PROVIDED AND MAINTAINED ABOUT ALL ELECTRICAL EQUIPMENT TO PERMIT READY AND SAFE OPERATION AND MAINTENANCE OF SUCH EQUIPMENT PER NEC 110.2.
 - 6. ALL EXTERIOR LIGHTING ARE CONTROLLED BY LIGHTING RELAY PANEL "LRP" NOTED).
 - 7. CONTRACTOR TO UPSIZE BRANCH CIRCUIT WIRING ACCORDINGLY FOR VOLTAGE DROP PROVISION. USE #10 CU. WIRING AS MINIMUM. USE 1" DIA.
 - 8. REFER TO LUMINAIRE SCHEDULE ON SHEET E601 FOR COMPLETE LUMINAIRE SPECIFICATIONS.
 - 9. REFER TO LIGHTING CONTROL SEQUENCE OF OPERATIONS ON SHEET E603 FOR ADDITIONAL INFORMATION ON THE TYPE OF CONTROLS TO BE PROVIDED

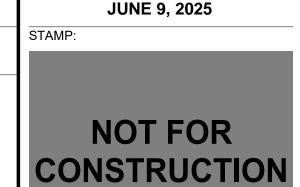


PLANNING RESUBMITTAL 5

SHEET TITLE:

SITE PLAN -**LIGHTING**

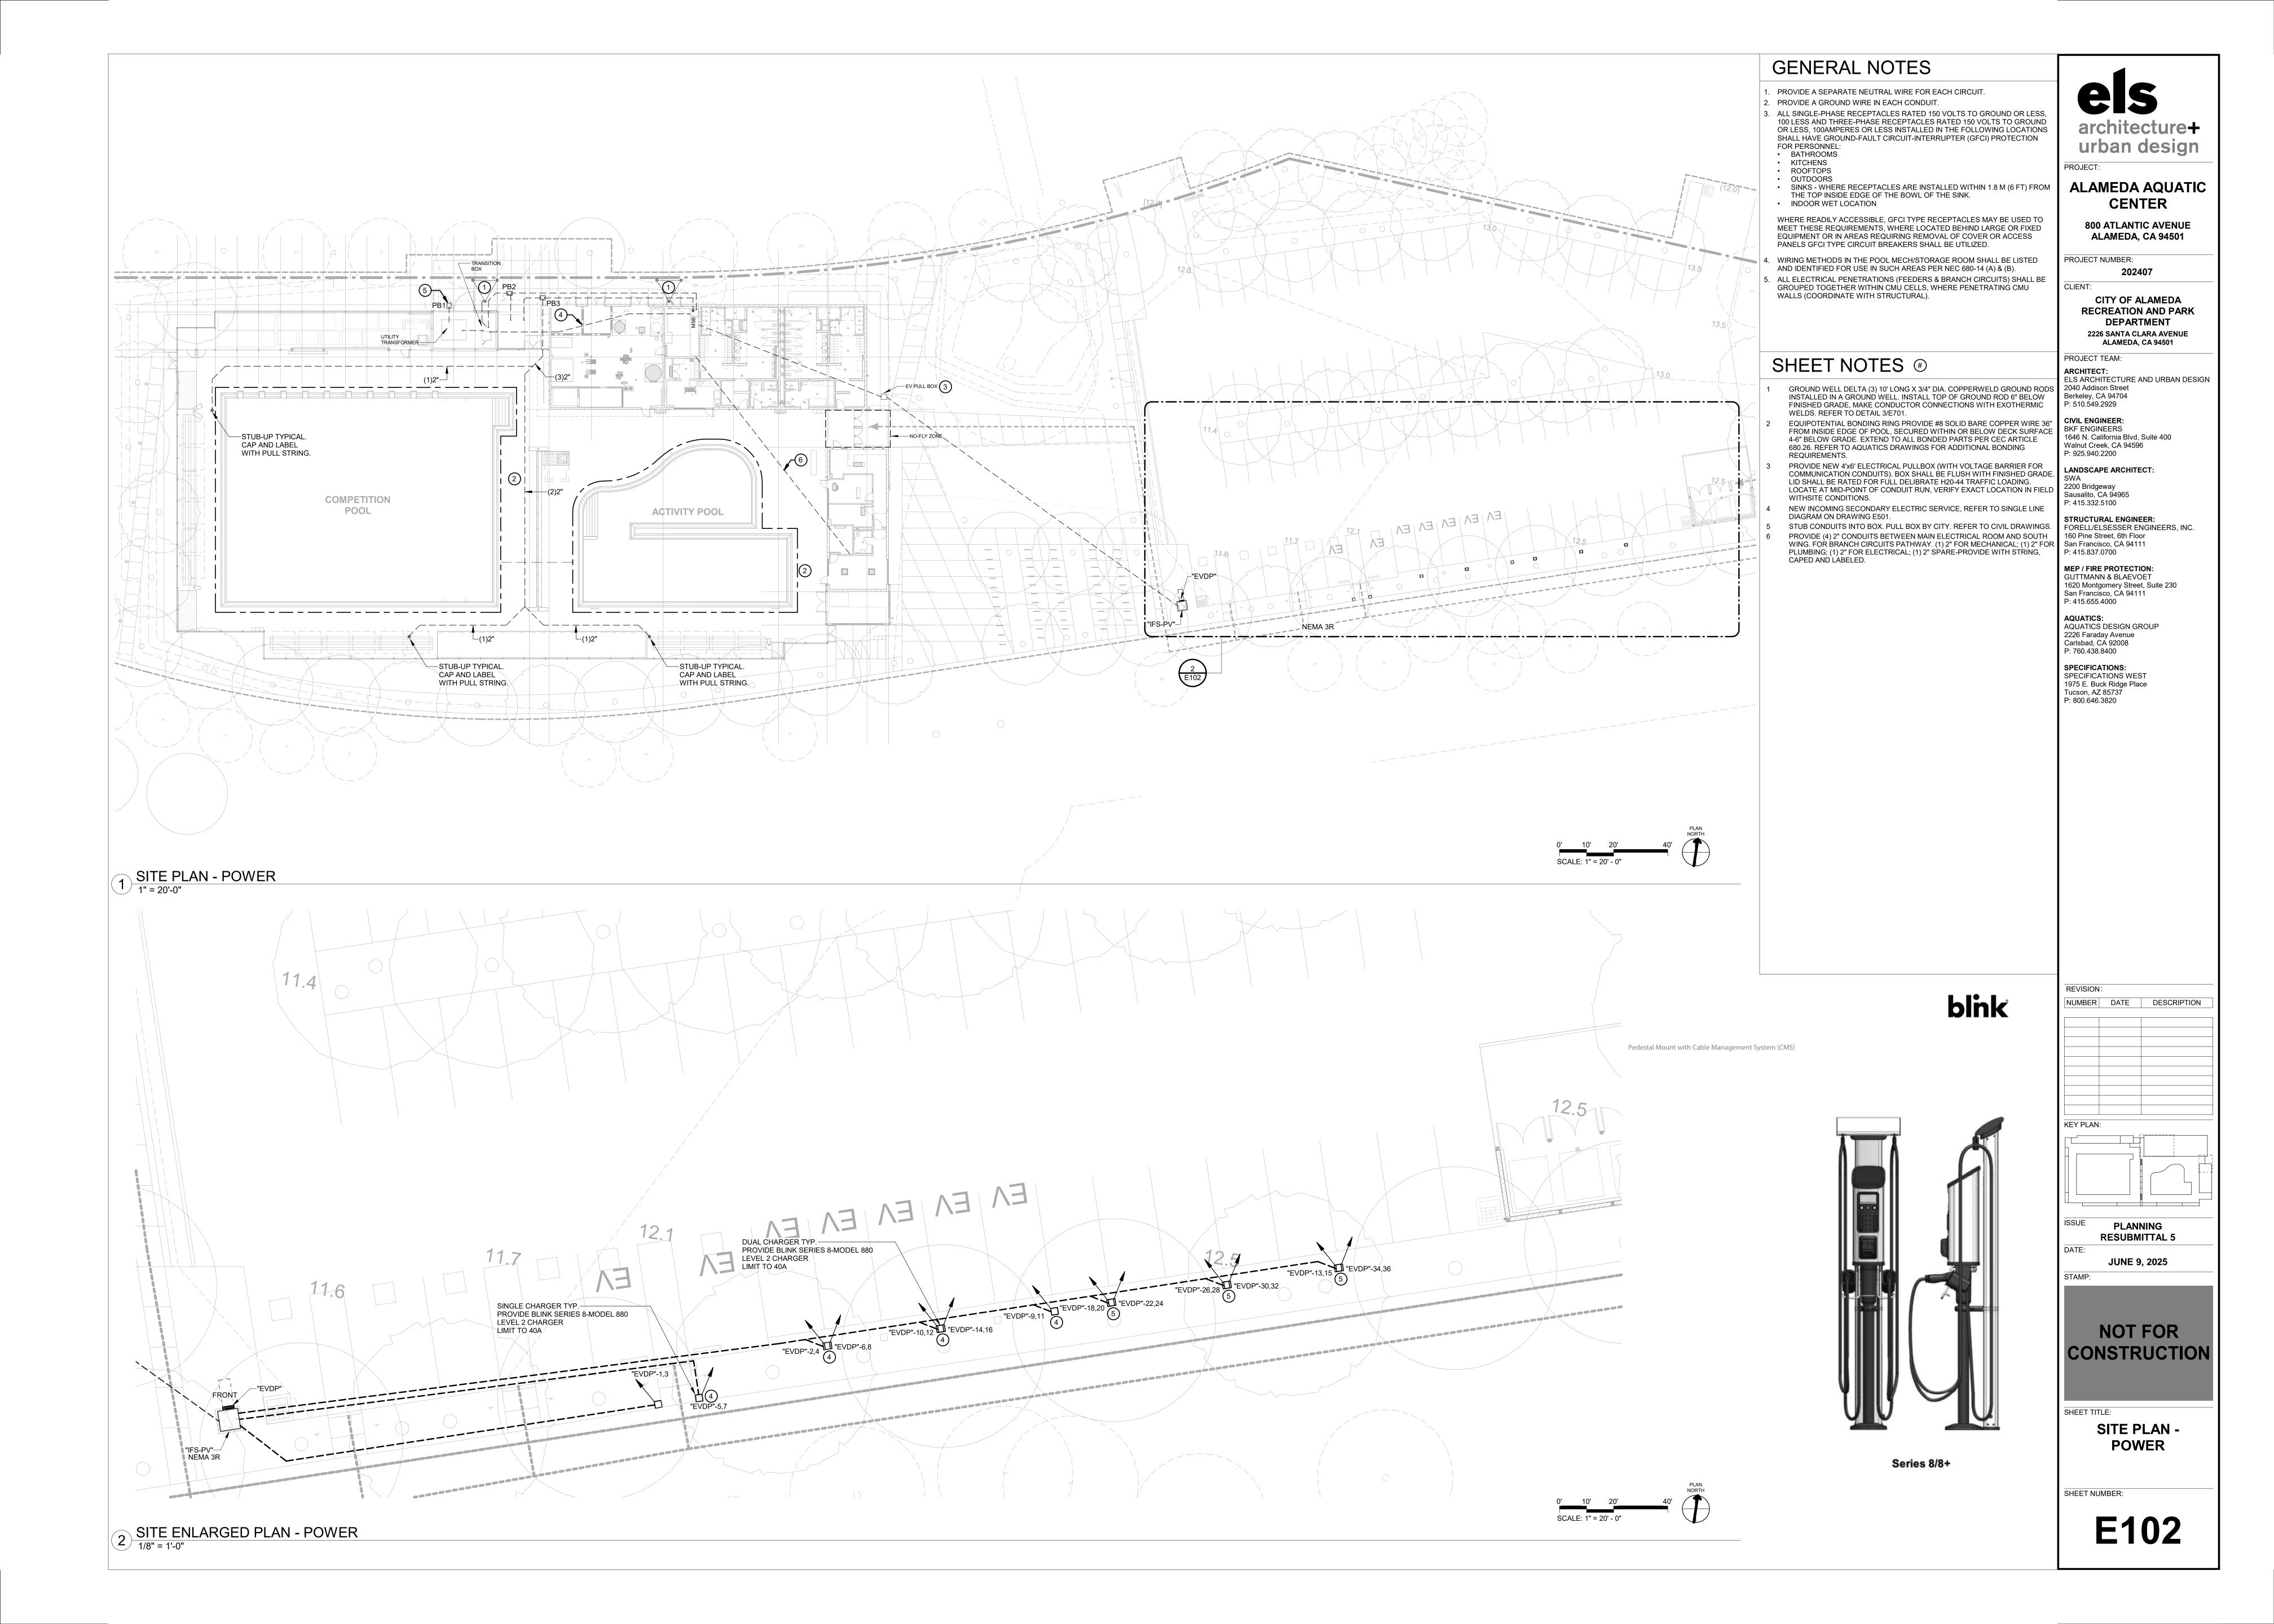

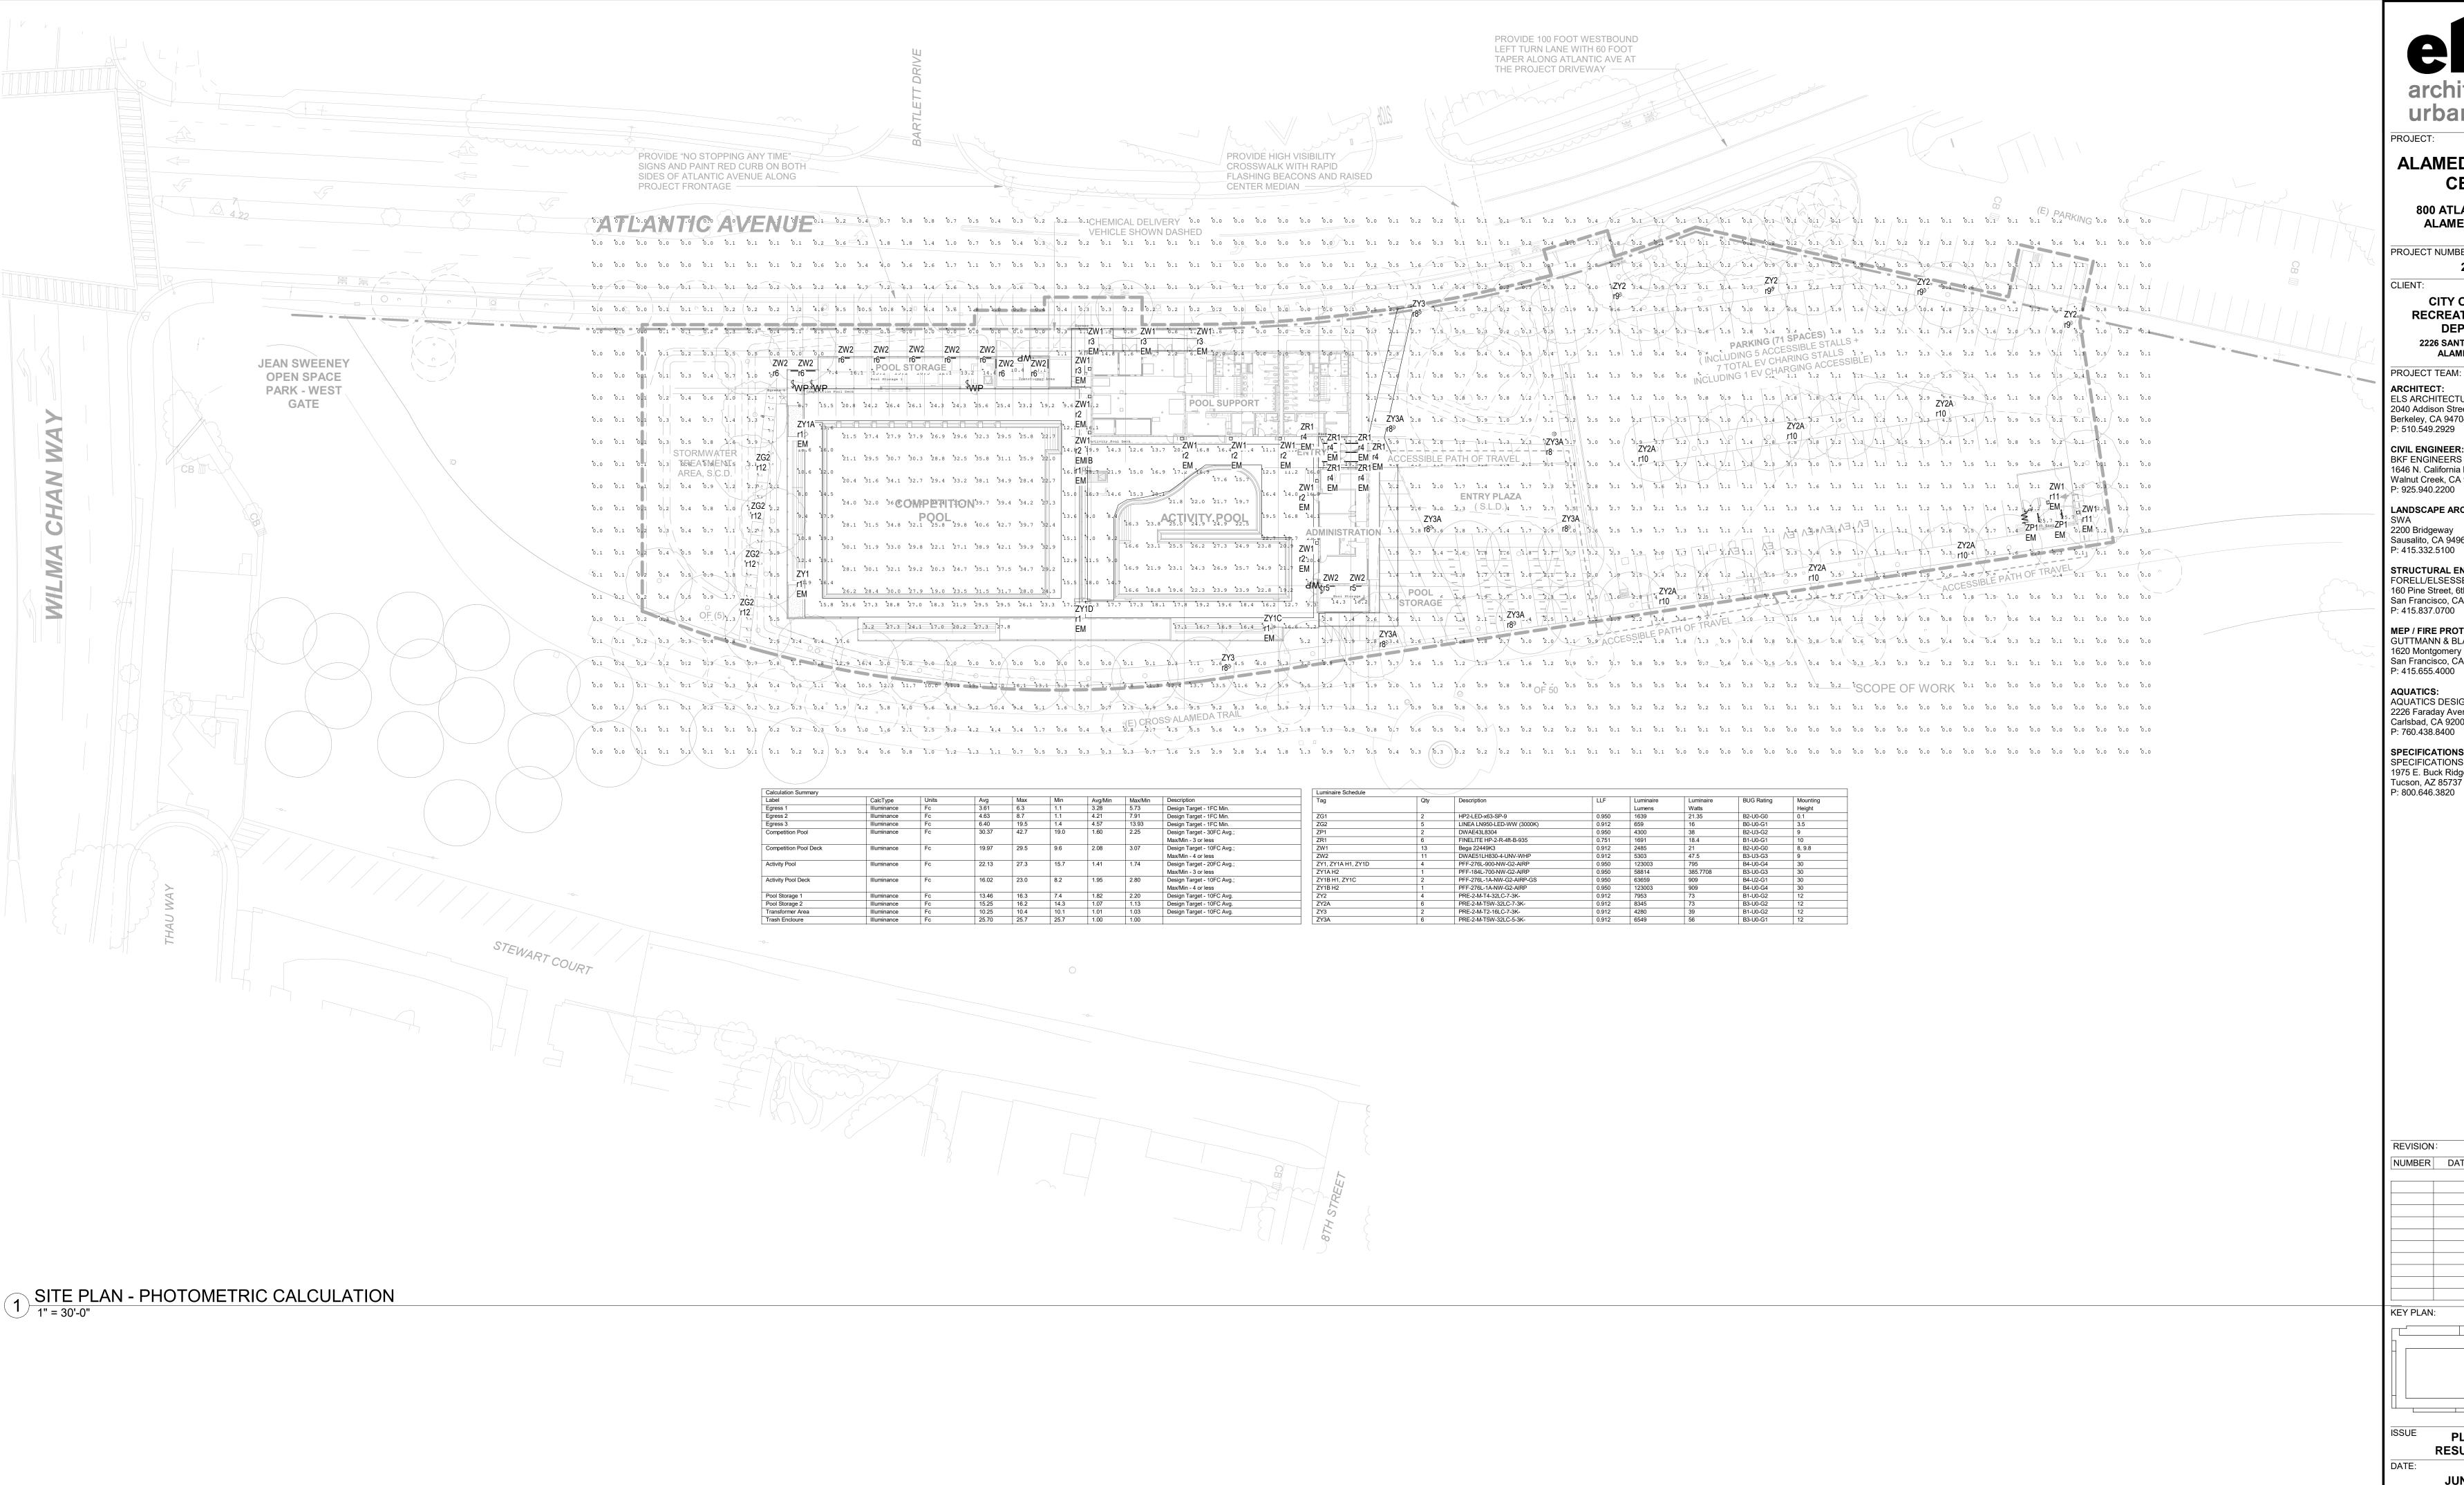

urban design

PROJECT:

ALAMEDA AQUATIC CENTER

800 ATLANTIC AVENUE ALAMEDA, CA 94501

PROJECT NUMBER:

CITY OF ALAMEDA RECREATION AND PARK DEPARTMENT 2226 SANTA CLARA AVENUE ALAMEDA, CA 94501

PROJECT TEAM: ARCHITECT:

ELS ARCHITECTURE AND URBAN DESIGN 2040 Addison Street Berkeley, CA 94704 P: 510.549.2929

CIVIL ENGINEER: BKF ENGINEERS 1646 N. California Blvd, Suite 400 Walnut Creek, CA 94596

P: 925.940.2200 LANDSCAPE ARCHITECT:

2200 Bridgeway Sausalito, CA 94965 P: 415.332.5100

STRUCTURAL ENGINEER: FORELL/ELSESSER ENGINEERS, INC. 160 Pine Street, 6th Floor San Francisco, CA 94111

MEP / FIRE PROTECTION: GUTTMANN & BLAEVOET 1620 Montgomery Street, Suite 230 San Francisco, CA 94111 P: 415.655.4000

AQUATICS: AQUATICS DESIGN GROUP 2226 Faraday Avenue Carlsbad, CA 92008 P: 760.438.8400

SPECIFICATIONS: SPECIFICATIONS WEST 1975 E. Buck Ridge Place Tucson, AZ 85737 P: 800.646.3820

| REVISION: | | | | | | | |
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| NUMBER | DATE | DESCRIPTION | | | | | |
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PLANNING RESUBMITTAL 5


JUNE 9, 2025

NOT FOR CONSTRUCTION

SHEET TITLE:

SITE PLAN **PHOTOMETRIC CALCULATION**

SHEET NUMBER:

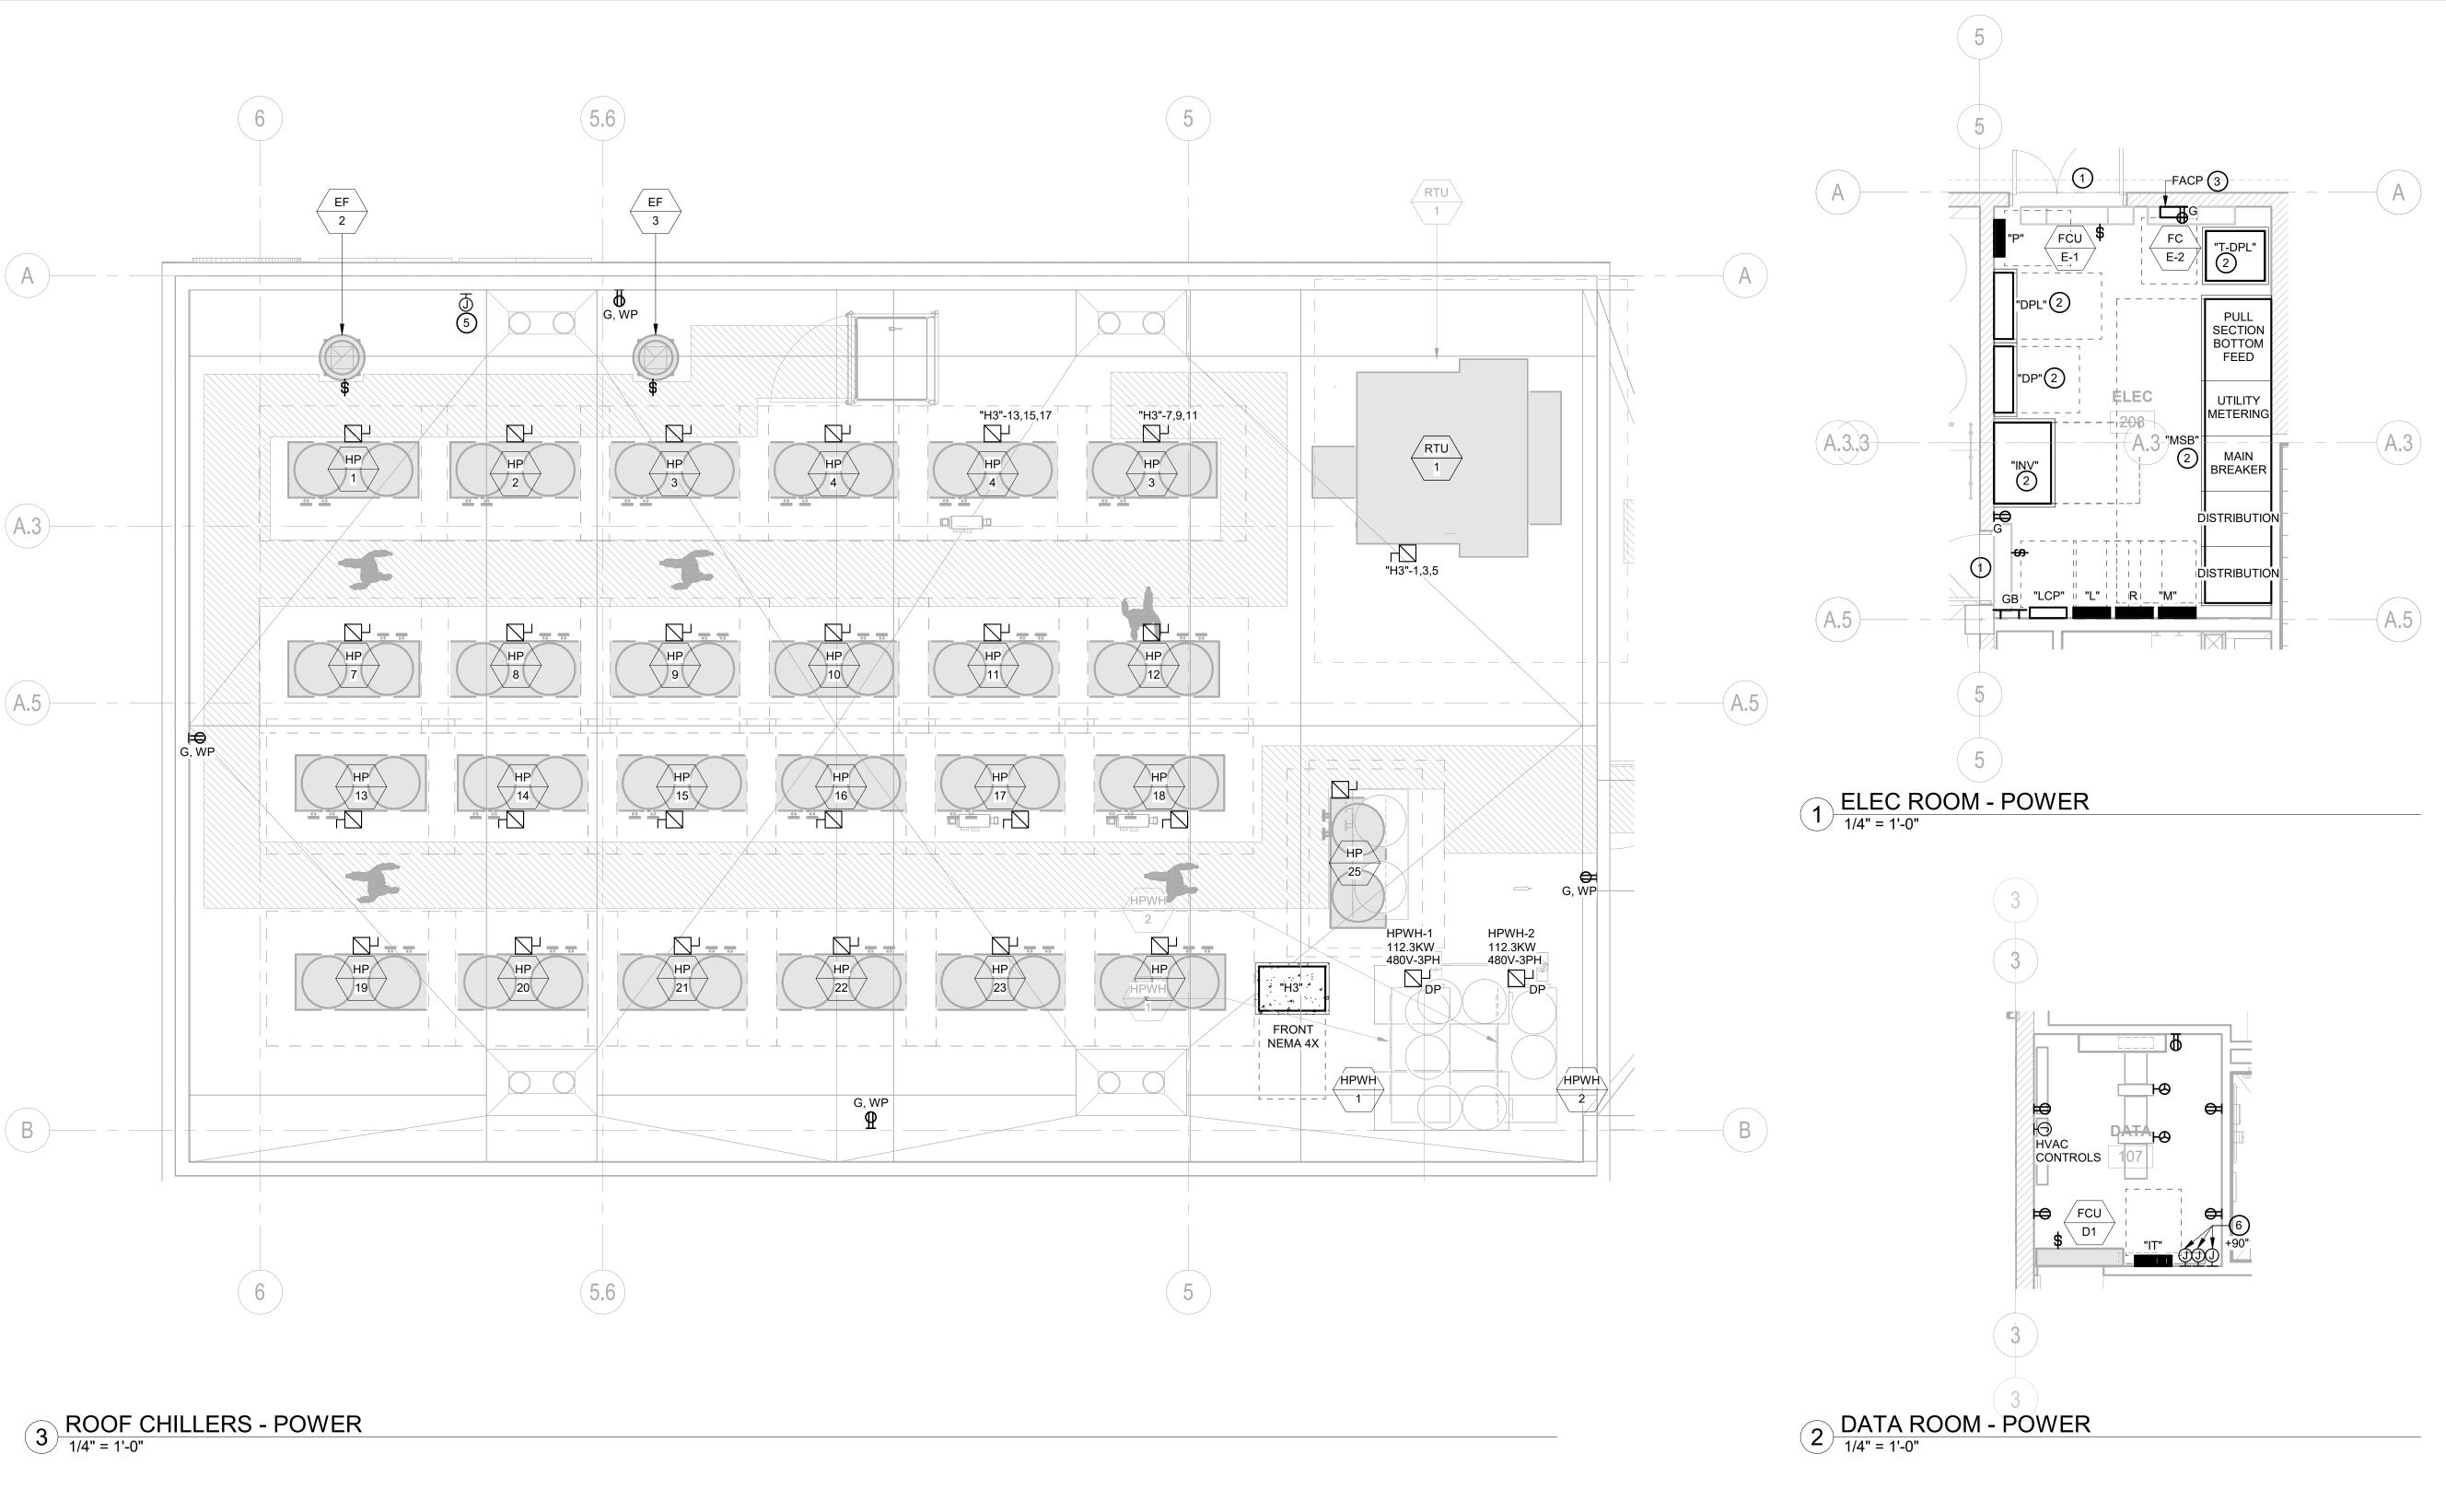

GENERAL NOTES

- 1. PROVIDE A SEPARATE NEUTRAL WIRE FOR EACH CIRCUIT.
- PROVIDE A GROUND WIRE IN EACH CONDUIT.
 ALL SINGLE-PHASE RECEPTACLES RATED 150 VOLTS TO GROUND OR LESS, 100 LESS AND THREE-PHASE RECEPTACLES RATED 150 VOLTS TO GROUND
- OR LESS, 100AMPERES OR LESS INSTALLED IN THE FOLLOWING LOCATIONS SHALL HAVE GROUND-FAULT CIRCUIT-INTERRUPTER (GFCI) PROTECTION FOR PERSONNEL:

 BATHROOMS
- BATHROOMSKITCHENSROOFTOPS
- OUTDOORS
 SINKS WHERE RECEPTACLES ARE INSTALLED WITHIN 1.8 M (6 FT) FROM THE TOP INSIDE EDGE OF THE BOWL OF THE SINK.
 INDOOR WET LOCATION
- WHERE READILY ACCESSIBLE, GFCI TYPE RECEPTACLES MAY BE USED TO MEET THESE REQUIREMENTS, WHERE LOCATED BEHIND LARGE OR FIXED EQUIPMENT OR IN AREAS REQUIRING REMOVAL OF COVER OR ACCESS PANELS GFCI TYPE CIRCUIT BREAKERS SHALL BE UTILIZED.
- WIRING METHODS IN THE POOL MECH/STORAGE ROOM SHALL BE LISTED AND IDENTIFIED FOR USE IN SUCH AREAS PER NEC 680-14 (A) & (B).
 ALL ELECTRICAL PENETRATIONS (FEEDERS & BRANCH CIRCUITS) SHALL BE GROUPED TOGETHER WITHIN CMU CELLS, WHERE PENETRATING CMU WALLS (COORDINATE WITH STRUCTURAL).
- . ANCHORAGE OF ALL ELECTRICAL EQUIPMENT IS DELEGATED DESIGN BY THE CONTRACTOR. SUBMIT STAMPED AND SIGNED DESIGN DRAWINGS AND CALCULATIONS FOR REVIEW.

SHEET NOTES

- 1 DOOR WITH PANIC HARDWARE.
- PROVIDE CONCRETE PAD WITH 2" LIP AROUND EQUIPMENT FOOTPRINT. 4"AFF.
- 3 FACP.
- REFER TO TYPCAL AMP DETAILS ON SHEET E7.04.
- 5 SIGN LIGHTS.
- GROUP BRANCH CIRCUIT/LOADS PER LOAD TYPE OR SYSTEM COMING FROM THE MAIN ELECTRUCAL ROOM. PROVIDE J-BOX FROM WHICH BRANCH CIRCUITS WILL BE DISTRIBUTED. IN ORDER TO AVOID THE NO FLY ZONE.
- 7) PROVIDE L6-30R RECEPTACLE.

els architecture+ urban design

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ALAMEDA, CA 94501

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ALAMEDA, CA 94501

PROJECT TEAM:

ARCHITECT:
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REVISION

NUMBER DATE DESCRIPTION

PLANNING RESUBMITTAL 5

JUNE 9, 2025


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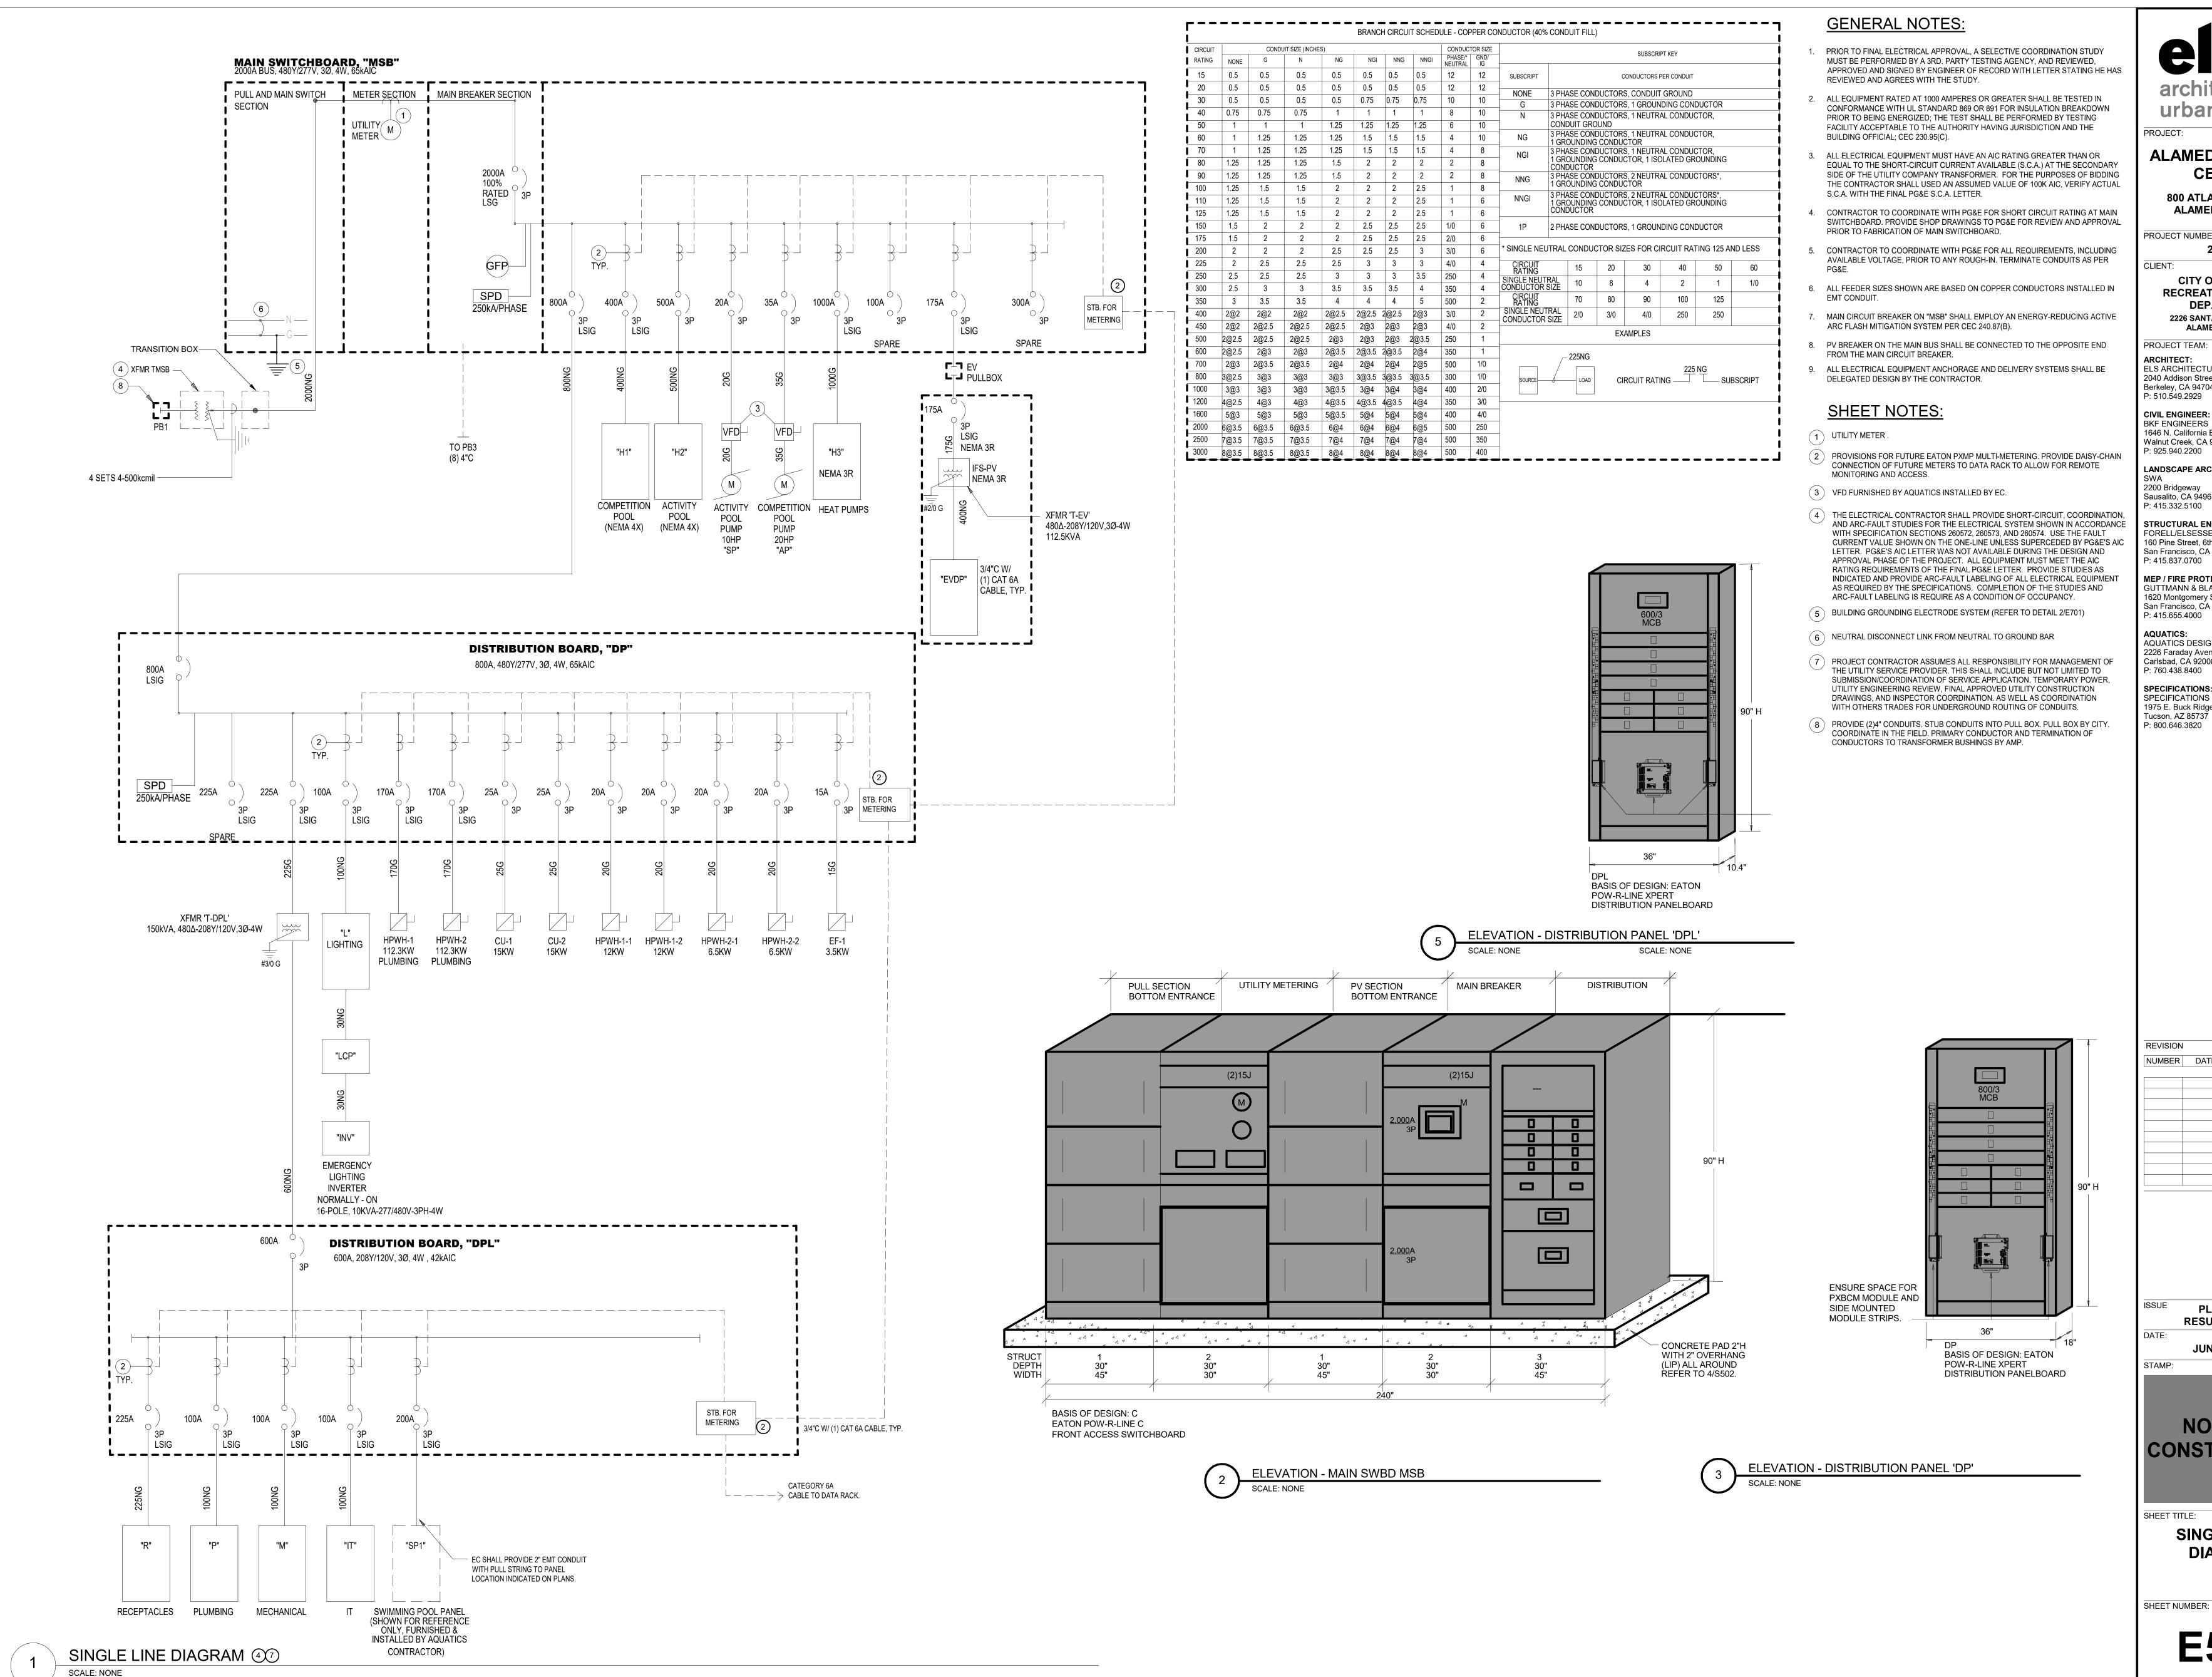
SECTIONS & ENLARGED PLANS

SHEET NUMBER:

E401



FLOOR PLAN - UTILITY ENCLOSURE - POWER

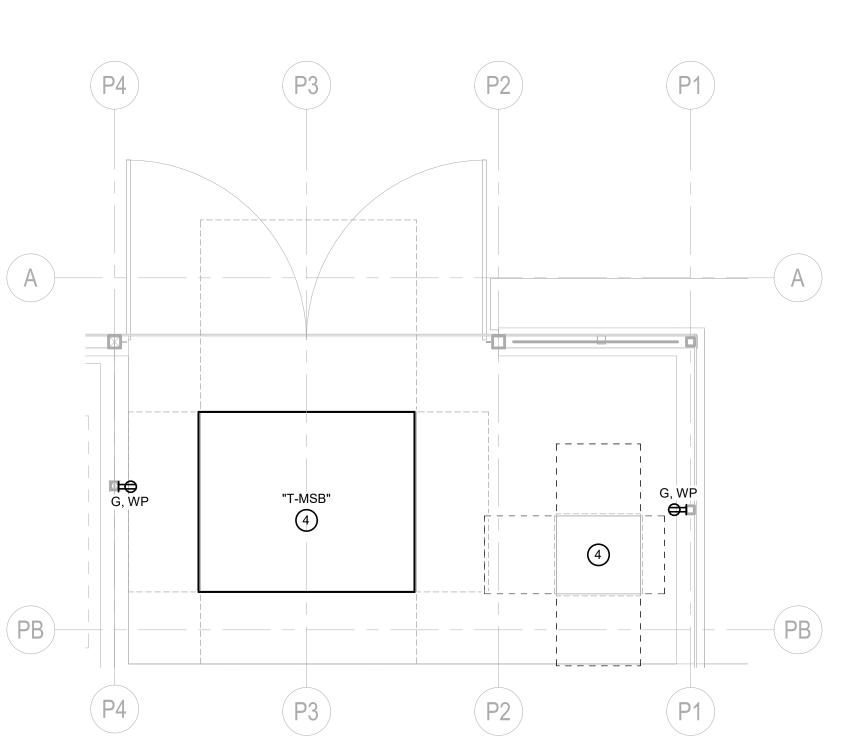

urban design

ALAMEDA AQUATIC

800 ATLANTIC AVENUE ALAMEDA, CA 94501

PROJECT NUMBER:

202407

CITY OF ALAMEDA **RECREATION AND PARK** DEPARTMENT 2226 SANTA CLARA AVENUE

ALAMEDA, CA 94501 PROJECT TEAM:

ARCHITECT: ELS ARCHITECTURE AND URBAN DESIGN 2040 Addison Street Berkeley, CA 94704 P: 510.549.2929

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LANDSCAPE ARCHITECT:

2200 Bridgeway Sausalito, CA 94965 P: 415.332.5100

STRUCTURAL ENGINEER: FORELL/ELSESSER ENGINEERS, INC. 160 Pine Street, 6th Floor San Francisco, CA 94111 P: 415.837.0700

MEP / FIRE PROTECTION: **GUTTMANN & BLAEVOET** 1620 Montgomery Street, Suite 230 San Francisco, CA 94111 P: 415.655.4000

AQUATICS: AQUATICS DESIGN GROUP 2226 Faraday Avenue Carlsbad, CA 92008

P: 760.438.8400 SPECIFICATIONS: SPECIFICATIONS WEST 1975 E. Buck Ridge Place Tucson, AZ 85737

NUMBER DATE DESCRIPTION

PLANNING RESUBMITTAL 5 JUNE 9, 2025

NOT FOR CONSTRUCTION

SHEET TITLE:

SINGLE LINE **DIAGRAM**

SHEET NUMBER:

| | INTERIOR LIGHTING FIXTURE SCHEDULE FIXTURE TAG KEY: G = GROUND MOUNT; P = PENDANT MOUNTED; R = RECESSED; S = SURFACE MOUNTED; T = TRACK OR TRACK HEAD; W = WALL MOUNTED; | | | | | | | | |
|------------|---|---|--|-------------------------------------|------------------------------|-------------|---------------|---|---|
| TYPE | X = EXIT SIGNS; Y = POLE N DESCRIPTION | IOUNTED; Z = EXTE MOUNTING | RIOR - TO PRECEDE OTHE MANUFACTURER/ | R FIXTURE TAG LAMP | S - E.G. ZW1 DRIVER | WOULD BE AN | INPUT | VALL MOUNTED FIXTURE LOCATION FINISH | NOTES |
| P1-4FT | 4'-0" LONG PENDANT MOUNT LINEAR STRIP LIGHT WITH CHAIN HANGER | PENDANT (CEILING MOUNT) BOTTOM OF FIXTURE AT +10'-0" AFF | HE WILLIAMS 75R-4-L50-8-40-VBY-2-DIM-UNV | LED 4,867 LM 4000K, 80 CRI | INTEGRAL 0-10V DIMMING | UNV | WATTS 33 W | DATA STANDARD | |
| P1-8FT | SAME AS TYPE P1-4FT BUT 8 FEET LONG | PENDANT (CEILING MOUNT) BOTTOM OF FIXTURE AT +10'-0" AFF | HE WILLIAMS 75R-4-L100-8-40-VBY-2-DIM-UNV | LED 9,568 LM 4000K, 80 CRI | INTEGRAL 0-10V DIMMING | UNV | 66 W | ELECTRICAL STANDARD | |
| P2 | 24" DIAMETER SUSPENDED ROUND LIGHT WITH DIRECT/INDIRECT OPTIC | PENDANT (CEILING MOUNT) BOTTOM OF FIXTURE AT +9'-0" AFF | FOCAL POINT FSDEP-2-FL-4000DN-500UP-935K -1C-UNV-LD1-C48-HOUSING FINISH | LED 5,500 LM 3500K, 90 CRI | INTEGRAL 0-10V DIMMING | UNV | 42 W | LOCKER ROOM BY ARCHITECT | REFER TO DETAIL 5 ON SHEET E705 FOR MOUNTING DETAILS. |
| R1 | 3.5" DIA RECESSED ROUND DOWNLIGHT | RECESSED (GYP) | FOCAL POINT FLC3D-RO-SW-900L-UNV-LD1-H OUSING TYPE-FACTORY OPTIONS-LC3-RO-SW-900L-935K -DNS-FL1-FINISH-FLANGE FINISH | LED 919 LM 3500K, 90 CRI | INTEGRAL 0-10V DIMMING | UNV | 10 W | VARIOUS BY ARCHITEC | Γ |
| R1A | SAME AS TYPE R1 BUT WITH LOWER LUMEN OUTPUT AND UL WET LISTED LABEL | RECESSED (GYP) | FOCAL POINT FLC3D-RO-SW-700L-UNV-LD1-H OUSING TYPE-OD-LC3-RO-SW-700L-935K -DNS-FL1-FINISH-FLANGE FINISH | LED 721 LM 3500K, 90 CRI | INTEGRAL 0-10V DIMMING | UNV | 8 W | SHOWER STALLS BY ARCHITECT | Г |
| R2 | RECESSED 2X4 LIGHT | RECESSED (ACT) | FINELITE HPR LED-A-2X4-DCO-H-935-277V-SC- CEILING TYPE | LED 5,416 LM 3500K, 90 CRI | INTEGRAL 0-10V DIMMING | 277 V | 40.6 W | LIFEGUARD, STANDARD OFFICES MATTE WHITE | : |
| R3 | 4'-0" LONG RECESSED LIGHT | RECESSED (ACT) | FINELITE HP-2-R-D-4FT-B-935-F-96LG-277- SC-FC-1%-CEILING HARDWARE TYPE-FE-FINISH | LED 423 LM/FT 3500K, 90 CRI | INTEGRAL 0-10V DIMMING | 277 V | 4.6 W/FT | HALLWAY BY ARCHITECT | Г |
| R3A | SAME AS TYPE R3 BUT WITH HIGHER LUMEN OUTPUT | RECESSED (ACT) | FINELITE HP-2-R-D-4FT-V-935-F-96LG-277- SC-FC-1%-CEILING HARDWARE TYPE-FE-FINISH | LED 822 LM/FT 3500K, 90 CRI | INTEGRAL 0-10V DIMMING | 277 V | 9.2 W/FT | TICKETING, MULTIPURPOSE ROOM | Г |
| R4 | RECESSED LINEAR LIGHT | RECESSED (GYP) | FOCAL POINT FSM2L-FL-625LF-935K-1C-UNV-L D1-CEILING CONFIGURATION-FACTORY OPTIONS-WH-LENGTH PER PLAN | LED 625 LM/FT 3500K, 90 CRI | INTEGRAL 0-10V DIMMING | UNV | 5.2 W/FT | LOCKER ROOM STANDARD WHITE | |
| S1-4FT | SAME AS TYPE P1-4FT BUT WITH SURFACE MOUNTING | SURFACE (CEILING) | HE WILLIAMS 75R-4-L50-8-40-DIM-UNV | LED 4,867 LM 4000K, 80 CRI | INTEGRAL 0-10V DIMMING | UNV | 33 W | JANITOR STANDARD | |
| S2-4FT | 4'-0" LONG FULLY ENCLOSED AND GASKETED, NEMA 4X AND IP67 RATED, SURFACE MOUNTED LIGHT | SURFACE (CEILING) | HE WILLIAMS 96-4-L40-8-40-HIAFR-DIM-UNV | LED 4,086 LM 4000K, 80 CRI | INTEGRAL 0-10V DIMMING | UNV | 30 W | CHLORINE, ACID AND POOL MECHANICAL ROOMS | |
| S2-8FT | SAME AS TYPE S2-4FT BUT 8 FEET LONG | SURFACE (CEILING) | HE WILLIAMS 96-8-L80-8-40-HIAFR-DIM-UNV | LED 8,018 LM 4000K, 80 CRI | INTEGRAL 0-10V DIMMING | UNV | 61 W | MECHANICAL ROOM STANDARD | |
| S 3 | SURFACE MOUNTED UNDER CABINET LINEAR LIGHT | SURFACE (UNDERCABINET) | HE WILLIAMS 1SF-LENGTH PER PLAN-LUMENS-8-35-DMA-DIM-U NV | LED 600 LM/FT 3500K, 80 CRI | INTEGRAL 0-10V DIMMING | UNV | 5.9 W/FT | LIFEGUARD STANDARD WHITE | |
| W1-4FT | SAME AS TYPE S1-4FT BUT MOUNTED ON THE WALL | SURFACE (WALL) BOTTOM OF FIXTURE AT +8'-0" AFF | HE WILLIAMS 75R-4-L50-8-40-DIM-UNV | LED 4,867 LM 4000K, 80 CRI | INTEGRAL 0-10V DIMMING | UNV | 33 | TELECOM CLOSET STANDARD | |
| W2 | WALL MOUNTED LINEAR LIGHT WITH DIRECT/INDIRECT OPTIC | SURFACE (WALL) BOTTOM OF FIXTURE ABOVE TILING | FOCAL POINT FSM2BW-ASAS-625DN-375UP-93 5K-1C-UNV-LD1-WM-FACTORY OPTIONS-FINISH-LENGTH PER PLAN | LED 1,000 LM/FT 3500K, 90 CRI | INTEGRAL 0-10V DIMMING | UNV | 9 W/FT | LOCKER ROOM BY ARCHITECT | Г |
| W3 | 24" LONG WALL MOUNTED VANITY LIGHT WITH DIRECT/INDIRECT OPTIC | SURFACE (WALL) BOTTOM OF FIXTURE AT +7'-0" AFF | FOCAL POINT FSM1BV-ASFL-1500L-935K-1C-U NV-LD1-WM-LE-FINISH-2FT | LED 1,500 LM 3500K, 90 CRI | INTEGRAL 0-10V DIMMING | UNV | 11.9 W | RESTROOM BY ARCHITECT | Г |
| X1 | SINGLE FACE EDGE LIT EXIT SIGN WITH GREEN LETTERS ON WHITE BACKGROUND. AC ONLY. PROVIDE ARROWS AS SHOWN ON PLANS. | CEILING OR WALL OR PENDANT BOTTOM OF FIXTURE ABOVE DOORWAY FOR WALL MOUNT | EMERGI LITE PRESTIGE W-LX-1-N-G-W-ARROWS-TRIM-O PTIONS | LED PROVIDED WITH FIXTURE | INTEGRAL | UNV | 1.4 W | INTERIOR EXITS GREEN LETTERS ON WHITE | |
| X1WP | EXTERIOR SINGLE FACE WEATHERPROOF TYPE EXIT SIGN WITH GREEN LETTERS. AC ONLY, UL 924 LISTED. | SURFACE (WALL/FENCE MOUNTED) | HE WILLIAMS EXIT/WET/CP-SF-G-WHT-AC-TP- D | LED PROVIDED WITH FIXTURE | INTEGRAL | 120/277 | 2.7 W | EXTERIOR GREEN EXITS LETTERS ON WHITE | |

1. REFER TO ARCHITECTURAL DRAWINGS FOR EXACT LOCATION, MOUNTING HEIGHT AND MOUNTING REQUIREMENTS OF ALL LUMINAIRES....

2. THE FINISH INDICATED ARE PRELIMINARY, COORDINATE WITH ARCHITECT FOR ALL LUMINAIRE'S FINAL COLOR FINISH SELECTED FROM MANUFACTURER'S STANDARD COLOR PALETTE PRIOR TO ORDERING OF FIXTURES.

3. ALL INTERIOR LUMINAIRES SHALL BE 3500K (KELVIN) TEMPERATURE AND 90 CRI UNLESS NOTED OTHERWISE.

4. PROVIDE COMPLETE MOUNTING ACCESSORIES, SUPPORT BRACKETS, CLIPS, ETC. AS APPLICABLE TO THE FINISH CEILING OR CEILING STRUCTURE AS REQUIRED.

5. PROVIDE ACCESSIBLE WIRING DISCONNECT TO FIXTURE AS REQUIRED.

EXTERIOR LIGHTING FIXTURE SCHEDULE

| TYPE | DESCRIPTION | MOUNTING | MANUFACTURER/ CATALOG # | LAMP | DRIVER | VOLTS | INPUT WATTS | LOCATION | FINISH | NOTES |
|------|---|---|---|---|------------------------------|-------|----------------------|------------------------------------|-------------------------|---|
| ZG1 | 7" DIAMETER IN-GRADE ROUND LIGHT WITH SPOT OPTIC AND GLARE SHIELD | GROUND | BK LIGHTING HP2-LED-TR-x62-SP-FINISH-010- MT-GS | LED 1,378 LM 3000K CCT, 80 CRI | INTEGRAL 0-10V DIMMING | UNV | 20 W | BASE OF FLAGPOLE | BY ARCHITECT | SEE SHEET E101 FOR AIMING INFORMATION. |
| ZG2 | 40.9" TALL BOLLARD LIGHT WITH OCCUPANCY SENSOR | GROUND | HESS LN950-IF-S-SO-30K-DIM-UNV-FIN ISH-OCC; LN950-IF-MK | LED 568 LM 3000K, 80 CRI | INTEGRAL 0-10V DIMMING | UNV | 17 W | EGRESS PATHWAY | BY ARCHITECT | REFER TO DETA ON SHEET E705 MOUNTING DETA |
| ZP1 | SAME AS TYPE ZW2 BUT PENDANT MOUNT AND WITH SENSOR AND LOWER LUMEN OUTPUT | PENDANT (CEILING MOUNT) BOTTOM OF FIXTURE AT +9'-0" AFF | DAYBRITE D-W-A-E-43L-830-4-UNV-MD360W D-WHP | LED 4,300 LM 3000K, 80 CRI | INTEGRAL 0-10V DIMMING | UNV | 38 W | TRASH ENCLOSURE | STANDARD | |
| ZR1 | RECESSED LINEAR LIGHT, DAMP RATED FOR ENTRY CANOPY | RECESSED (METAL PLATE) | FINELITE HP-2-R-D-LENGTH PER PLAN-B-935-F-96LG-277-SC-FC-1 0%-CEILING HARDWARE TYPE-FE-FINISH | LED 423 LM/FT 3500K, 90 CRI | INTEGRAL 0-10V DIMMING | 277 V | 4.6 W/FT | BREEZEWAY | BY ARCHITECT | |
| ZW1 | WEDGE SHAPED WALL SCONCE | SURFACE (WALL) BOTTOM OF FIXTURE AT +8'-0" AFF | BEGA B22449-K3-SLV | LED 2,030 LM 3000K, 90 CRI | INTEGRAL 0-10V DIMMING | UNV | 21 W | ACTIVITY POOL DECK, PATHWAYS | SILVER, BY ARCHITECT | SEE SHEET E10 FOR ADDITIONA MOUNTING HEIC INFORMATION. |
| ZW2 | 4'-0" LONG SURFACE MOUNTED VAPORTIGHT LIGHT WITH WIDE BEAM OPTIC, IP65 AND UL 1598 LISTED | SURFACE (WALL) BOTTOM OF FIXTURE AT +9'-0" AFF | DAYBRITE D-W-A-E-51L-830-4-UNV-WHP | LED 5,100 LM 3000K, 80 CRI | INTEGRAL 0-10V DIMMING | UNV | 47.5 W | OUTDOOR UTILITY YARDS | STANDARD | REFER TO DETA ON SHEET E705 MOUNTING DET |
| ZY1 | 30'-0" TALL POLE LIGHT WITH 5" DIA. ALUM. POLE WITH ONE FLOODLIGHT WITH NEMA 7X5 OPTIC, TO BE SWITCHED ON A FULL POWER ONLY DURING COMPETITIONS AND DIMMED DOWN FOR GENERAL LIGHTING. | | GARDCO PFF-276L-900-NW-G2-SF-AIRP-2 77-DD-FP1-OPTIONS-FINISH; RA5-STB-30-D1-FINISH-GFCI | LED 4000 CCT/70 CRI 109,217 LM | INTEGRAL 0-10V DIMMING | 277 | 795 W | POOL | BY ARCHITECT | SEE SHEET E10 FOR TILT INFORMATION. REFER TO DETA ON SHEET E705 MOUNTING DET |
| ZY1A | SAME AS TYPE ZY1 BUT WITH TWO HEADS AT 90 DEGREES AND LOWER LUMEN OUTPUT | S POLE MOUNTED (30' HIGH POLE) | GARDCO HEAD 1:PFF-276L-900-NW-G2-SF-AIRP; HEAD 2:PFF-184L-700-NW-G2-SF-AIRP; -277-DD-FP2-OPTIONS-FINISH; RA5-STB-30-D2@90-FINISH-GFCI | LED 4000 CCT/70 CRI H1:109,217 LM H2:59,222 LM | INTEGRAL 0-10V DIMMING | 277 | H1:795 W H2:386 W | POOL | BY ARCHITECT | SEE SHEET E10 FOR TILT AND PLACEMENT INFORMATION. REFER TO DETA ON SHEET E705 MOUNTING DET |
| ZY1B | SAME AS TYPE ZY1A BUT WITH TWO HEADS AT 180 DEGREES AND DIFFERENT LUMEN OUTPUTS. HEAD 1 (AIMED AT THE ACTIVITY POOL) TO HAVE GLARE SHIELD. | | GARDCO HEAD 1:PFF-276L-1A-NW-G2-SF-AIRP- GS-PFF-276; HEAD 2:PFF-276L-1A-NW-G2-SF-AIRP; -277-DD-FP2-OPTIONS-FINISH; RA5-STB-30-D2-FINISH-GFCI | LED 4000 CCT/70 CRI H1:63,659 LM H2:123,856 LM | INTEGRAL 0-10V DIMMING | 277 | H1:909 W H2:909 W | POOL | BY ARCHITECT | SEE SHEET E10 FOR TILT INFORMATION. REFER TO DET, ON SHEET E705 MOUNTING DET |
| ZY1C | SAME AS TYPE ZY1 BUT WITH HIGHER LUMEN OUTPUT AND GLARE SHIELD | POLE MOUNTED (30' HIGH POLE) | GARDCO PFF-276L-1A-NW-G2-SF-AIRP-27 7-DD-FP1-OPTIONS-FINISH-GS-P FF-276; RA5-STB-30-D1-FINISH-GFCI | LED 4000 CCT/70 CRI 63,659 LM | INTEGRAL 0-10V DIMMING | 277 | 909 W | POOL | BY ARCHITECT | SEE SHEET E10 FOR TILT INFORMATION. REFER TO DET ON SHEET E709 |
| ZY1D | SAME AS TYPE ZY1B BUT BOTH HEADS WITH SAME LUMEN OUTPUT | POLE MOUNTED (30' HIGH POLE) | GARDCO HEADS: PFF-276L-900-NW-G2-SF-AIRP; -277-DD-FP2-OPTIONS-FINISH; RA5-STB-30-D2-FINISH-GFCI | LED 4000 CCT/70 CRI H1&2:109,217 LM | INTEGRAL 0-10V DIMMING | 277 | H1&2:795 W | POOL | BY ARCHITECT | SEE SHEET E10 FOR TILT INFORMATION. REFER TO DET. ON SHEET E705 MOUNTING DET |
| ZY2 | 12'-0" TALL POLE WITH TYPE 4 OPTIC | POLE MOUNTED (12' HIGH POLE) | VISIONAIRE LIGHTING PRE-2-M-T4-32LC-7-3K-UNV-PT-F INISH-OPTIONS-DIM; RNTA-4R-125-12'-BASE-ANCHOR AGE-T3R-FINISH-OPTIONS | LED 3000 CCT/70 CRI 7,555 LM | INTEGRAL 0-10V DIMMING | UNV | 73 W | PARKING | BY ARCHITECT | REFER TO DET. ON SHEET E709 MOUNTING DET |
| ZY2A | SAME AS TYPE ZY2 BUT WITH TYPE 5 OPTIC | POLE MOUNTED (12' HIGH POLE) | VISIONAIRE LIGHTING PRE-2-M-T5W-32LC-7-3K-UNV-PT -FINISH-OPTIONS-DIM; RNTA-4R-125-12'-BASE-ANCHOR AGE-T3R-FINISH-OPTIONS | LED 3000 CCT/70 CRI 7,928 LM | INTEGRAL 0-10V DIMMING | UNV | 73 W | PARKING | BY ARCHITECT | REFER TO DET ON SHEET E70! MOUNTING DET |
| ZY3 | 12'-0" TALL POLE WITH TYPE 2 OPTIC | POLE MOUNTED (12' HIGH POLE) | VISIONAIRE LIGHTING PRE-2-M-T2-16LC-7-3K-UNV-PT-F INISH-OPTIONS-DIM; RNTA-4R-125-12'-BASE-ANCHOR AGE-T3R-FINISH-OPTIONS | LED 3000 CCT/70 CRI 4,066 LM | INTEGRAL 0-10V DIMMING | UNV | 39 W | PATHWAYS | BY ARCHITECT | REFER TO DET ON SHEET E705 MOUNTING DET |
| ZY3A | SAME AS TYPE ZY3 BUT WITH TYPE 5 OPTIC AND HIGHER LUMEN OUTPUT | POLE MOUNTED (12' HIGH POLE) | VISIONAIRE LIGHTING PRE-2-M-T5W-32LC-5-3K-UNV-PT -FINISH-OPTIONS-DIM; RNTA-4R-125-12'-BASE-ANCHOR | 3000 CCT/70 CRI | INTEGRAL 0-10V DIMMING | UNV | 56 W | PATHWAYS | BY ARCHITECT | REFER TO DET. ON SHEET E705 MOUNTING DET |

2. THE FINISH INDICATED ARE PRELIMINARY, COORDINATE WITH ARCHITECT FOR ALL LUMINAIRE'S FINAL COLOR FINISH SELECTED FROM MANUFACTURER'S STANDARD COLOR PALETTE PRIOR TO ORDERING OF FIXTURES.

3. ALL EXTERIOR LUMINAIRES SHALL BE 3000K (KELVIN) TEMPERATURE AND MIN. 70 CRI UNLESS NOTED OTHERWISE.

4. PROVIDE COMPLETE MOUNTING ACCESSORIES, SUPPORT BRACKETS, CLIPS, ETC. AS APPLICABLE TO THE FINISH CEILING OR CEILING STRUCTURE AS REQUIRED.

5. PROVIDE ACCESSIBLE WIRING DISCONNECT TO FIXTURE AS REQUIRED.

6. ALL OUTDOOR LUMINAIRES EXPOSED TO WEATHER SHALL BE UL WET LISTED TYPE.

urban design

PROJECT: **ALAMEDA AQUATIC** CENTER

800 ATLANTIC AVENUE ALAMEDA, CA 94501

PROJECT NUMBER: 202407

CITY OF ALAMEDA RECREATION AND PARK **DEPARTMENT** 2226 SANTA CLARA AVENUE

ALAMEDA, CA 94501 PROJECT TEAM: ARCHITECT: ELS ARCHITECTURE AND URBAN DESIGN 2040 Addison Street Berkeley, CA 94704 P: 510.549.2929

CIVIL ENGINEER: BKF ENGINEERS 1646 N. California Blvd, Suite 400 Walnut Creek, CA 94596 P: 925.940.2200

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AQUATICS: AQUATICS DESIGN GROUP 2226 Faraday Avenue Carlsbad, CA 92008 P: 760.438.8400

SPECIFICATIONS: SPECIFICATIONS WEST 1975 E. Buck Ridge Place Tucson, AZ 85737 P: 800.646.3820

| EVISION | | | | | | | |
|---------|------|-------------|--|--|--|--|--|
| IUMBER | DATE | DESCRIPTION | | | | | |
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PLANNING RESUBMITTAL 5


JUNE 9, 2025


NOT FOR CONSTRUCTION


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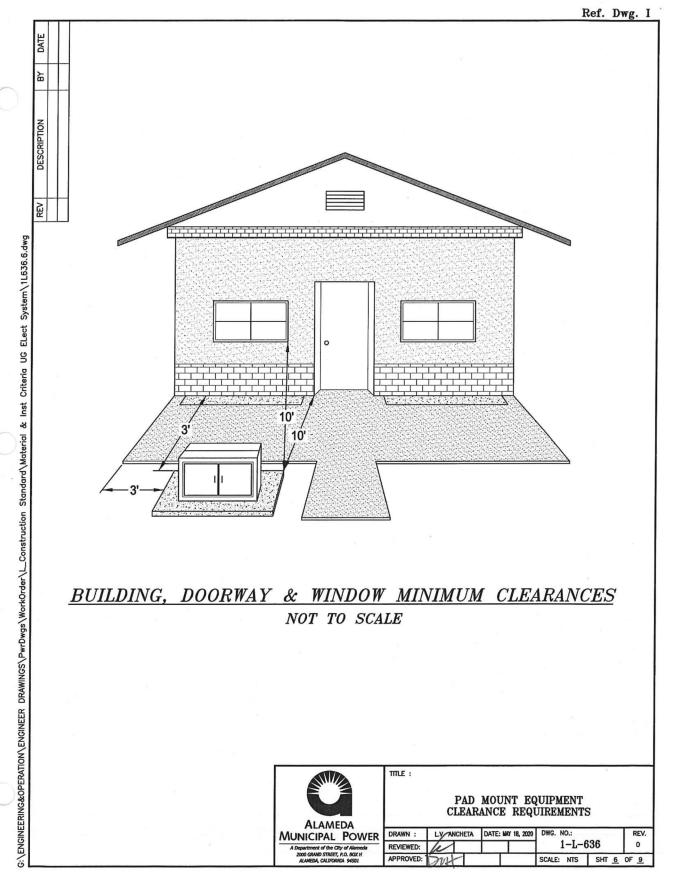
LIGHTING FIXTURE **SCHEDULE**


SHEET NUMBER:



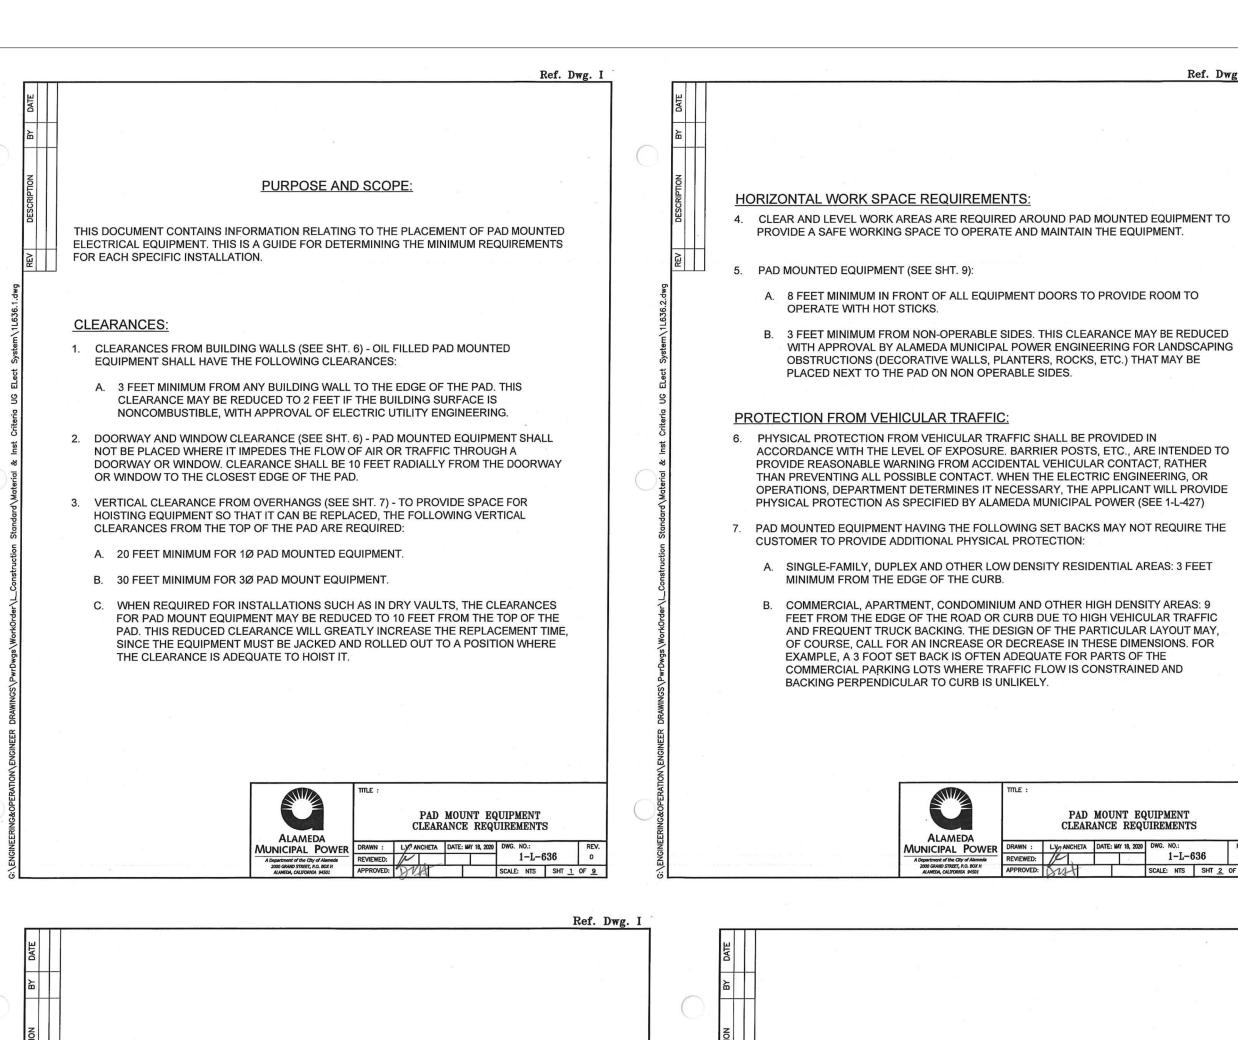


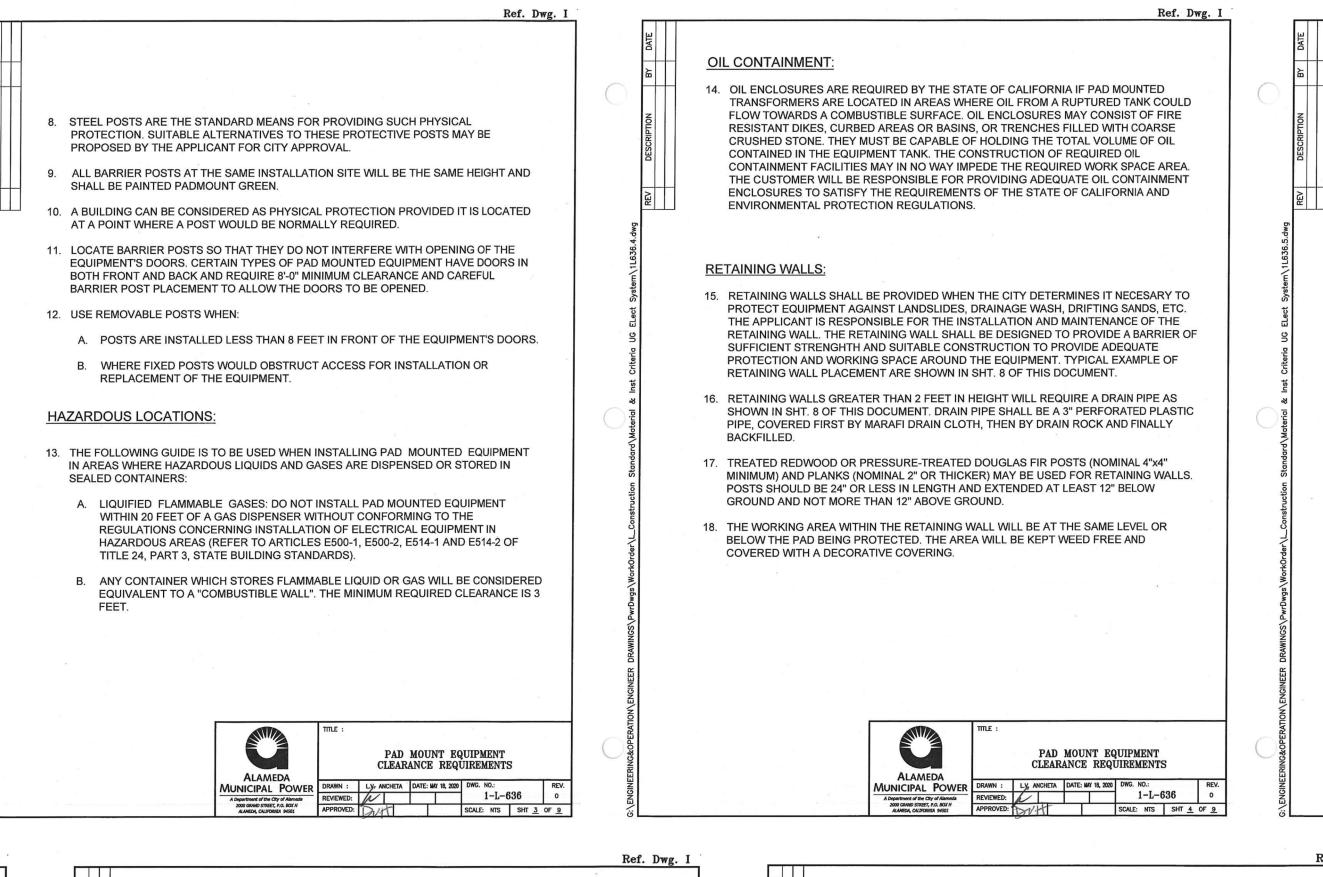


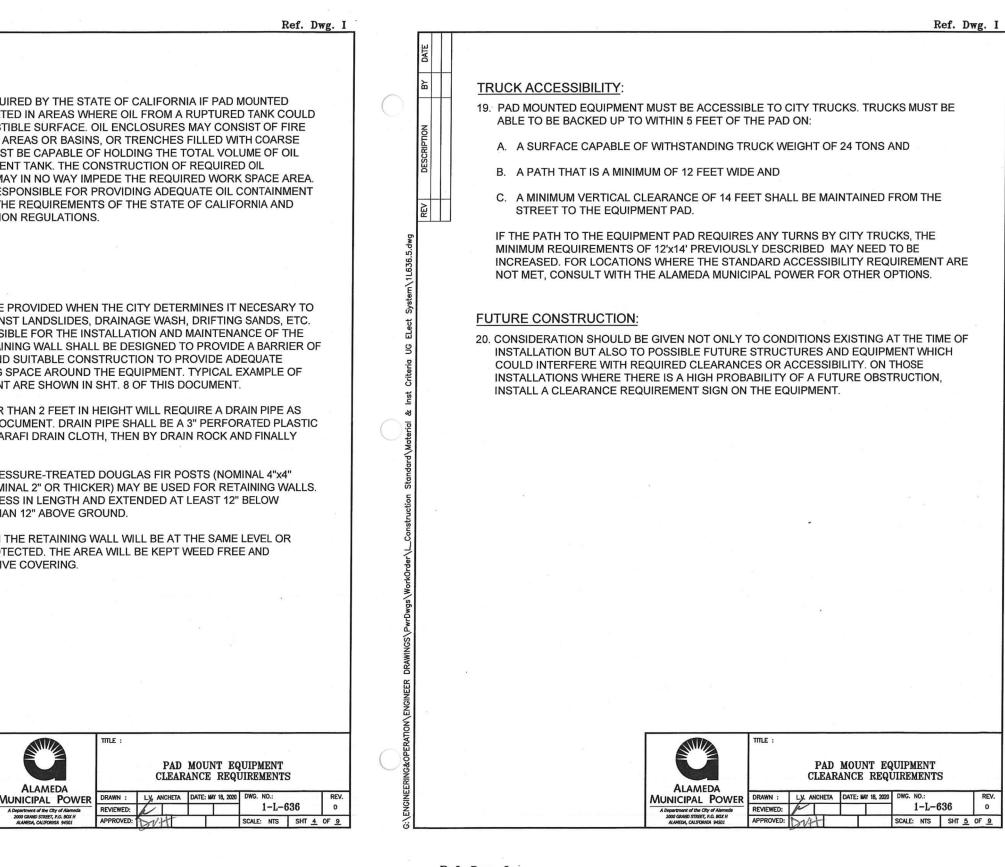


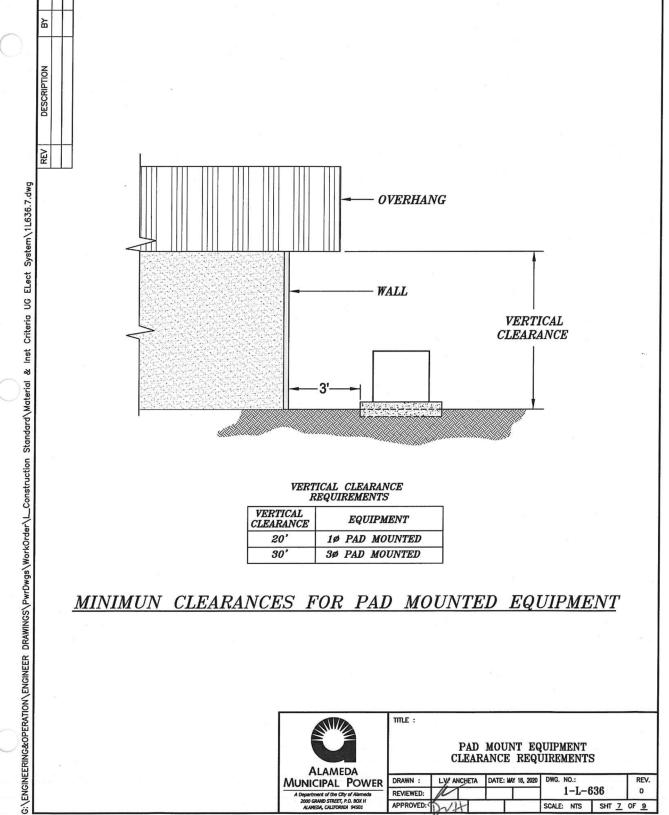


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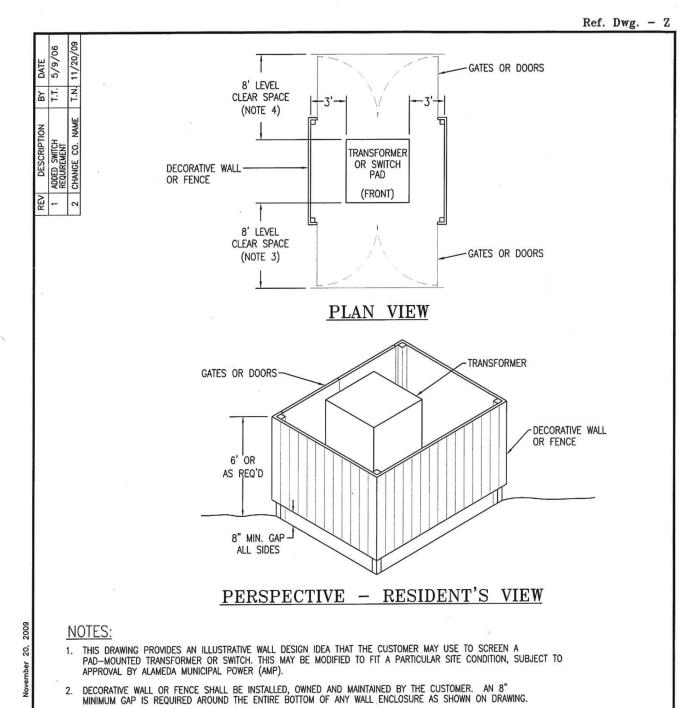


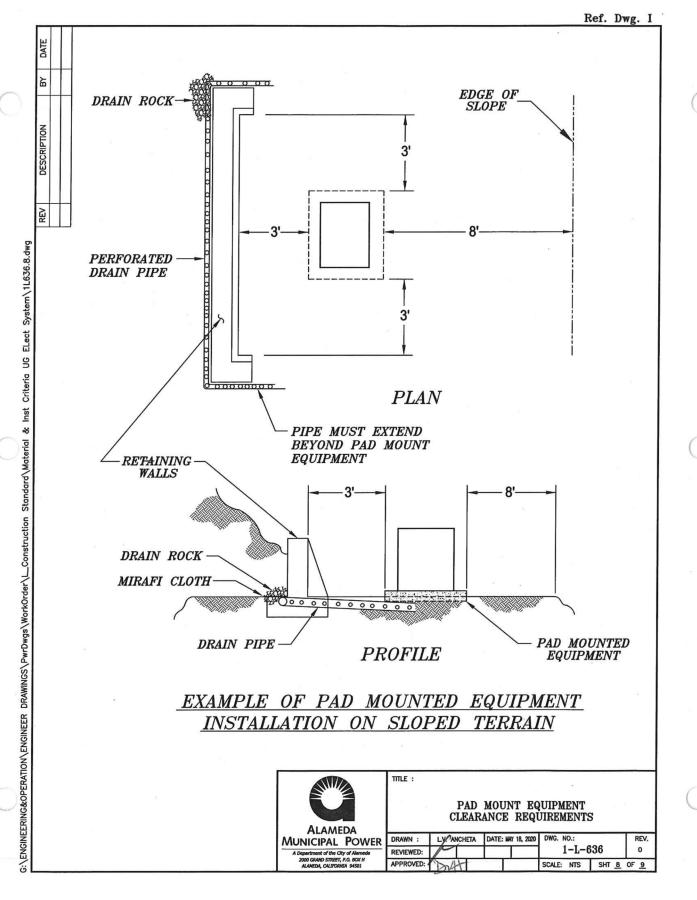

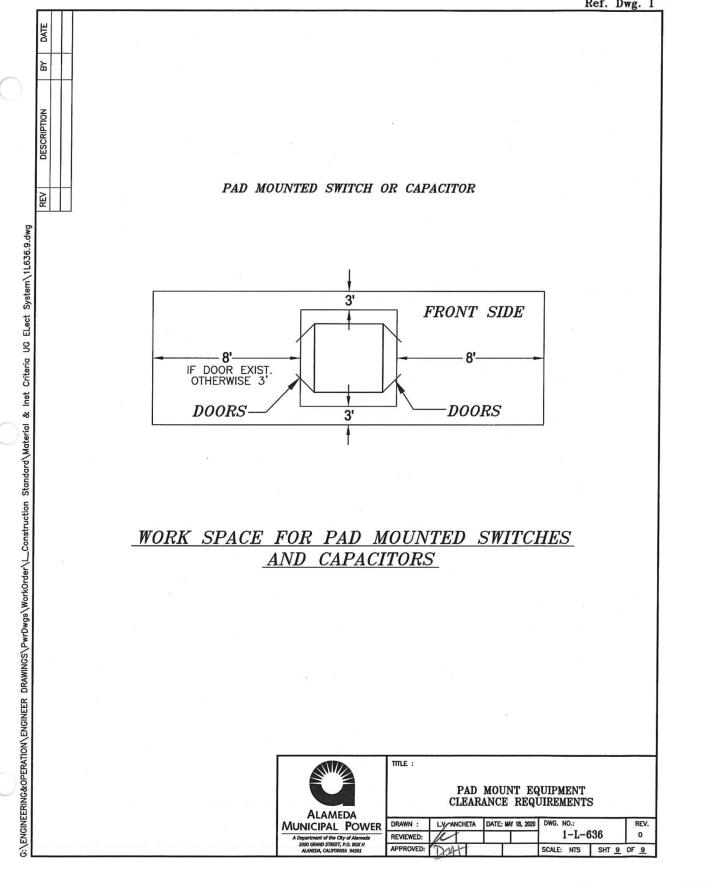

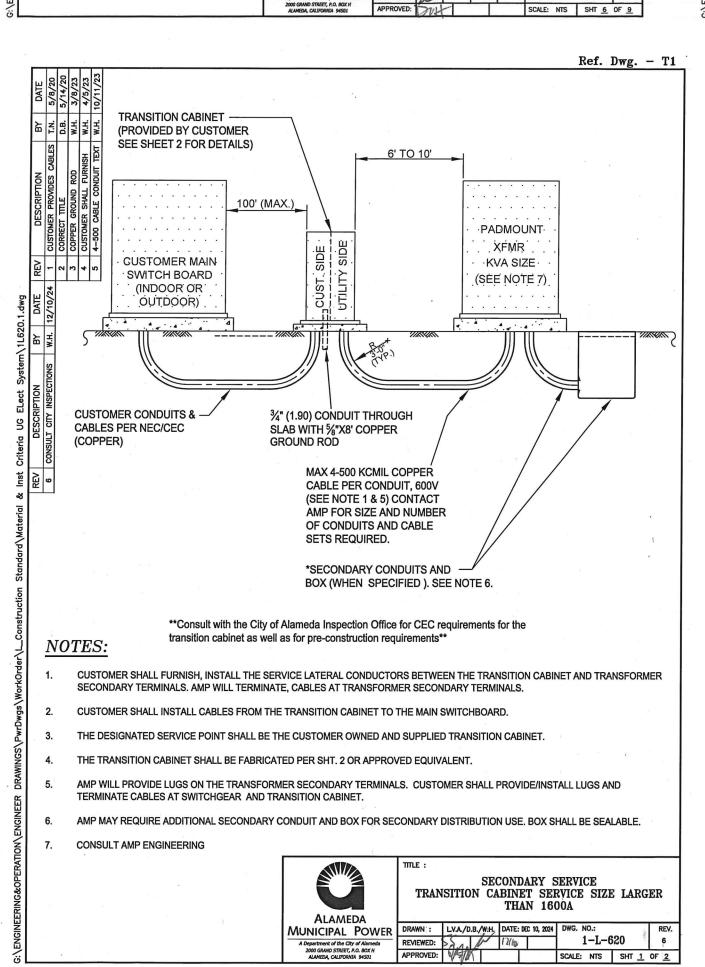

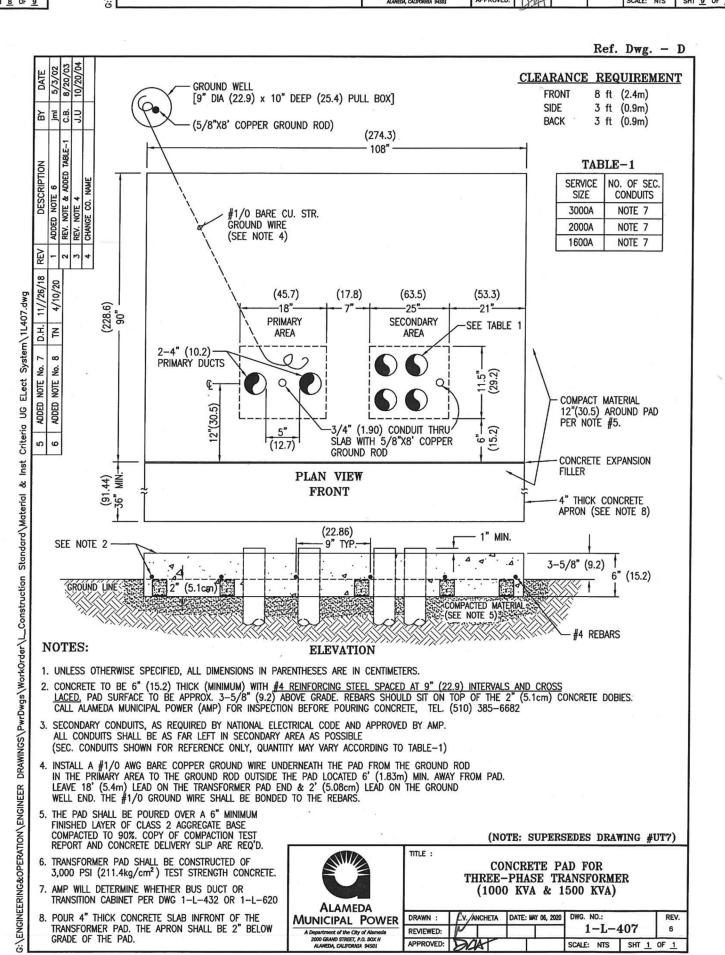TRANSFORMER PAD. THE APRON SHALL BE 2" BELOW GRADE OF THE PAD.



3. A CLEAR, LEVEL WORKING SPACE OF 8 FEET IS REQUIRED IN FRONT OF THE TRANSFORMER. GATES OR DOORS MAY BE PLACED AS LONG AS A MINIMUM 8-FT. CLEARANCE IS AVAILABLE WITH THE GATES OR DOORS OPEN.

4. A CLEAR, LEVEL WORKING SPACE OF 8 FEET IS REQUIRED AT THE FRONT AND BACK OF A SWITCH. GATES

5. DECORATIVE WALLS OR FENCES ARE NOT SUBSTITUTES TO ANY REQUIRED BARRIER POSTS OR BOLLARDS.

OR DOORS MAY BE PLACED AS LONG AS A MINIMUM 8-FT CLEARANCE IS AVAILABLE WITH THE GATES OR

WALL SCREEN FOR

PAD-MOUNTED EQUIPMENT

NOT FOR CONSTRUCTION

PLANNING RESUBMITTAL 5

JUNE 9, 2025

urban design

ALAMEDA AQUATIC

CENTER

800 ATLANTIC AVENUE

ALAMEDA, CA 94501

202407

CITY OF ALAMEDA

RECREATION AND PARK

DEPARTMENT

2226 SANTA CLARA AVENUE

ALAMEDA, CA 94501

ELS ARCHITECTURE AND URBAN DESIGN

PROJECT NUMBER:

PROJECT TEAM:

2040 Addison Street

Berkeley, CA 94704

P: 510.549.2929

CIVIL ENGINEER: BKF ENGINEERS

P: 925.940.2200

2200 Bridgeway

Sausalito, CA 94965 P: 415.332.5100

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LANDSCAPE ARCHITECT:

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AQUATICS DESIGN GROUP 2226 Faraday Avenue Carlsbad, CA 92008

P: 415.655.4000

P: 760.438.8400

SPECIFICATIONS:

P: 800.646.3820

REVISION

NUMBER DATE DESCRIPTION

SPECIFICATIONS WEST

1975 E. Buck Ridge Place Tucson, AZ 85737

AQUATICS:

FORELL/ELSESSER ENGINEERS, INC.

ARCHITECT:

SHEET TITLE:

DETAILS (FOR REFERENCE)

SHEET NUMBER: