



at&t  
Mobility

FA #: 13323784

SITE NUMBER: CCU3085  
SITE NAME: CENTRAL  
& ST CHARLES RELO

SEARCH RING NAME:  
CENTRAL & ST CHARLES RELO

1538 ST CHARLES ST  
ALAMEDA, CA 94501  
COUNTY: ALAMEDA COUNTY

SITE TYPE: ROOFTOP

PREPARED FOR

5001 Executive Parkway  
San Ramon, California 94583

Vendor:

14621 Arroyo Honda  
San Diego, CA 92127

AT&T Site ID:

CCU3085

AT&T SITE NO: CCU3085

PROJECT CODE: -----

DRAWN BY: SO

CHECKED BY: JF

4	01/22/15	ZD 100%
3	01/09/15	ZD 100%
2	12/22/14	ZD 100%
1	11/26/14	ZD 100%
0	11/16/14	ZD 100%
REV	DATE	DESCRIPTION

Licensors:

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Issued For:

**CCU3085**  
**CENTRAL & ST**  
**CHARLES RELO**  
**1538 ST CHARLES ST**  
**ALAMEDA, CA 94501**  
**ALAMEDA COUNTY**

SHEET TITLE:

TITLE SHEET


SHEET NUMBER:

**T-1**

PROJECT DESCRIPTION	PROJECT INFORMATION	PROJECT TEAM	SHEET INDEX		REV																											
NEW SITE BUILD UNMANNED TELECOMMUNICATIONS FACILITY.  1. BRING POWER / TELCO / FIBER TO SITE LOCATION. 2. INSTALL AT&T INDOOR EQUIPMENT IN A LEASE AREA (INDOOR GROUND FLOOR) 3. PROPOSED STEALTH ENCLOSURE (15'-0" BY 14'-6" BY 10' TALL) TO BE PLACED ON ROOFTOP. 4. INSTALL (1) PROPOSED GPS UNIT ON ROOFTOP 5. INSTALL (9) PROPOSED ANTENNAS (3) PER SECTOR IN PROPOSED STEALTH ON ROOFTOP. 6. INSTALL (21) PROPOSED RRH & (3) A2 UNITS IN PROPOSED STEALTH ON ROOFTOP. 7. INSTALL (4) PROPOSED DC6'S IN PROPOSED STEALTH ON ROOFTOP.	Property Information: Site Name: CENTRAL & ST CHARLES RELO Site Number: CCU3085  Site Address: 1538 ST CHARLES ST ALAMEDA, CA 94501  A.P.N. Number: 072-0375-020 Current Use: RESIDENTIAL BUILDING  Proposed Use: RESIDENTIAL BUILDING/UNMANNED TELECOM FACILITY  Jurisdiction: CITY OF ALAMEDA Zoning Designation: R-4 (NEIGHBORHOOD RESIDENTIAL)  Latitude: NAD 83 N 37° 46' 27.54" (37.77432°) Longitude: NAD 83 W 122° 15' 55.48" (-122.26541°)  Ground Elevation: 25.9 FT. AMSL (LOCATION TAKEN AT NORTH-EAST CORNER OF THE BLDG)	Property Owner: FEREIDOOON HASHEMI AND SOHI ROUHOLAMIN HASHEMI C/O THE LAPHAM CO., INC., 4744 TELEGRAPH AVENUE OAKLAND, CA 94609  Property Managing Company: THE LAPHAM CO., INC., 4744 TELEGRAPH AVENUE OAKLAND, CA 94609  Power Agency: ALAMEDA POWER 2000 GRAND ST ALAMEDA, CA 94501  Telephone Agency: AT&T  RFDS DATED 10-22-14, V1 (preliminary)	Applicant / Lessee: AT&T MOBILITY 5001 Executive Parkway San Ramon, CA 94583 contact: MONICA MILLER email: mm595e@att.com cell: (925) 277-6219  Construction Mgr.: ERICSSON contact: TODD MERRILL 6140 Stoneridge Mall Pleasanton, CA 94588 email: todd.merrill@ericsson.com ph: (530) 605-5765  Site Acquisition: CORTEL, Inc. contact: ALEX ORNER email: alex.ornor@coritel-llc.com cell: (415) 601-3194  Architect / Engineer: CORTEL, Inc. contact: SEUNGKUN OH email: seungkun.oh@coritel-llc.com ph: (786) 503-3851  Zoning Mgr.: CORTEL, Inc. contact: ALEX ORNER email: alex.ornor@coritel-llc.com cell: (415) 601-3194  RF Engineer: AT&T MOBILITY contact: MICHAEL QUINTO email: mq3253@att.com ph: (925) 277-6335	T-1 LS-1 A-1 A-2 A-3 A-4 A-4.1 A-5 A-6 A-7 A-8	TITLE SHEET TOPOGRAPHIC SURVEY OVERALL SITE PLAN ENLARGED SITE PLAN PROPOSED EQUIPMENT AREA PLAN VIEW PROPOSED ANTENNA PLAN VIEW EQUIPMENT DETAIL EXISTING & PROPOSED WEST ELEVATION VIEW EXISTING & PROPOSED SOUTH ELEVATION VIEW EXISTING & PROPOSED EAST ELEVATION VIEW EME SIGNAGE LOCATION PLAN VIEW	4 4 4 4 4 4 4 4 4 4 4 4																										
CODE COMPLIANCE	VICINITY MAP	VICINITY MAP - ZOOMED																														
ALL WORK AND MATERIALS SHALL BE PERFORMED AND INSTALLED IN ACCORDANCE WITH THE CURRENT EDITIONS OF THE FOLLOWING CODES AS ADOPTED BY THE LOCAL GOVERNING AUTHORITIES. NOTHING IN THESE PLANS IS TO BE CONSTRUED TO PERMIT WORK NOT CONFORMING TO THESE CODES.  1) 2013 CALIFORNIA ADMINISTRATIVE CODE, CHAPTER 10, PART 1, TITLE 24 CODE OF REGULATIONS 2) 2013 CALIFORNIA BUILDING CODE (CBC) WITH CALIFORNIA AMENDMENTS, BASED ON THE 2012 IBC (PART 2, VOL 1-2) 3) 2013 CALIFORNIA RESIDENTIAL CODE (CRC) WITH APPENDIX H, PATIO COVERS, BASED ON THE 2012 IRC (PART 2.5) 4) 2013 CALIFORNIA GREEN BUILDINGS STANDARDS CODE (CALGREEN) (PART 11) (AFFECTED ENERGY PROVISIONS ONLY) 5) 2013 CALIFORNIA FIRE CODE (CFC), BASED ON THE 2012 IFC, WITH CALIFORNIA AMENDMENTS (PART 9) 6) 2013 CALIFORNIA MECHANICAL CODE (CMC), BASED ON THE 2012 UMC (PART 4) 7) 2013 CALIFORNIA PLUMBING CODE (CPC), BASED ON THE 2012 UPC (PART 5) 8) 2013 CALIFORNIA ELECTRICAL CODE (CEC) WITH CALIFORNIA AMENDMENTS, BASED ON THE 2011 NEC (PART 3) 9) 2013 CALIFORNIA ENERGY CODE (CEC)- PART 6 10) ANSI / EIA-TIA-222-G 11) 2012 NFPA 101, LIFE SAFETY CODE 12) 2013 NFPA 72, NATIONAL FIRE ALARM CODE 13) 2013 NFPA 13, FIRE SPRINKLER CODE			DIRECTIONS FROM AT&T																													
			DIRECTIONS FROM AT&T'S OFFICE AT 5001 EXECUTIVE PARKWAY, SAN RAMON, CA  1. Head northeast on Executive Pkwy toward Camino Ramon 2. Turn right onto Camino Ramon 3. Take right onto Bollinger Canyon Rd 4. Merge onto I-680 S via the ramp to San Jose 5. Merge onto I-680 S 6. Take I-580 W toward Dublin Blvd/Oakland. 7. Keep left at the fork to continue on I-238 n, follow signs for I-880 8. Take the exit toward High St/Alameda 9. Merge onto Coliseum Way 10. Turn left onto High St and then right onto Howard St 11. Turn left onto Alameda Ave and then left onto Tilden Way 12. Continue onto Lincoln Ave 13. Turn left onto St Charles St																													
OCCUPANCY AND CONSTRUCTION TYPE	APPROVALS		GENERAL CONTRACTOR NOTES																													
OCCUPANCY : U (UNMANNED)  CONSTRUCTION TYPE: V-B  HANDICAP REQUIREMENTS FACILITY IS UNMANNED AND NOT FOR HUMAN HABITATION. HANDICAP ACCESS IS NOT REQUIRED PER CBC2013, SECTION 11B-203.4 (LIMITED ACCESS SPACE)	<table><tr><td>APPROVED BY:</td><td>INITIALS:</td><td>DATE:</td></tr><tr><td>AT&amp;T:</td><td></td><td></td></tr><tr><td>VENDOR:</td><td></td><td></td></tr><tr><td>R.F.:</td><td></td><td></td></tr><tr><td>LEASING / LANDLORD:</td><td></td><td></td></tr><tr><td>ZONING:</td><td></td><td></td></tr><tr><td>CONSTRUCTION:</td><td></td><td></td></tr><tr><td>POWER / TELCO:</td><td></td><td></td></tr><tr><td>PG&amp;E:</td><td></td><td></td></tr></table>		APPROVED BY:	INITIALS:	DATE:	AT&T:			VENDOR:			R.F.:			LEASING / LANDLORD:			ZONING:			CONSTRUCTION:			POWER / TELCO:			PG&E:			DO NOT SCALE DRAWINGS  THESE DRAWINGS ARE FORMATTED TO BE FULL SIZE AT 24" x 36". CONTRACTOR SHALL VERIFY ALL PLANS AND EXISTING DIMENSIONS AND CONDITIONS ON THE JOBSITE AND SHALL IMMEDIATELY NOTIFY THE ARCHITECT/ENGINEER IN WRITING OF ANY DISCREPANCIES BEFORE PROCEEDING WITH THE WORK OR MATERIAL ORDERS OR BE RESPONSIBLE FOR THE SAME.		
APPROVED BY:	INITIALS:	DATE:																														
AT&T:																																
VENDOR:																																
R.F.:																																
LEASING / LANDLORD:																																
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CONSTRUCTION:																																
POWER / TELCO:																																
PG&E:																																
	SITE LOCATION (SEE ZOOM IN RIGHT)																															





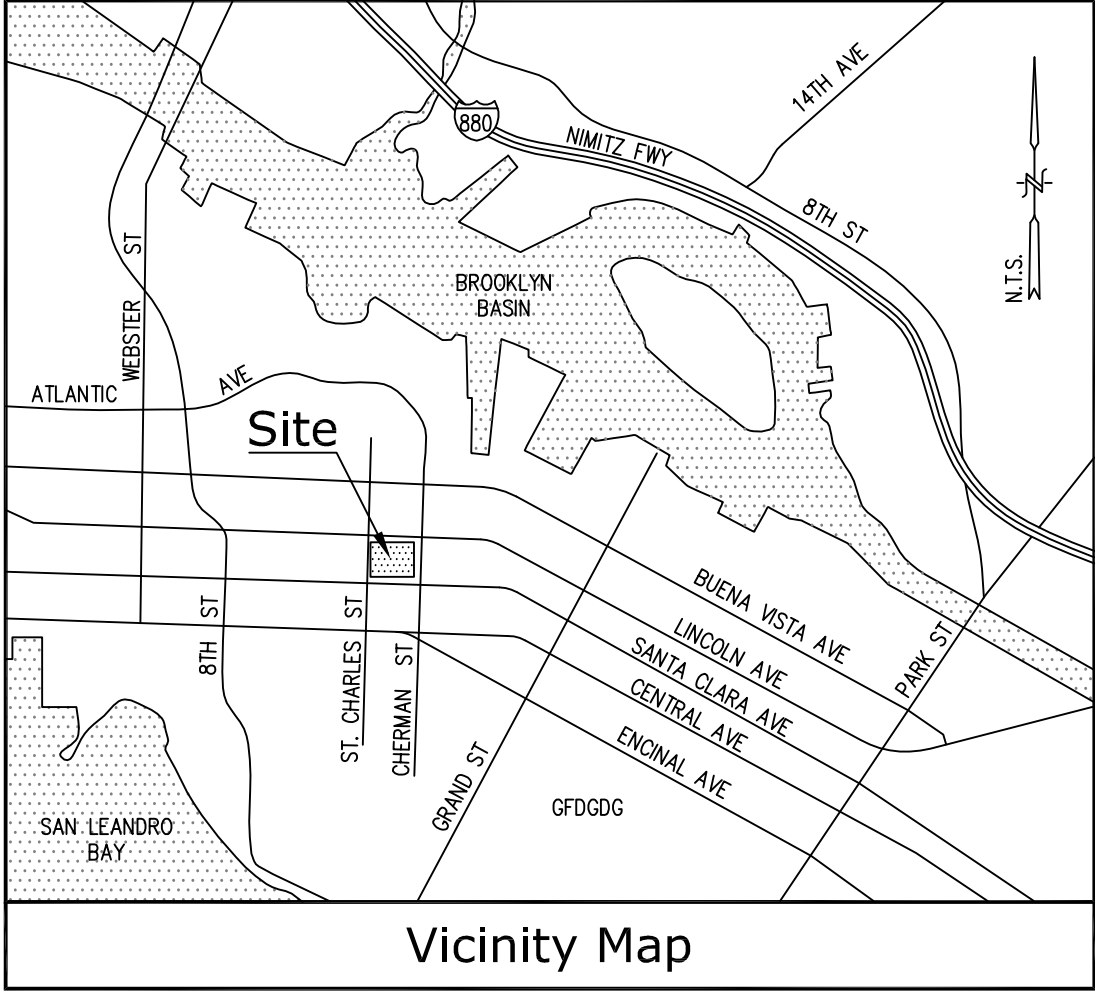

### Title Report

PREPARED BY: STEWART TITLE GUARANTY COMPANY  
ORDER NO.: 01180-128707  
DATED: OCTOBER 02, 2014

### Legal Description

LOT 74, MAP OF THE ENCAL PARK TRACT, FILED JUNE 25, 1879, BOOK 185 OF DEEDS, PAGE 160, ALAMEDA COUNTY RECORDS, STATE OF CALIFORNIA.

### Assessor's Parcel No.

072-0375-020

### Easements

NO EASEMENTS FROM TITLE REPORT

### Geographic Coordinates at Proposed Antennas

1983 DATUM: LATITUDE 37° 46' 27.54" N LONGITUDE 122° 15' 55.48" W  
ELEVATION = 25.9 FEET ABOVE MEAN SEA LEVEL

#### CERTIFICATION:

THE LATITUDE AND LONGITUDE SHOWN ABOVE ARE ACCURATE TO WITHIN +/- 15 FEET HORIZONTALLY AND THAT THE ELEVATIONS SHOWN ABOVE ARE ACCURATE TO WITHIN +/- 3 FEET VERTICALLY. THE HORIZONTAL DATUM (GEOGRAPHIC COORDINATES) IS IN TERMS OF THE NORTH AMERICAN DATUM OF 1983 (NAD 83) AND IS EXPRESSED IN DEGREES (°), MINUTES (') AND SECONDS ("). TO THE NEAREST HUNDREDTH OF A SECOND. THE VERTICAL DATUM (ELEVATIONS) IS IN TERMS OF THE NORTH AMERICAN VERTICAL DATUM OF 1988 (NAVD 88) AND IS DETERMINED TO THE NEAREST TENTH OF A FOOT.

### Basis of Bearings



THE STATE PLANE COORDINATE SYSTEM OF 1983 (NAD 83), CALIFORNIA ZONE 3.

### Bench Mark

THE CALIFORNIA SPATIAL REFERENCE CENTER C.O.R.S "P224", ELEVATION = 1443.77 (NAVD 88).

### Date of Survey

OCTOBER 16, 2014

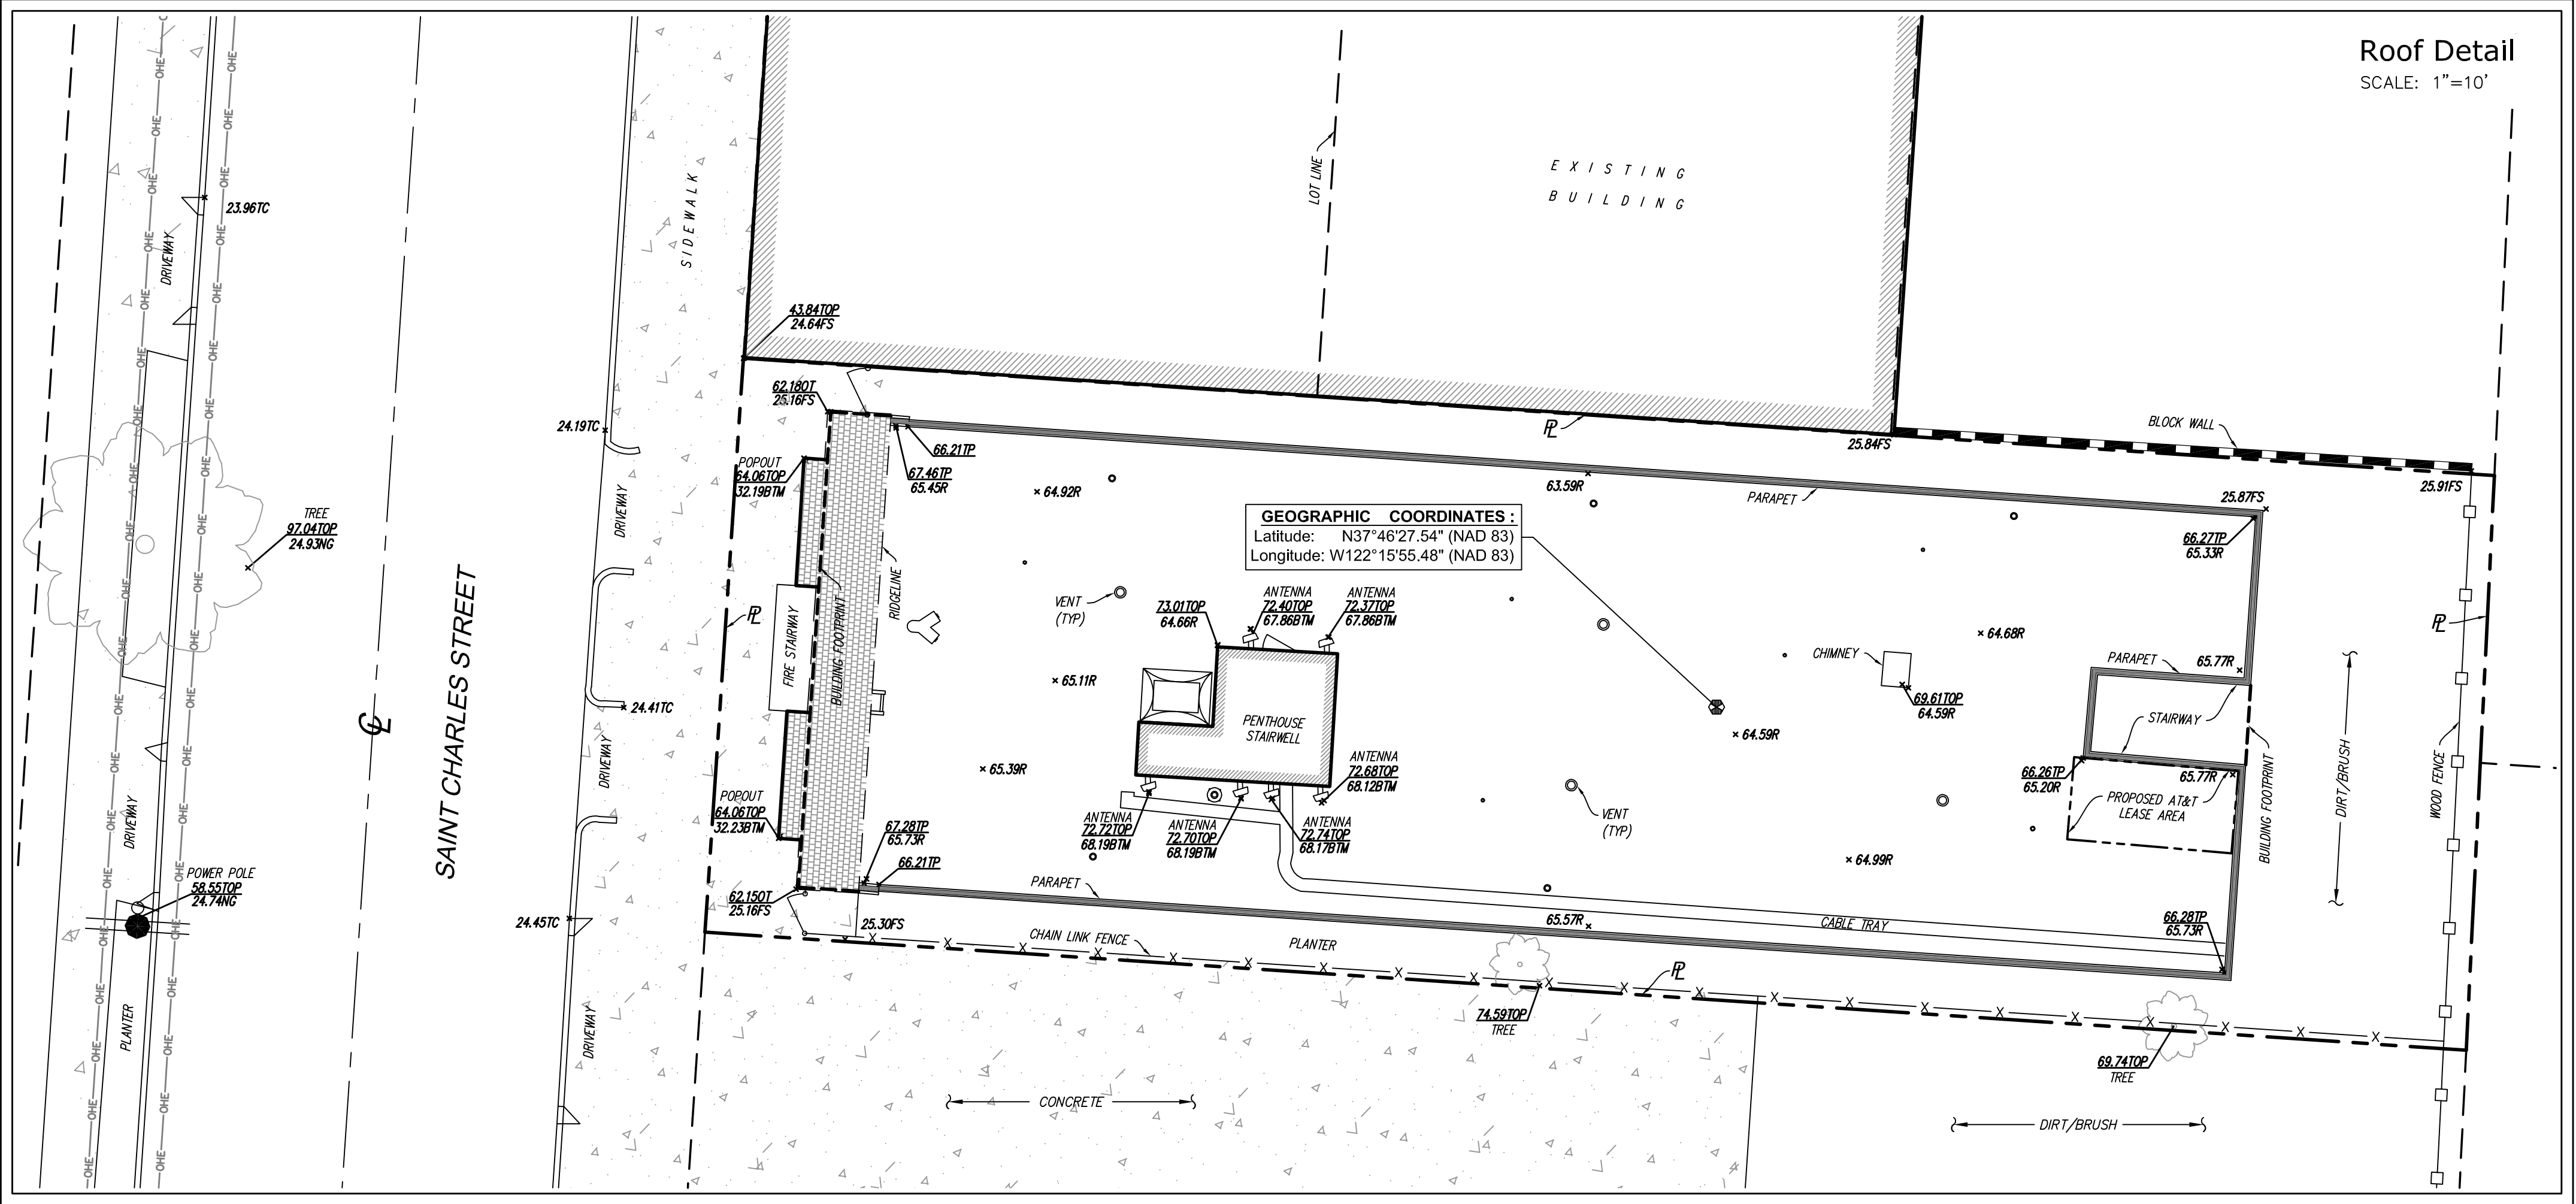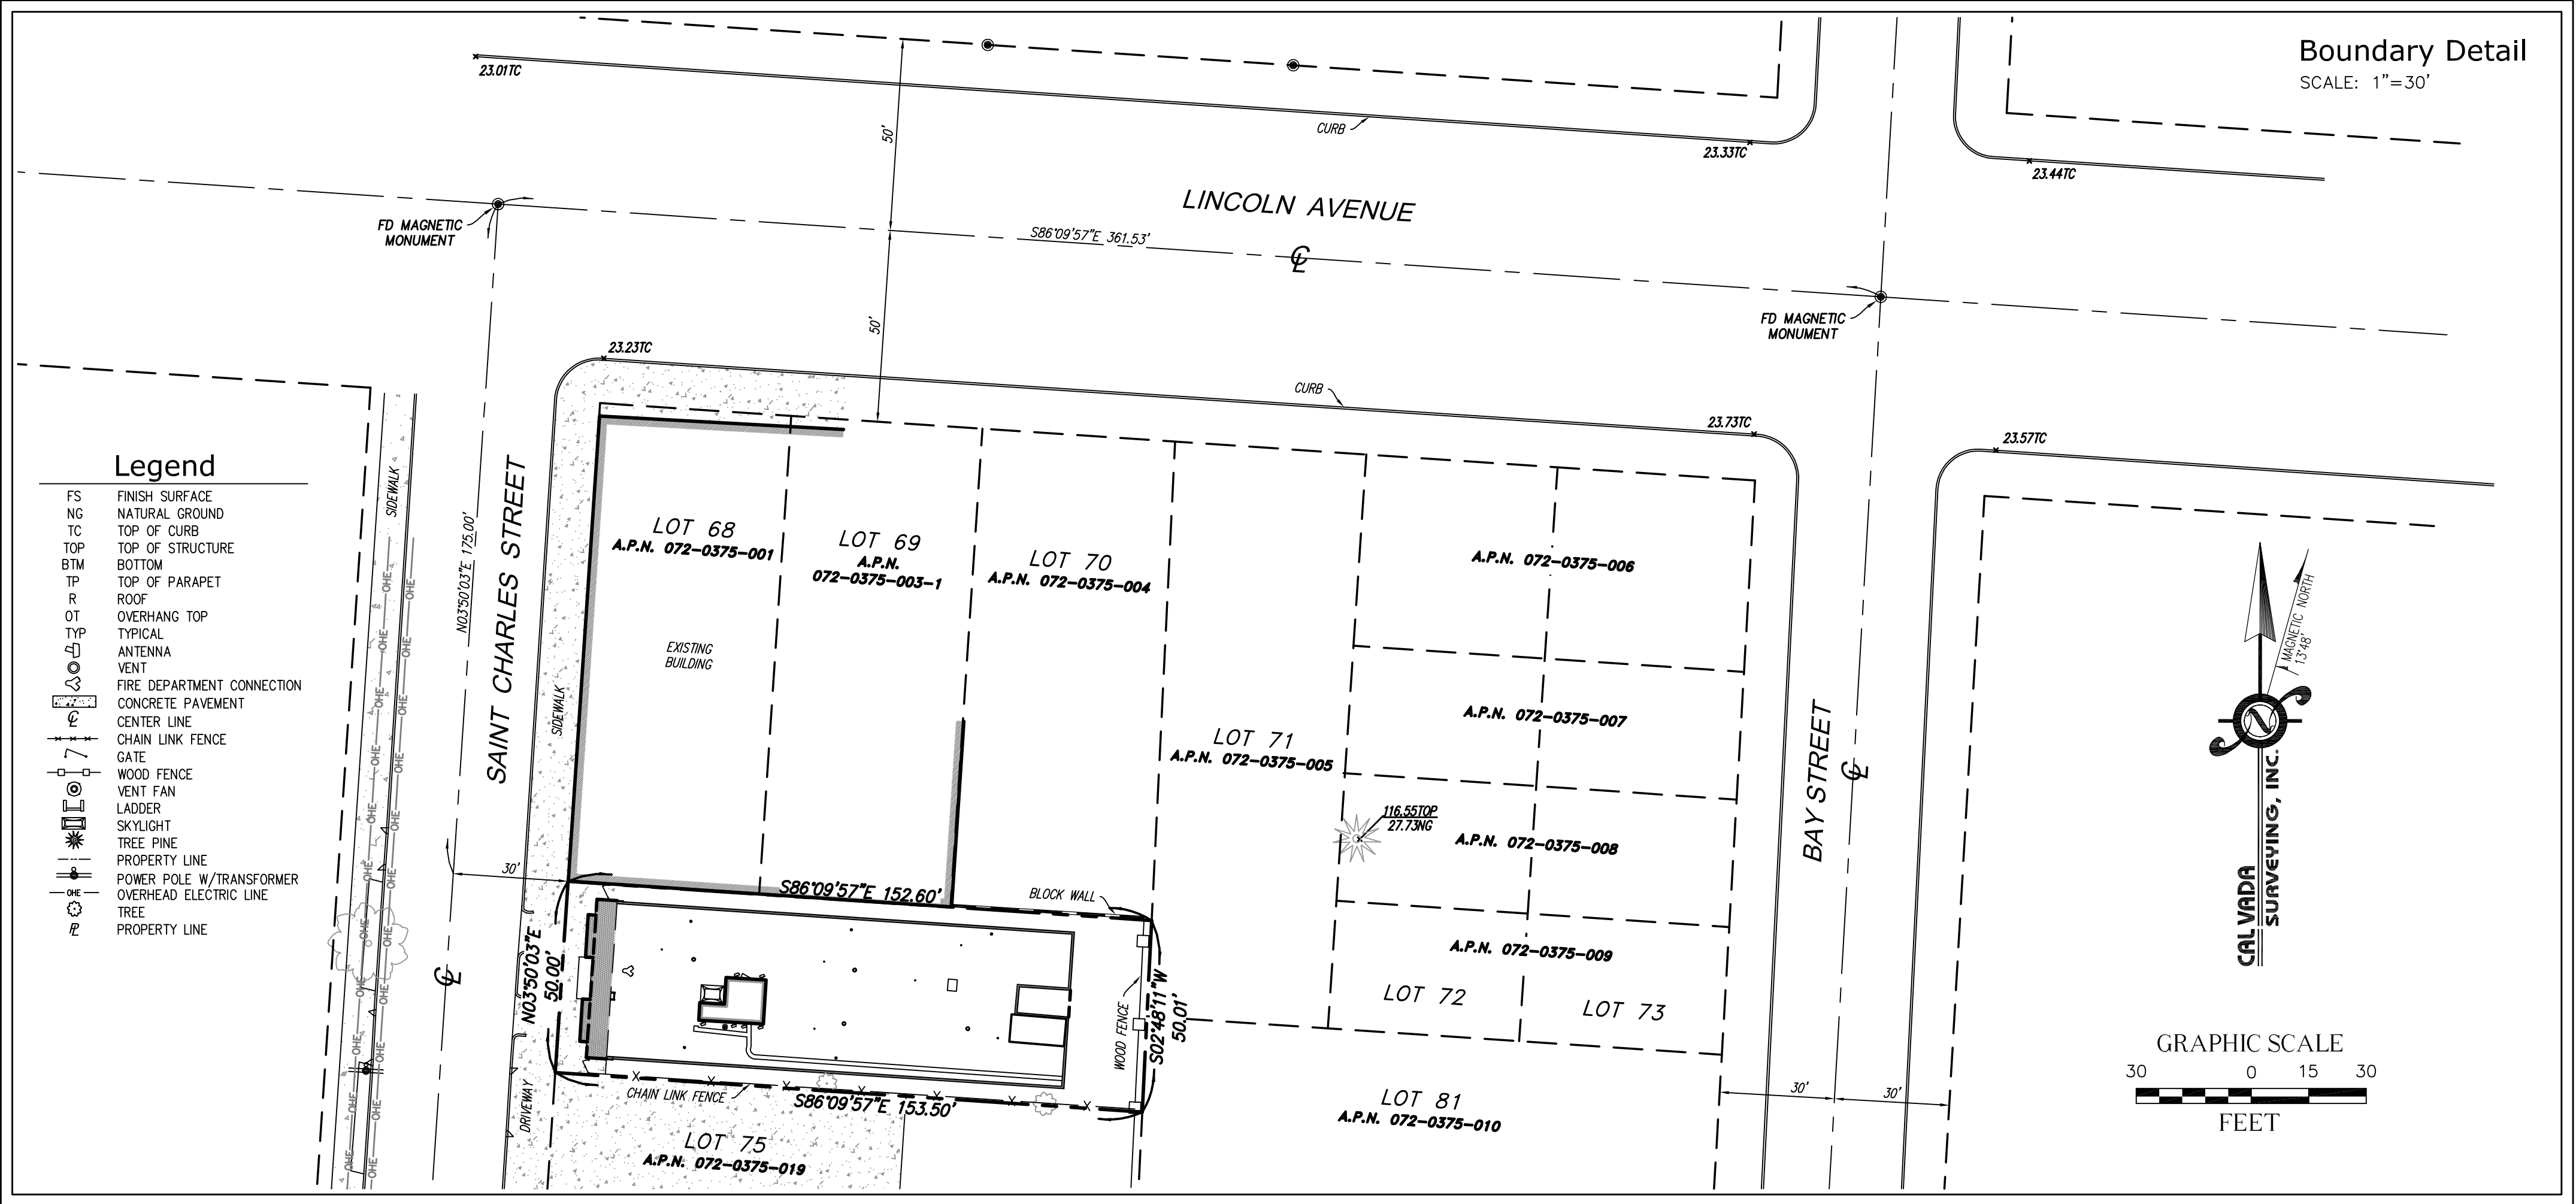

5001 EXECUTIVE PARKWAY, 4W850N  
SAN RAMON, CA 94583

A&E DEVELOPMENT:



14621 Arroyo Hondo  
San Diego, CA 92127

CONSULTANT:

### CAL VADA SURVEYING, INC.

411 Jenks Cir., Suite 205, Corona, CA 92880  
Phone: 951-280-9960 Fax: 951-280-9746  
Toll Free: 800-CALVADA www.calvada.com

JOB NO. 141025

LICENSURE:



REVISION:

REVISION:	DATE: / BY:	DESCRIPTION:
	10/22/14	SUBMITTAL
	AV	
1	11/14/14	TITLE REPORT - FINAL
	MN	
2	01/14/15	GEOGRAPHIC COORDINATES UPDATED
	MN	

SITE INFORMATION:

SITE NUMBER

**CCU3085**

SITE NAME

**ST. CHARLES &  
LINCOLN AVE**

**1538 ST. CHARLES ST.  
ALAMEDA, CA 94501  
ALAMEDA COUNTY**

SHEET TITLE:



**TOPOGRAPHIC  
SURVEY**

SHEET NUMBER:

**LS-1**

SHEET 1 OF 1



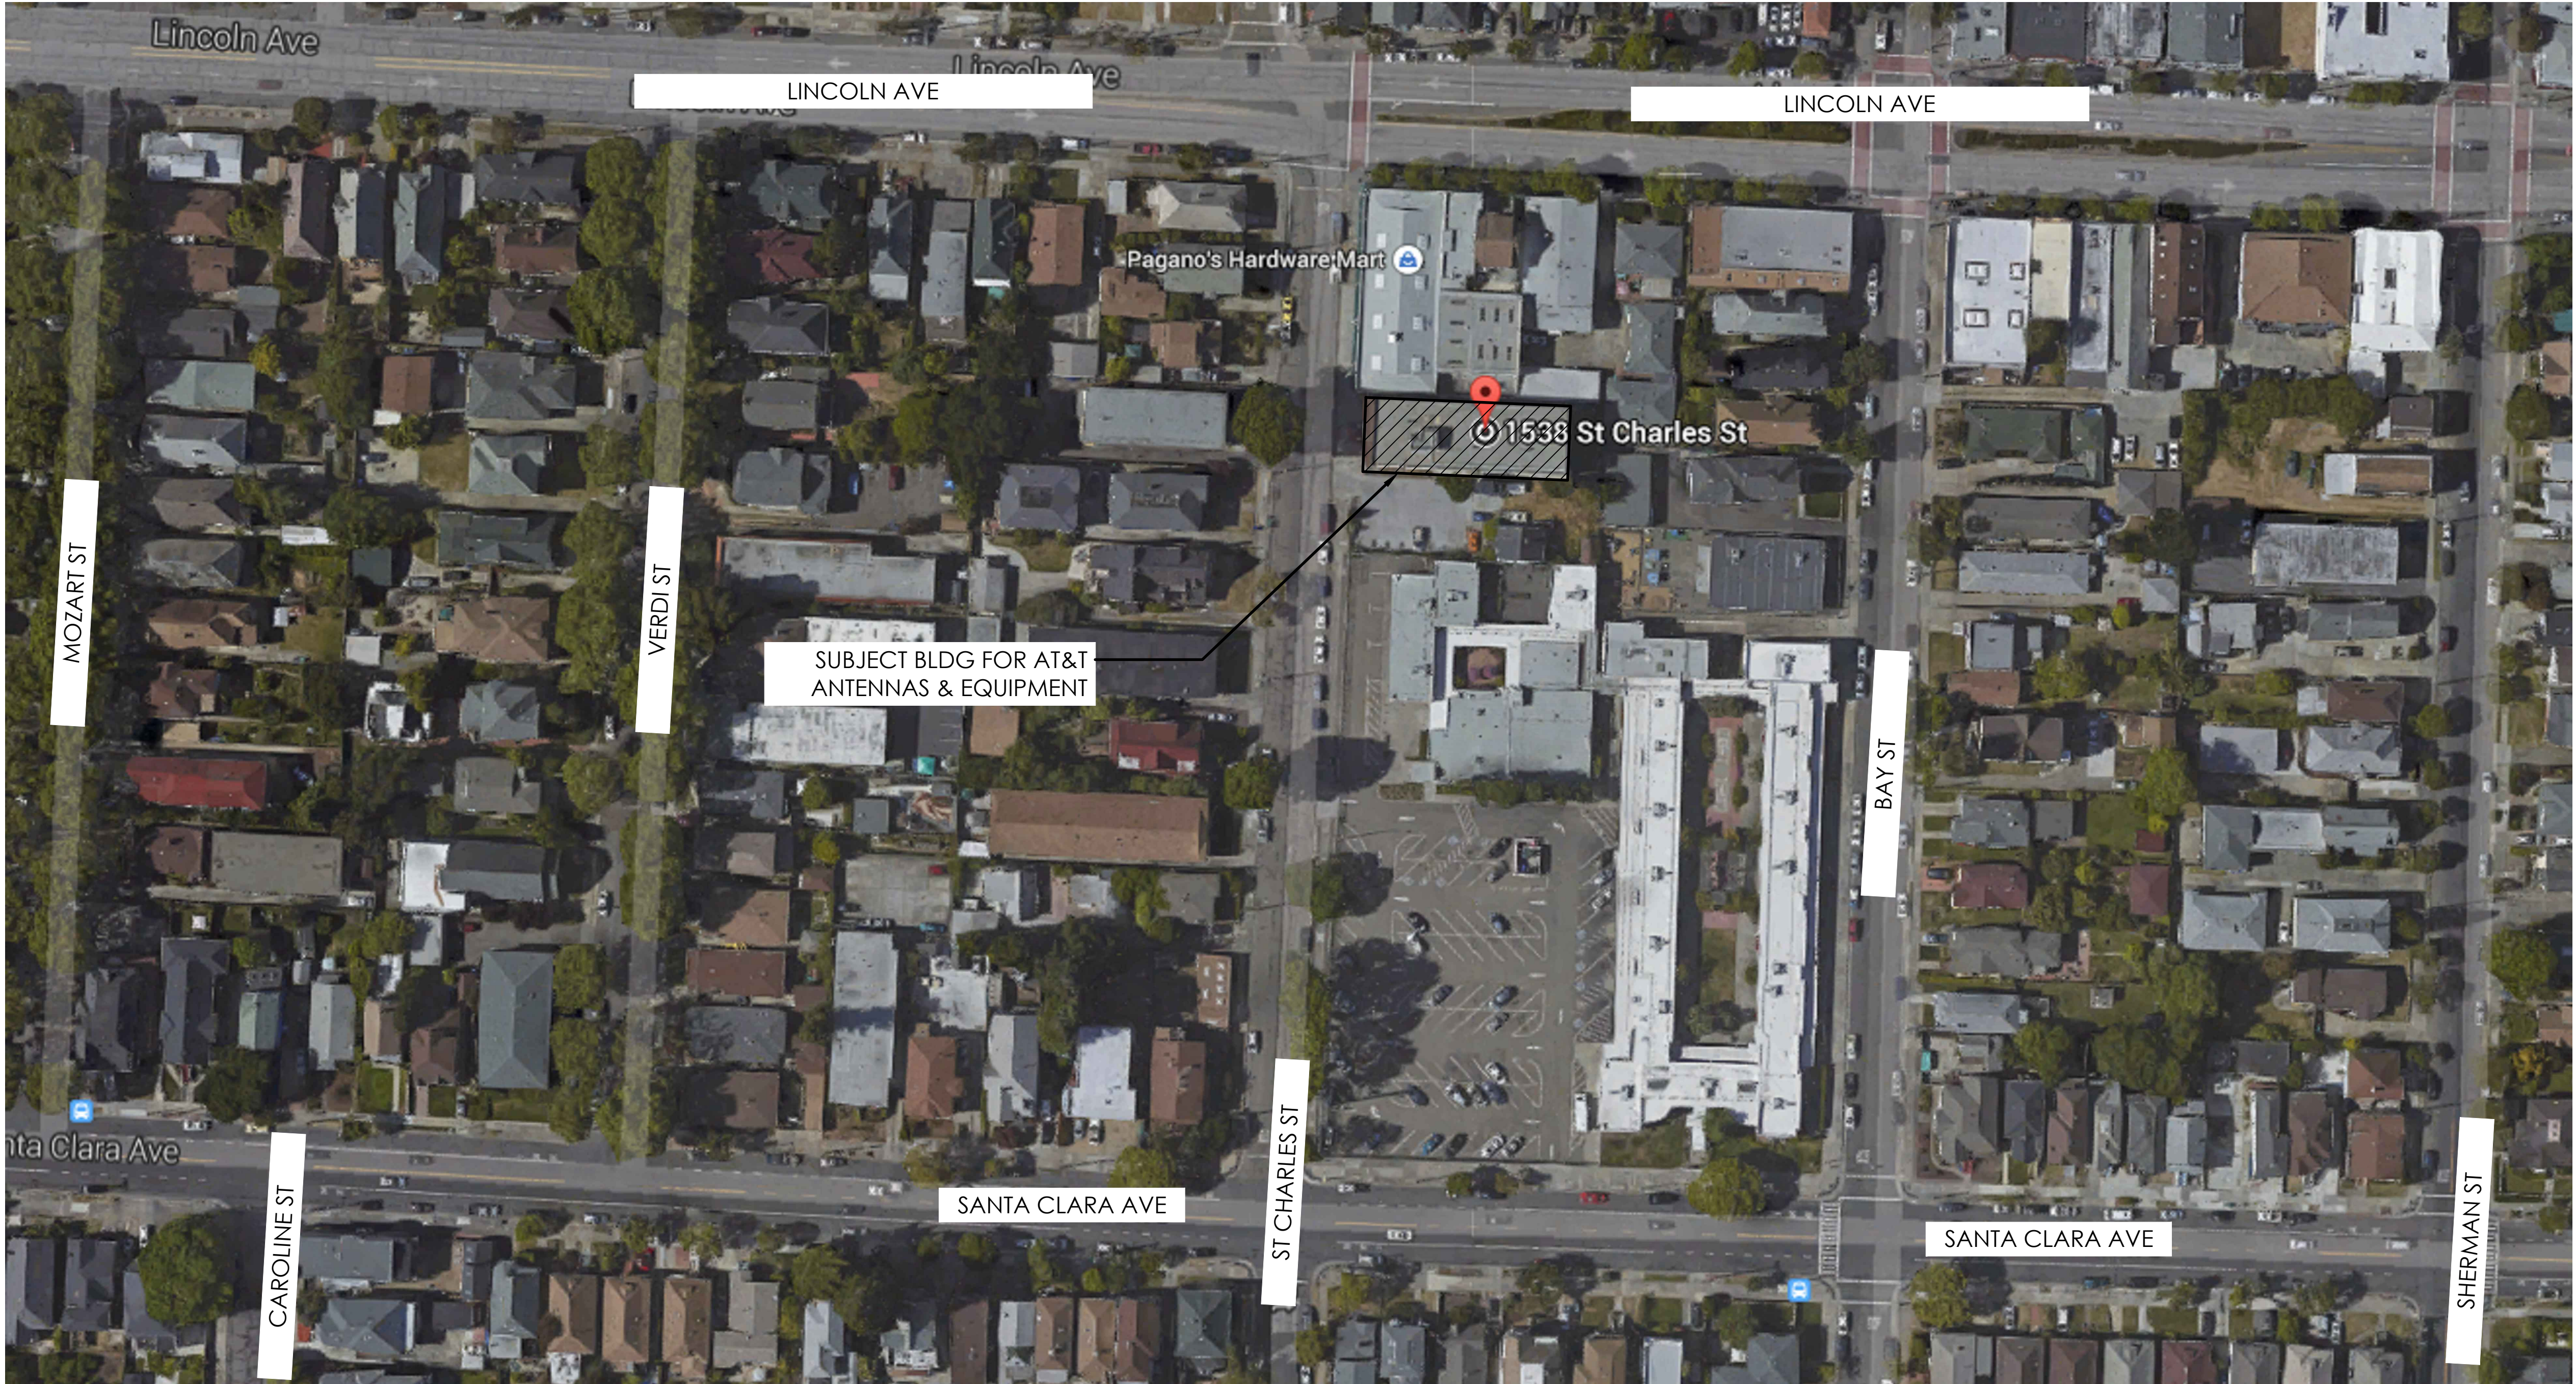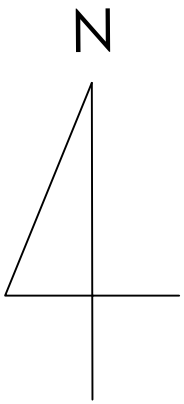

OVERALL SITE PLAN VIEW  
1/64" = 1'-0"

PREPARED FOR



at&t  
Mobility

5001 Executive Parkway  
San Ramon, California 94583

Vendor:



Cortel

14621 Arroyo Honda  
San Diego, CA 92127

AT&T Site ID:

CCU3085

AT&T SITE NO: CCU3085

PROJECT CODE: -----

DRAWN BY: SO

CHECKED BY: JF

REV	DATE	DESCRIPTION
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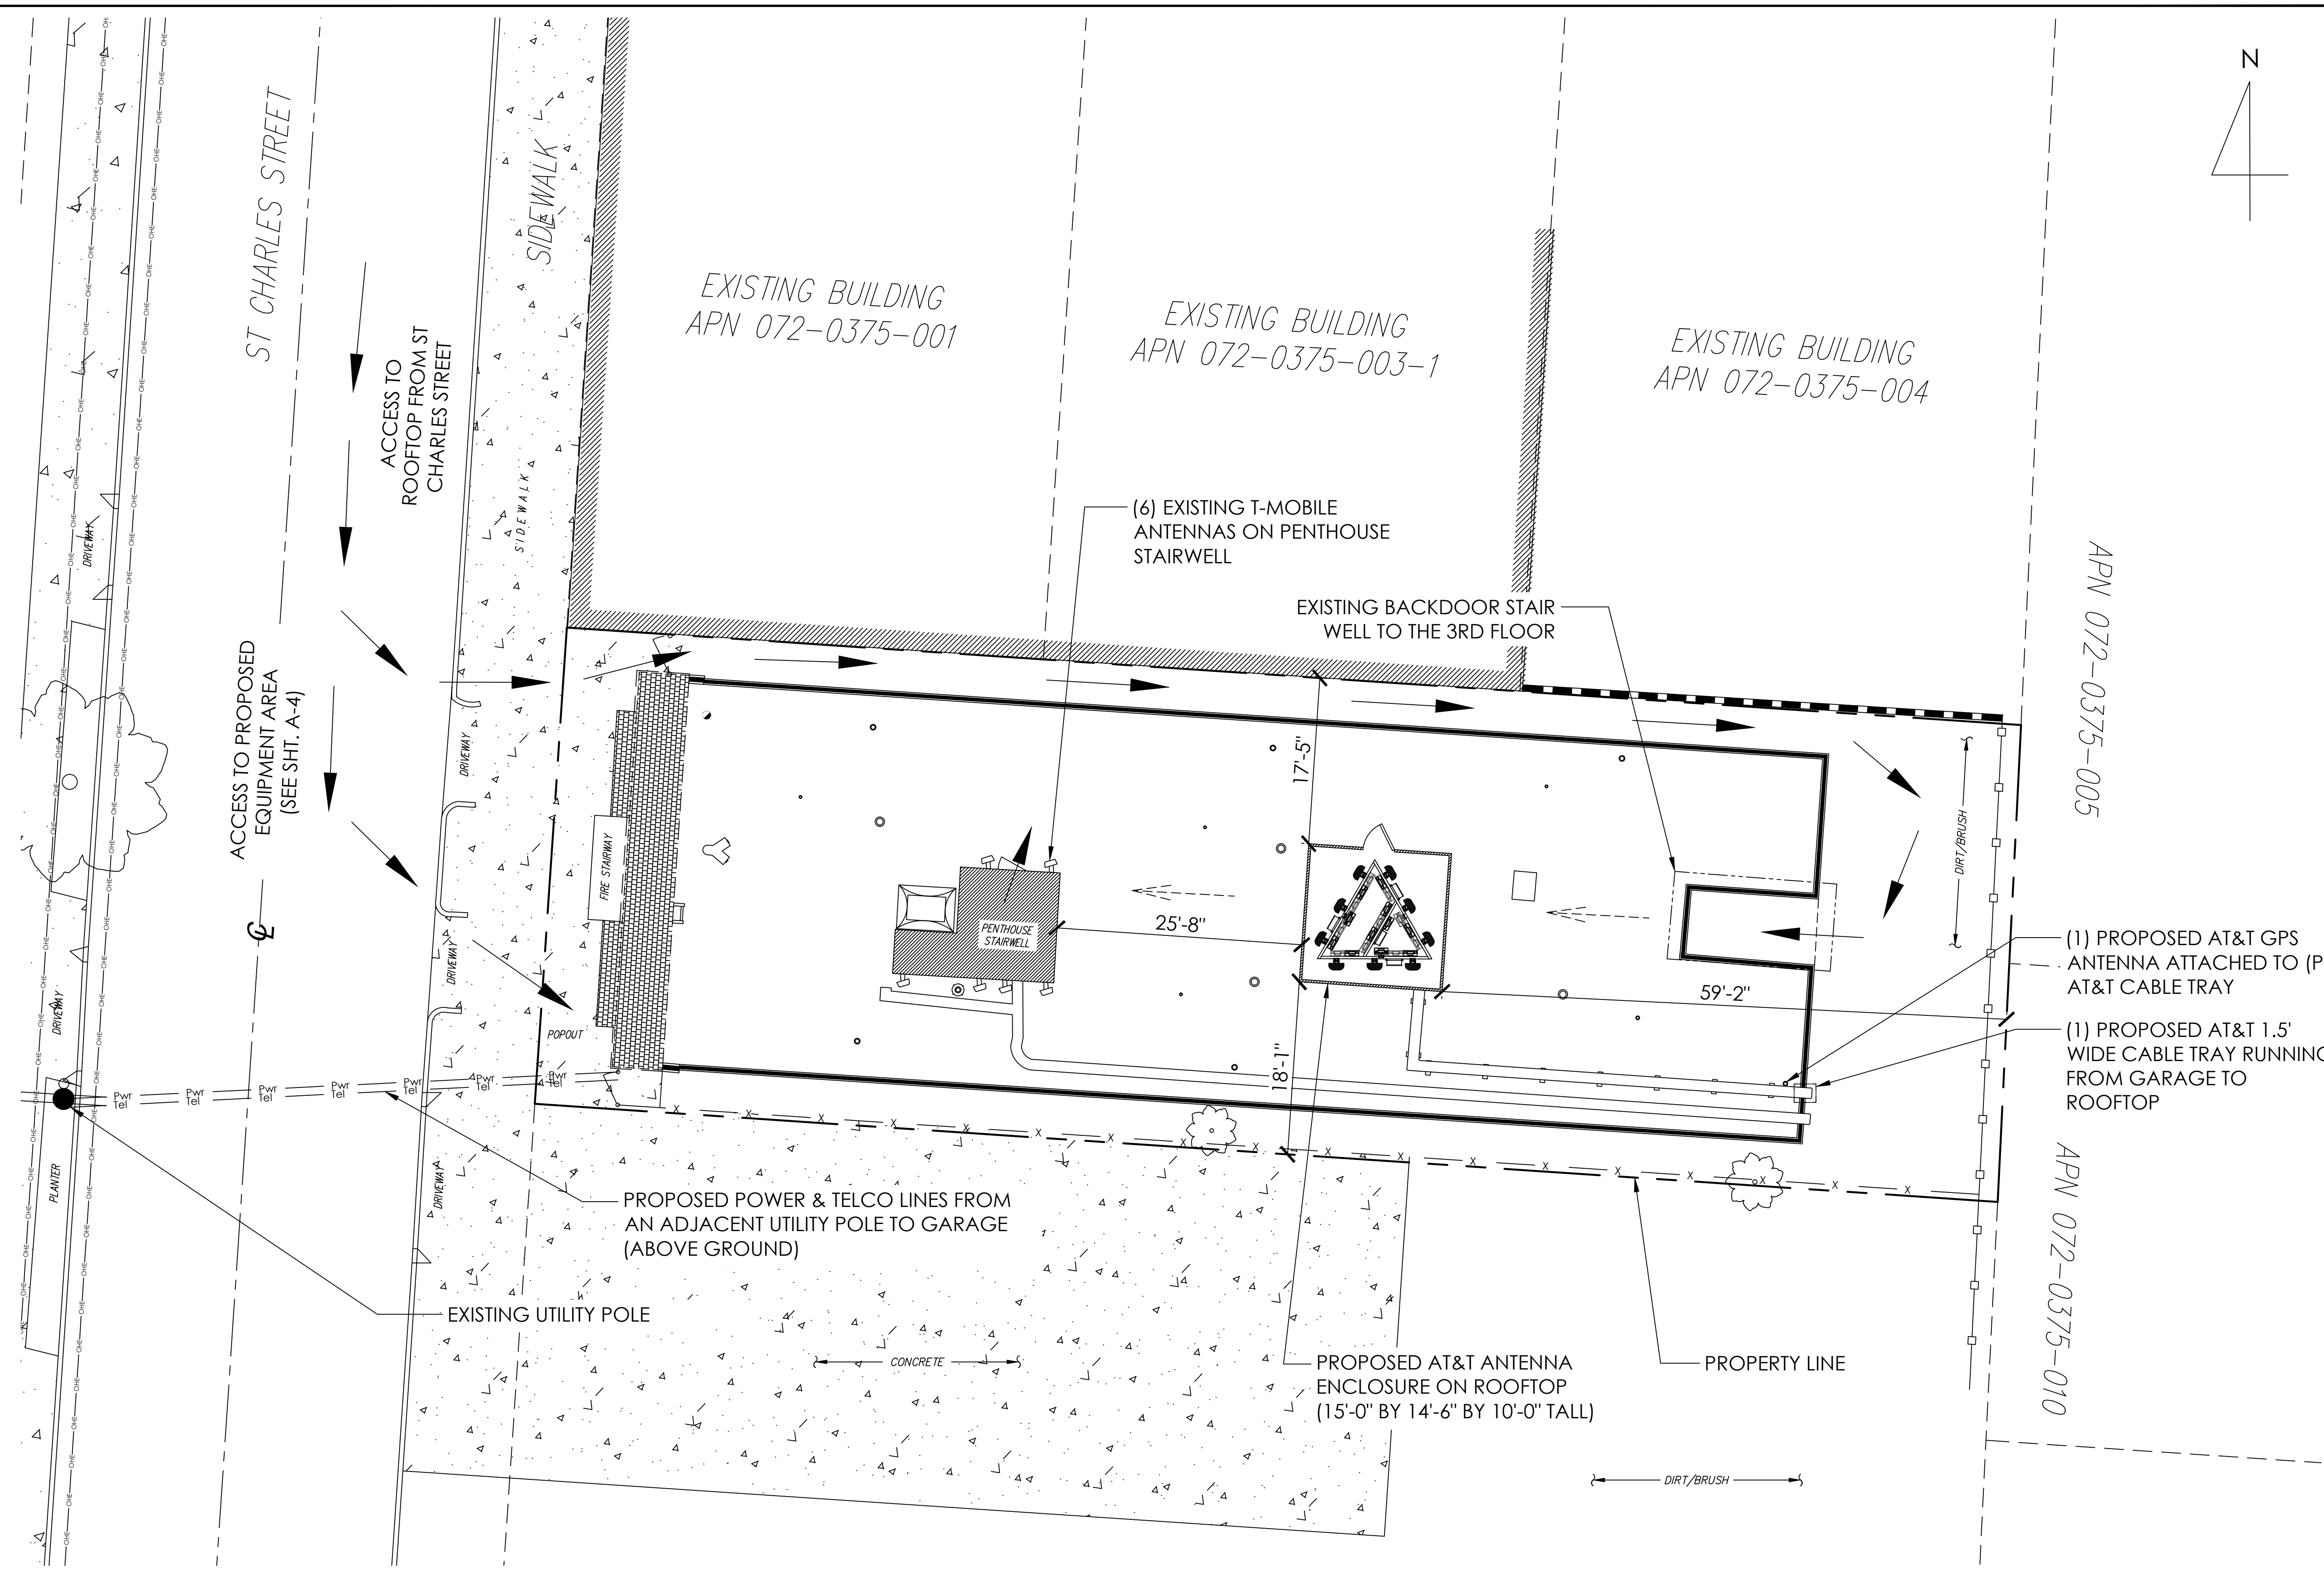
SHEET TITLE:

OVERALL  
SITE PLAN

SHEET NUMBER:

A-1





- NOTE:
1. EXIT ROUTE FROM ROOFTOP & EQUIPMENT AREA IS IDENTICAL TO ACCESS ROUTE
  2. EXISTING BACKDOOR STAIRWELL IS ONLY CONNECTED TO THE 3RD FLOOR. PERSONNEL NEED TO WALK THRU THE 3RD FLOOR CORRIDOR AND USE STAIRS TO REACH TO ROOFTOP
  3. PROPOSED CABLE TRAY TO BE PAINTED TO MATCH EXISTING BUILDING COLOR

ENLARGED SITE PLAN VIEW  
1/8" = 1'-0"

PREPARED FOR

5001 Executive Parkway  
San Ramon, California 94583

Vendor:

14621 Arroyo Honda  
San Diego, CA 92127

AT&T Site ID:

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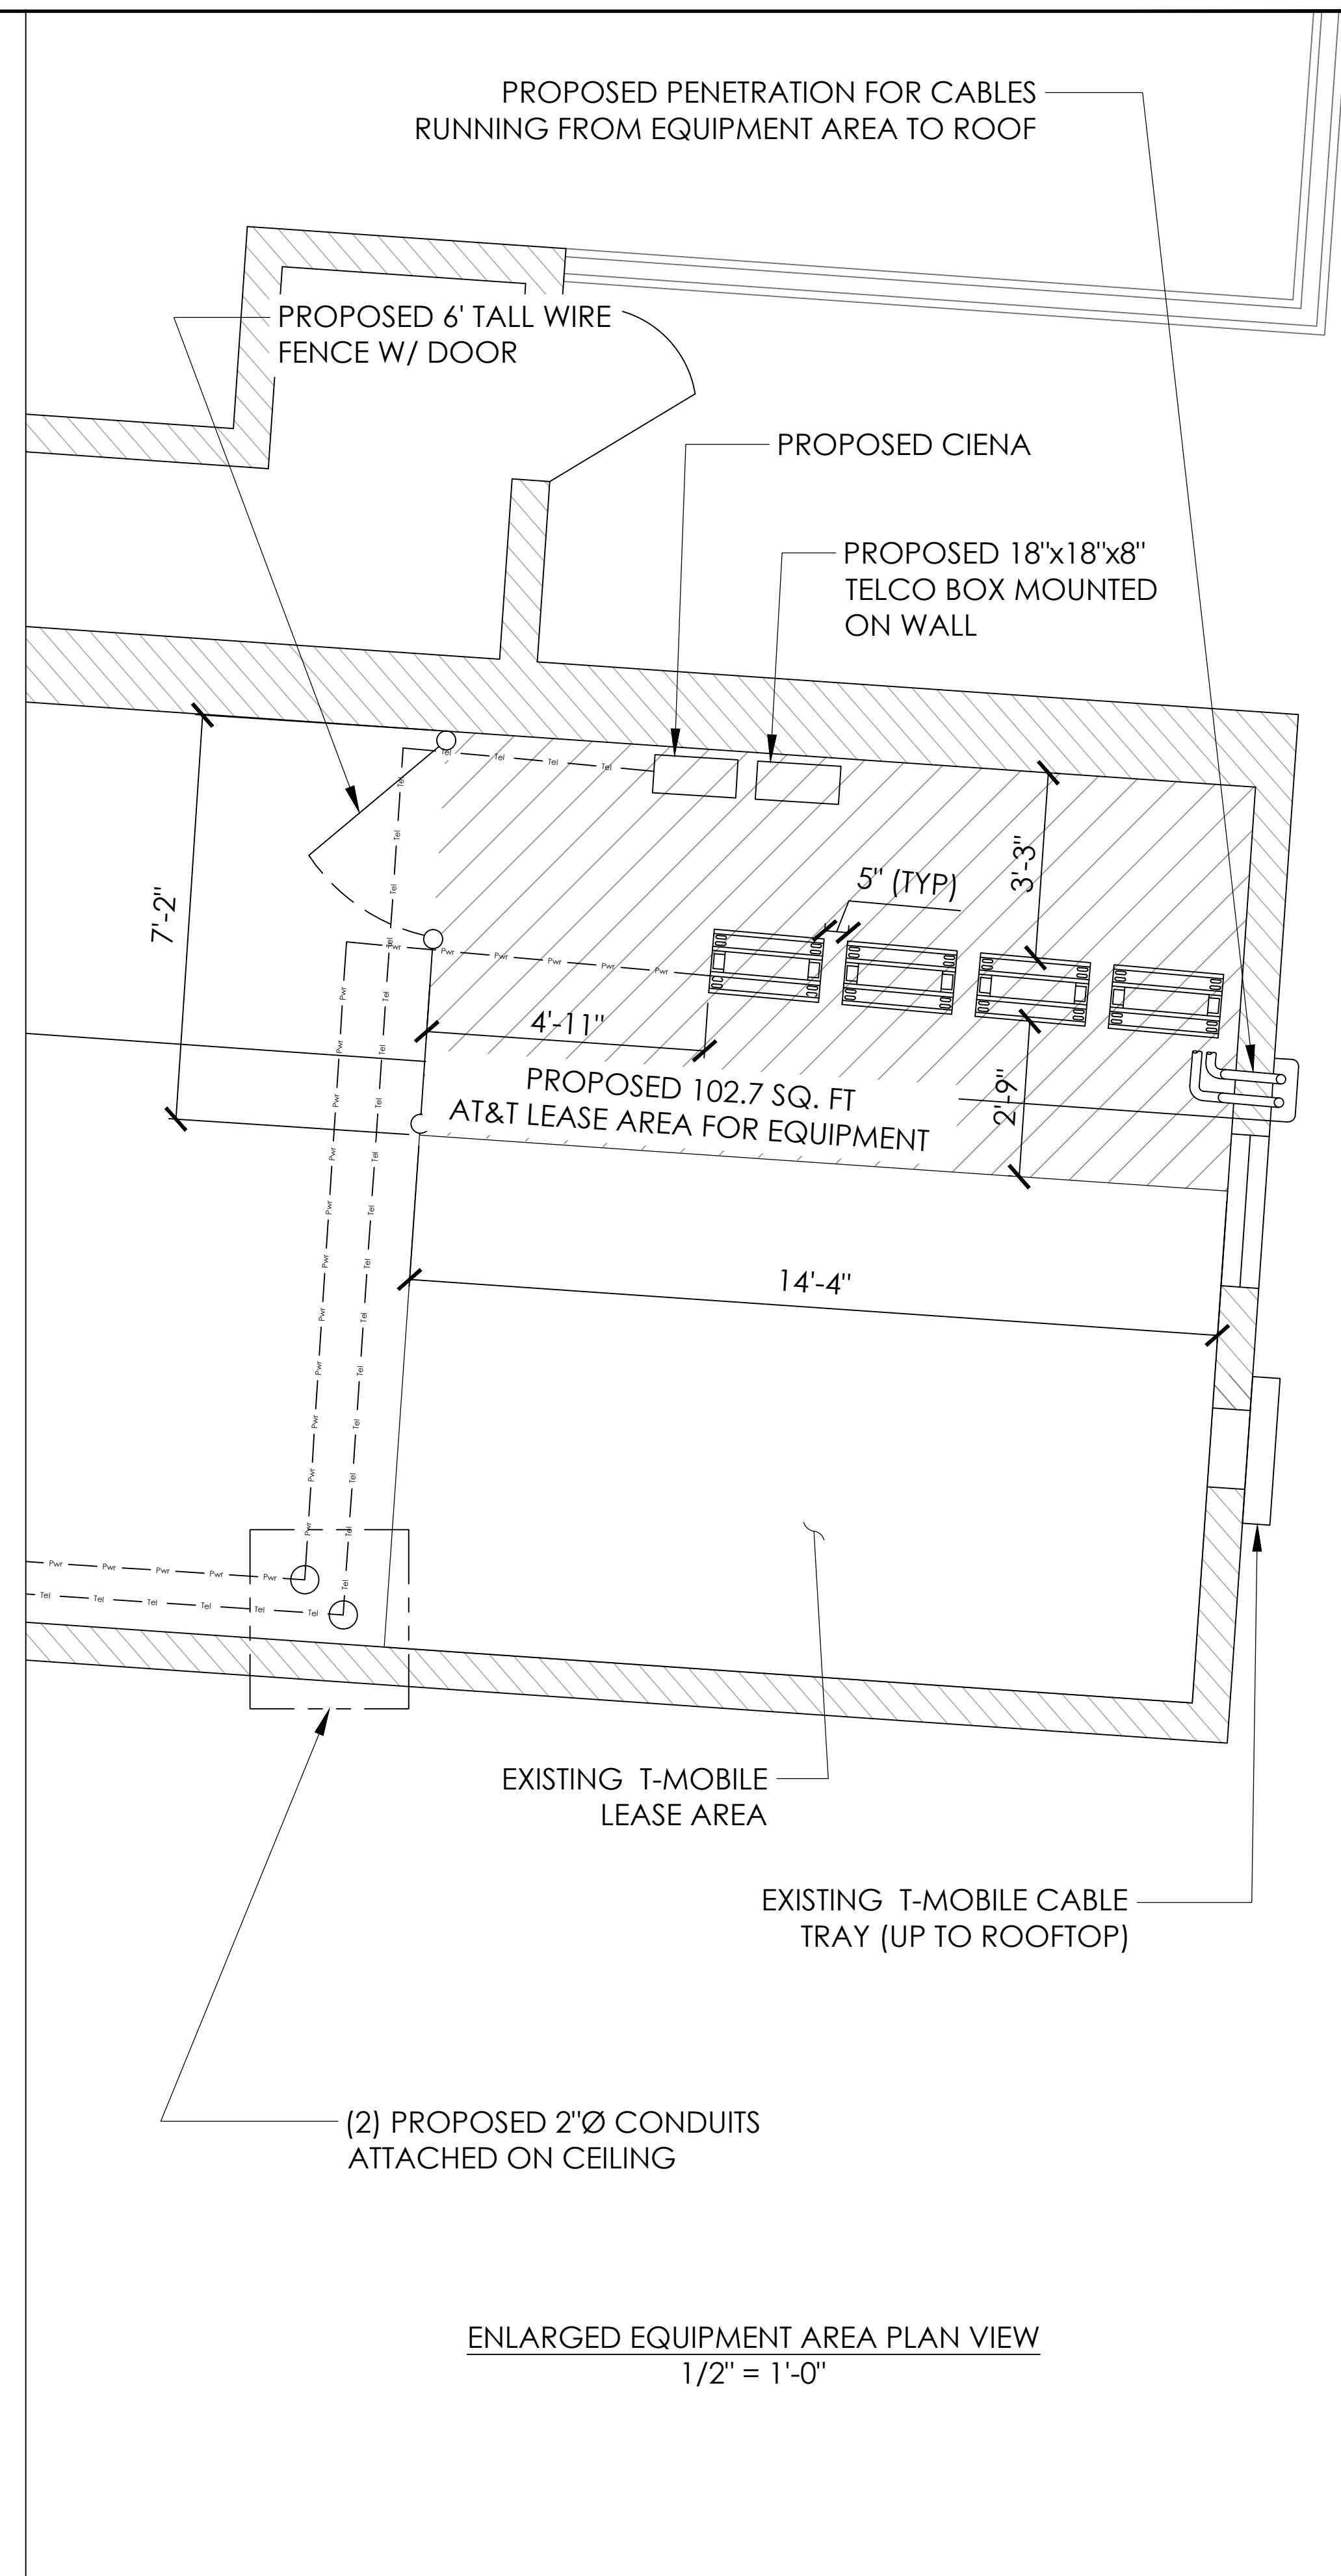
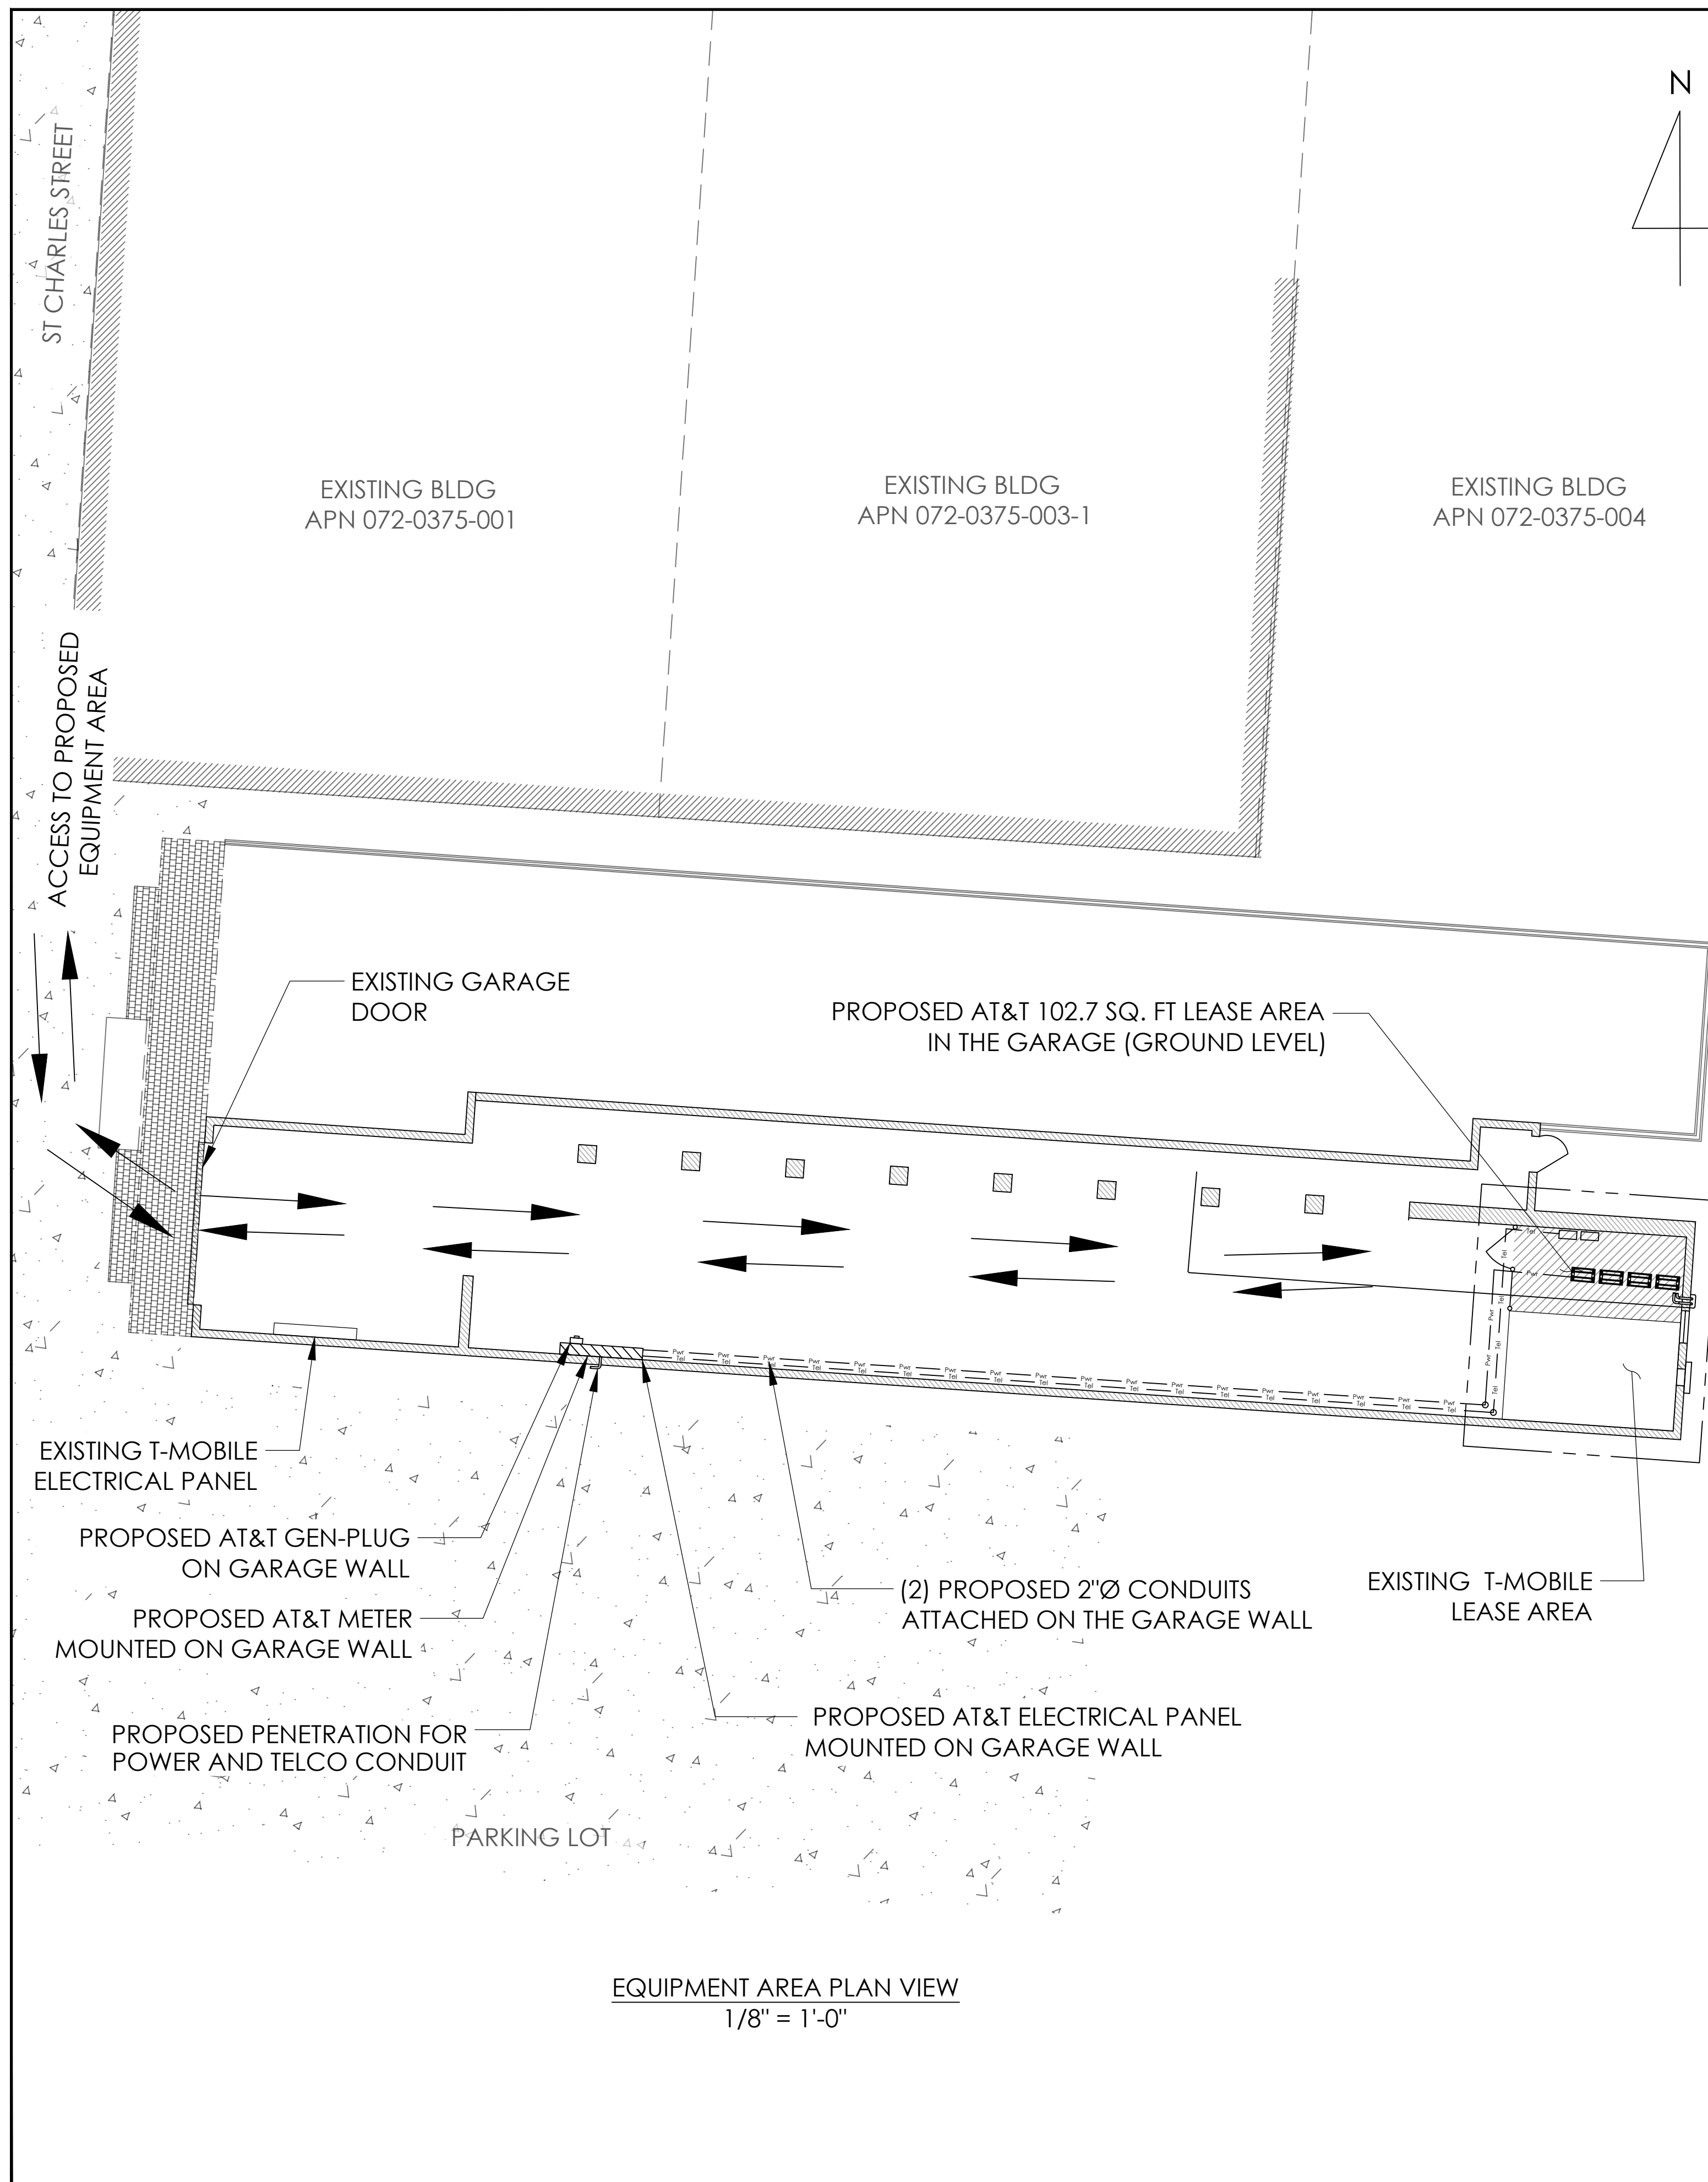
SHEET TITLE:

ENLARGED  
SITE PLAN

SHEET NUMBER:

**A-2**





PREPARED FOR

5001 Executive Parkway  
San Ramon, California 94583

Vendor:

14621 Arroyo Honda  
San Diego, CA 92127

AT&T Site ID:

CCU3085

AT&T SITE NO: CCU3085

PROJECT CODE: -----

DRAWN BY: SO

CHECKED BY: JF

REV	DATE	DESCRIPTION
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**CHARLES RELO**  
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ALAMEDA, CA 94501  
ALAMEDA COUNTY

SHEET TITLE:

PROPOSED EQUIPMENT AREA  
PLAN VIEW


SHEET NUMBER:

**A-3**



ERICSSON 700D/E RRH


MODEL: KRC161408/1  
COLOR: WHITE  
DIMENSIONS: 20" TALL X 20" WIDE X 9.05" DEEP (INCLUDING SUNSHIELD)  
WIEGHT: +/- 71.5LBS. (INCLUDING MOUNTING HARDWARE)

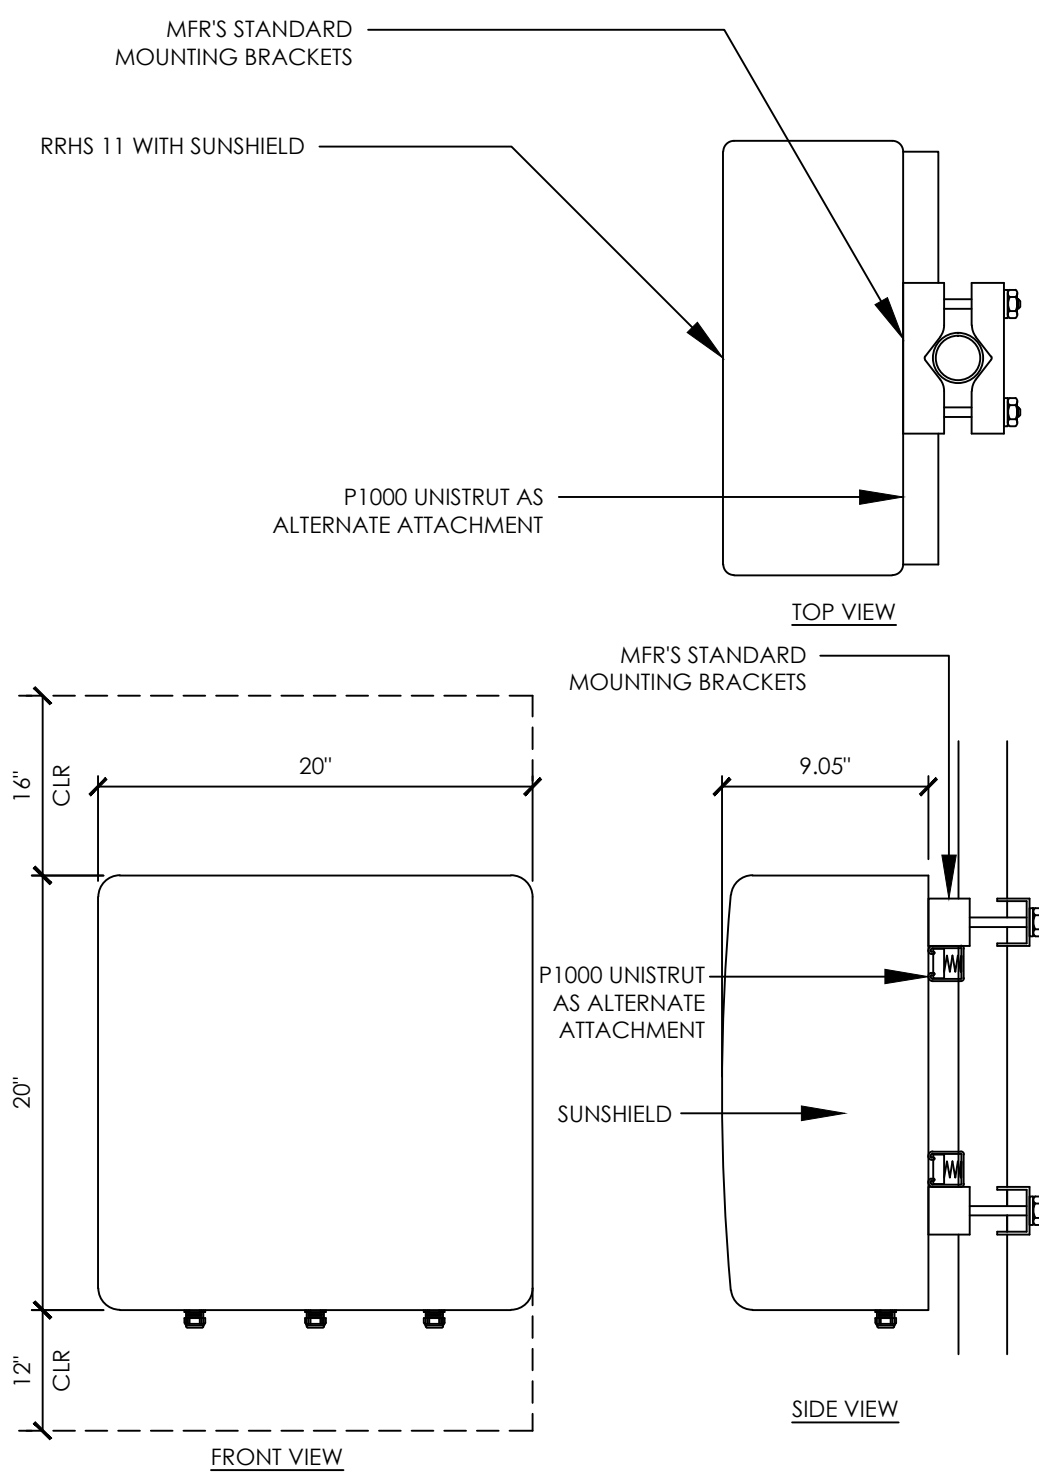

19 ERICSSON 700 D/E REMOTE RADIO UNIT  
1 1/2"=1'-0"

ERICSSON RRUS 11 REMOTE RADIO UNIT


COLOR: WHITE  
DIMENSIONS: 19.7" TALL X 17" WIDE X 7.2" DEEP (INCLUDING SUNSHIELD)  
WIEGHT: +/- 50 LBS. (INCLUDING MOUNTING HARDWARE)

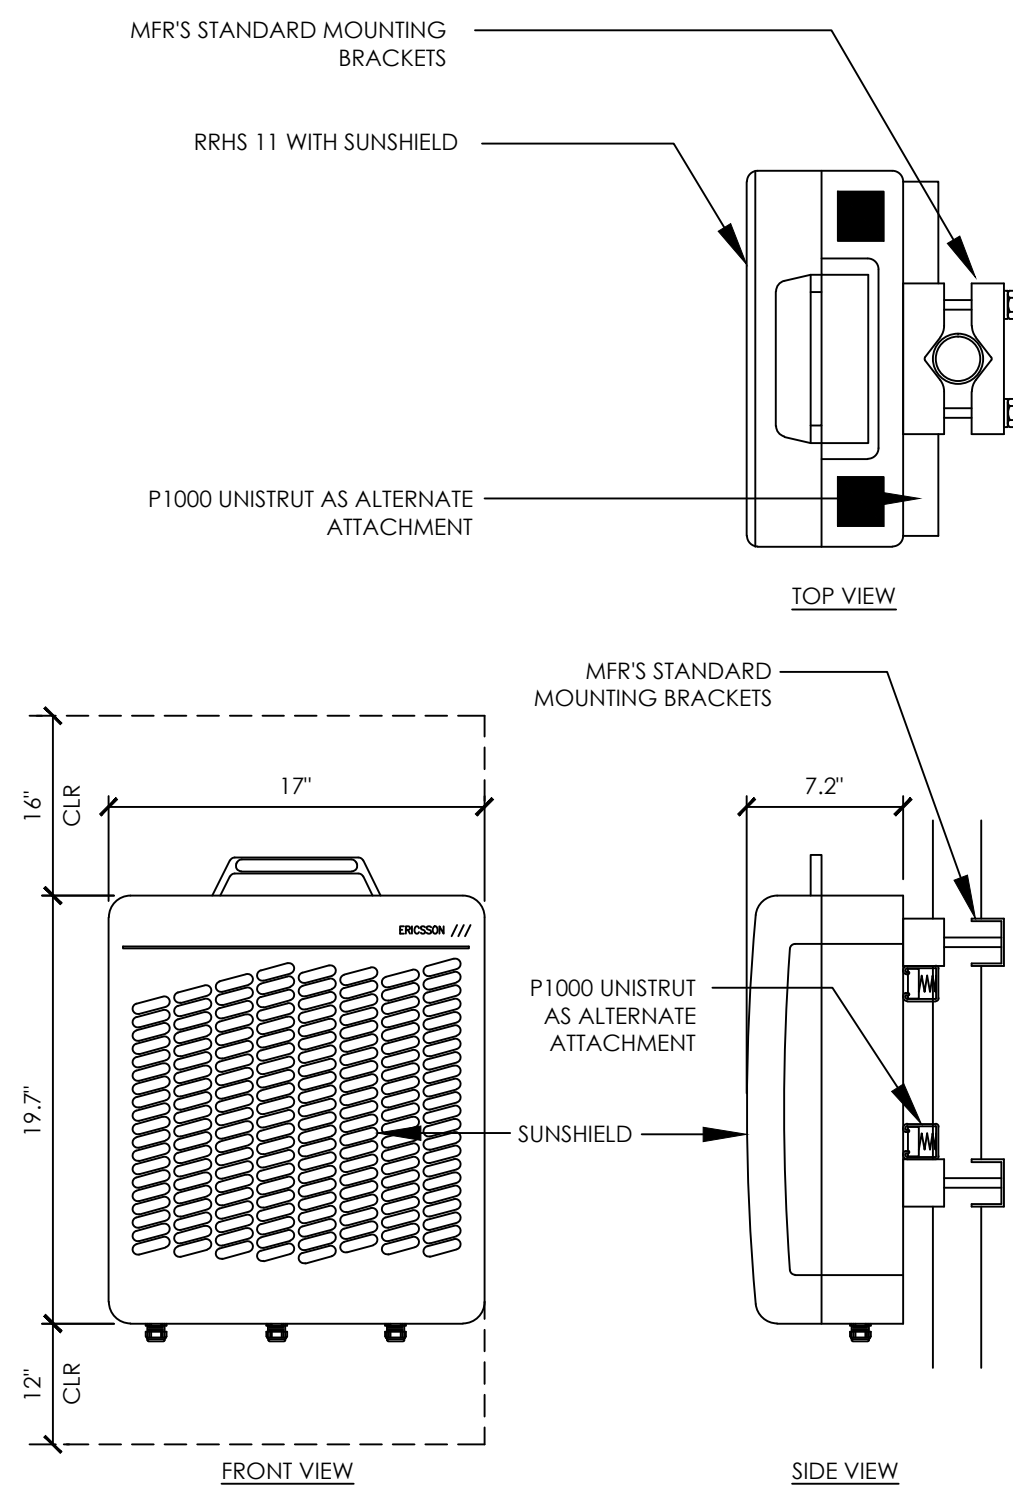


17 ERICSSON RRHS-11 REMOTE RADIO UNIT  
1 1/2"=1'-0"

ERICSSON WCS RRH-32

MODEL: KRC161 423/1  
COLOR: WHITE  
DIMENSIONS: 29.9" TALL X 13.3" WIDE X 9.5" DEEP (INCLUDING SUNSHIELD)  
WIEGHT: +/- 77LBS. (INCLUDING MOUNTING HARDWARE)

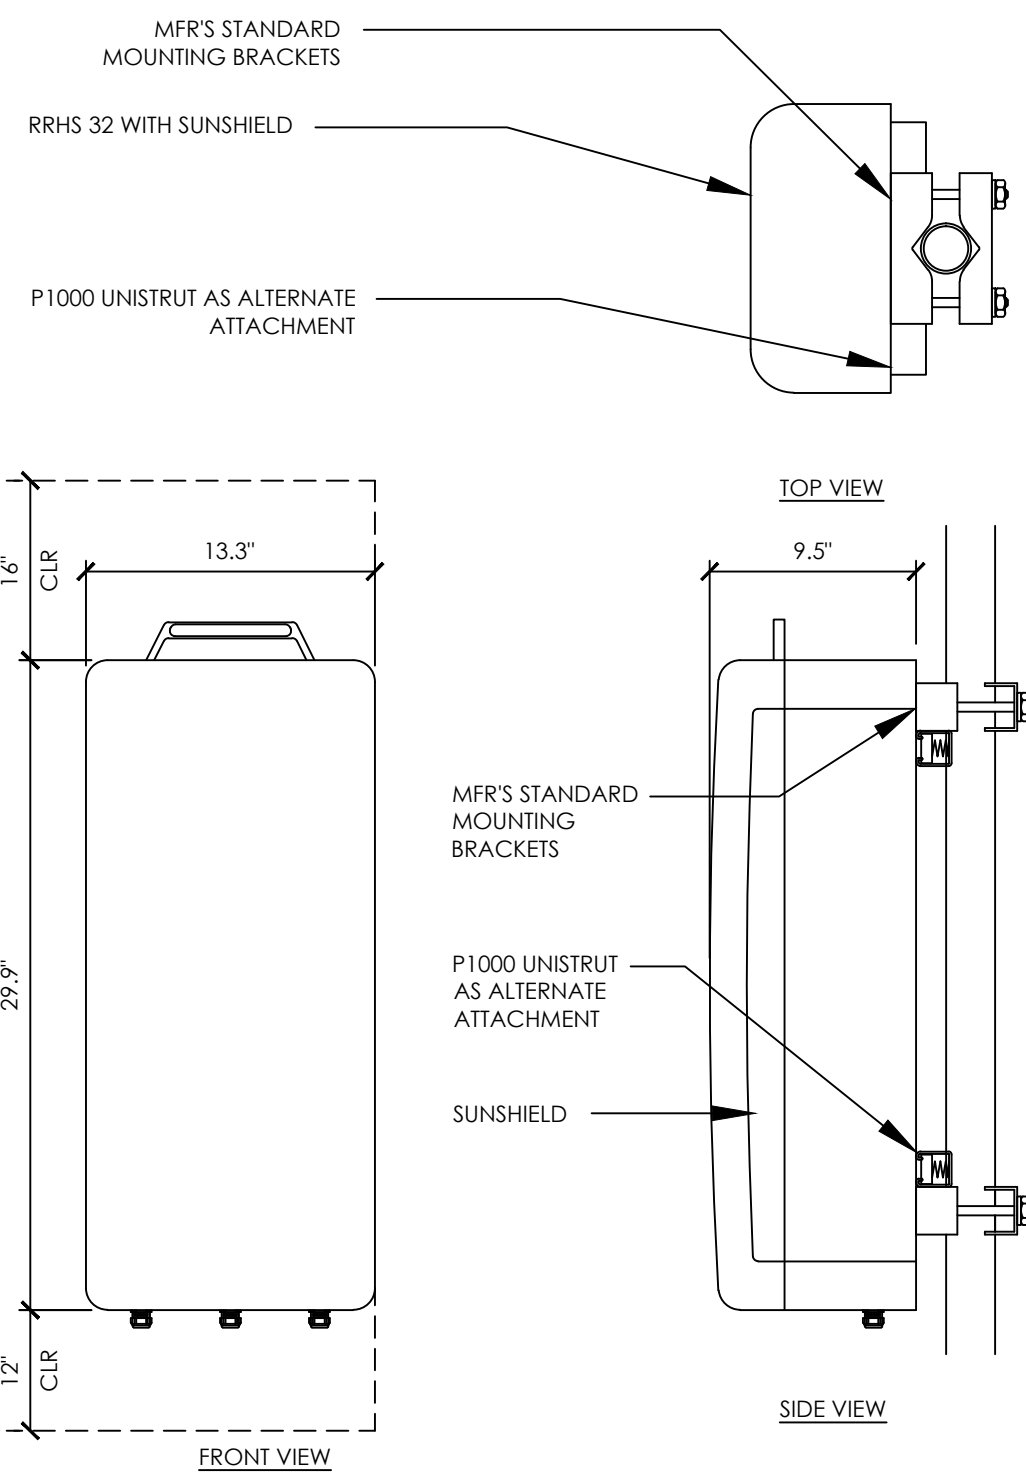

15 ERICSSON WCS RRHS-32 REMOTE RADIO UNIT  
1 1/2"=1'-0"

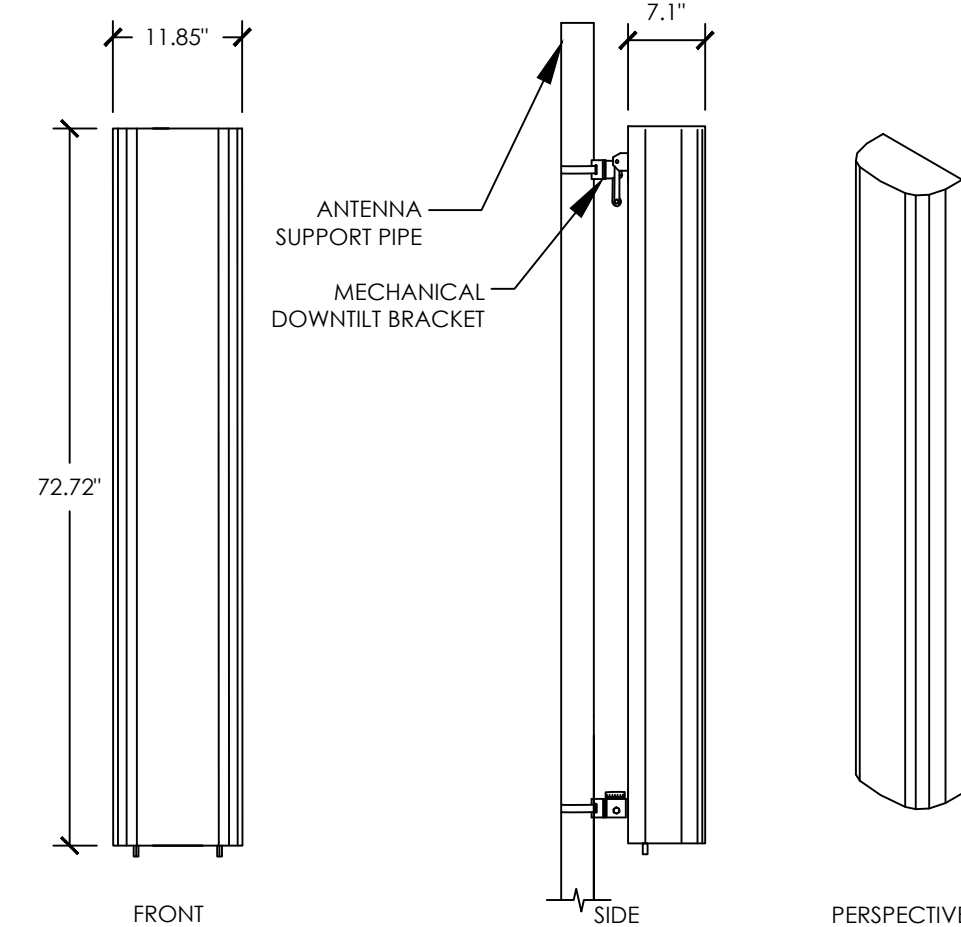


ANTENNA = SBNHH-1D65B  
WIND AREA = 5.98 SQ.FT.  
WEIGHT = 50.71 LBS (23.0 KG)  
DIMENSIONS = 72.72" (H) x 11.85" (W) x 7.1" (D)

13 HEX ANTENNA SPEC  
3/4"=1'-0"

ERICSSON RRHS A2 REMOTE RADIO UNIT

COLOR: WHITE  
DIMENSIONS: 12.8" TALL X 14.7" WIDE X 3.2" DEEP  
WEIGHT: +/- 15 LBS. (INCLUDING MOUNTING HARDWARE)

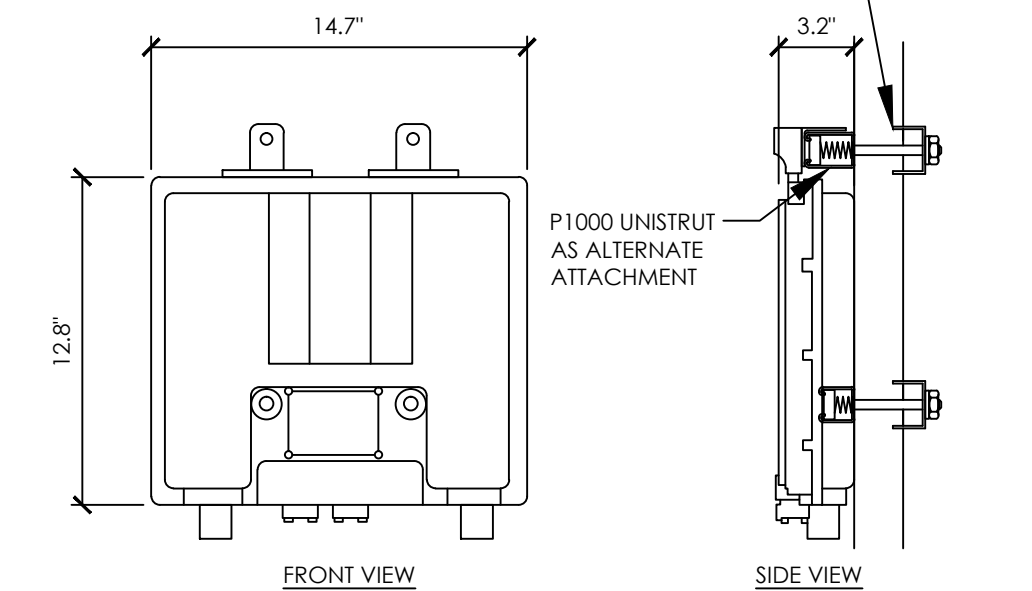


12 ERICSSON RRHS A2 REMOTE RADIO UNIT  
1 1/2"=1'-0"

RF SCHEDULE										
	SECTOR	ANTENNA MODEL NO.	AZIMUTH	RAD CENTER	RRH	TMA	FIBER LENGTH	COAX LENGTH	COAX DIA.	NO.
ALPHA	A1	SBNHH-1D65B	60°	± 44'-10"	(2) RRH & A2	N/A	± 100'-0"	± 6'-0"	1/2"	6
	A2	SBNHH-1D65B	60°	± 44'-10"	(3) RRH	N/A	± 100'-0"	± 6'-0"	1/2"	4
	A3	SBNHH-1D65B	60°	± 44'-10"	(2) RRH	N/A	± 100'-0"	± 6'-0"	1/2"	2
	A4	N/A	N/A	N/A	N/A	N/A	N/A	N/A	N/A	N/A
BETA	B1	SBNHH-1D65B	300°	± 44'-10"	(2) RRH & A2	N/A	± 100'-0"	± 6'-0"	1/2"	6
	B2	SBNHH-1D65B	300°	± 44'-10"	(3) RRH	N/A	± 100'-0"	± 6'-0"	1/2"	4
	B3	SBNHH-1D65B	300°	± 44'-10"	(2) RRH	N/A	± 100'-0"	± 6'-0"	1/2"	2
	B4	N/A	N/A	N/A	N/A	N/A	N/A	N/A	N/A	N/A
GAMMA	C1	SBNHH-1D65B	180°	± 44'-10"	(2) RRH & A2	N/A	± 100'-0"	± 6'-0"	1/2"	6
	C2	SBNHH-1D65B	180°	± 44'-10"	(3) RRH	N/A	± 100'-0"	± 6'-0"	1/2"	4
	C3	SBNHH-1D65B	180°	± 44'-10"	(2) RRH	N/A	± 100'-0"	± 6'-0"	1/2"	2
	C4	N/A	N/A	N/A	N/A	N/A	N/A	N/A	N/A	N/A

RF DATA SHEET V1.03.00 DATE: TBD

8 RF SCHEDULE  
NOT TO SCALE

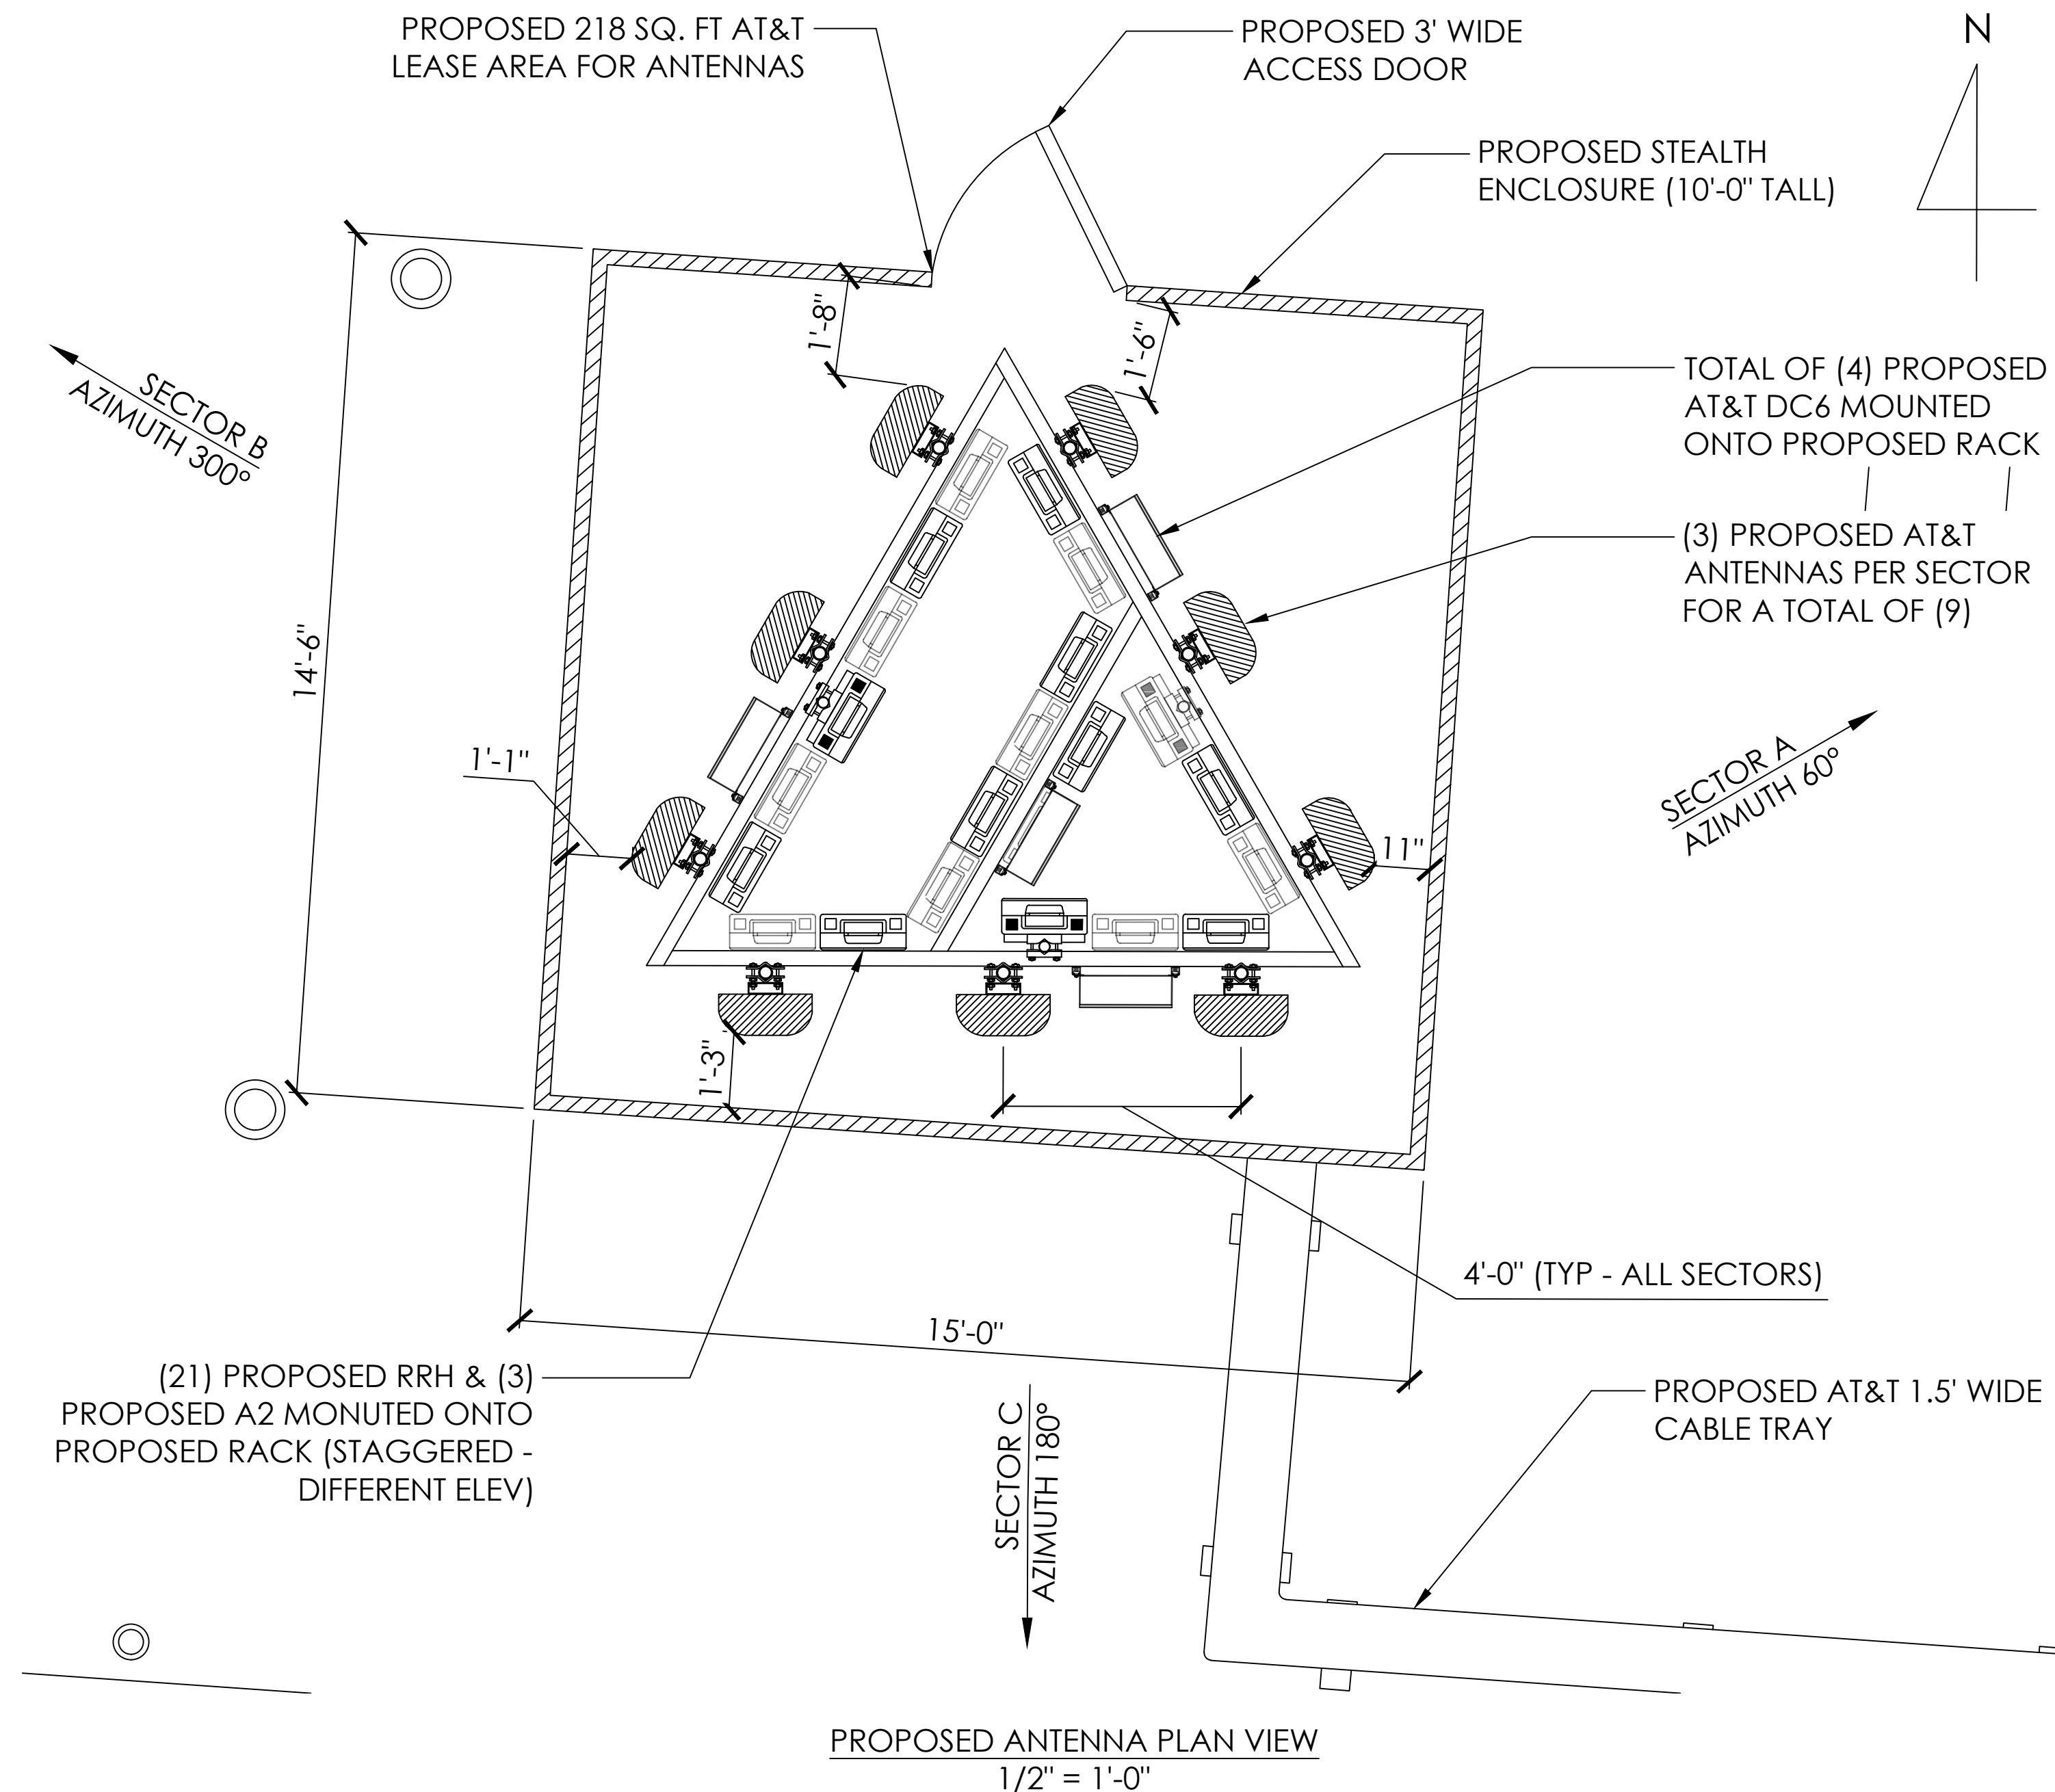

NOTE:  
1. TEXTURE AND COLOR OF THE PROPOSED PENTHOUSE SHALL MATCH THE EXISTING PENTHOUSE  
2. PROPOSED AT&T CABLE TRAY TO BE PAINTED TO MATCH EXISTING BUILDING COLOR

PREPARED FOR  
  
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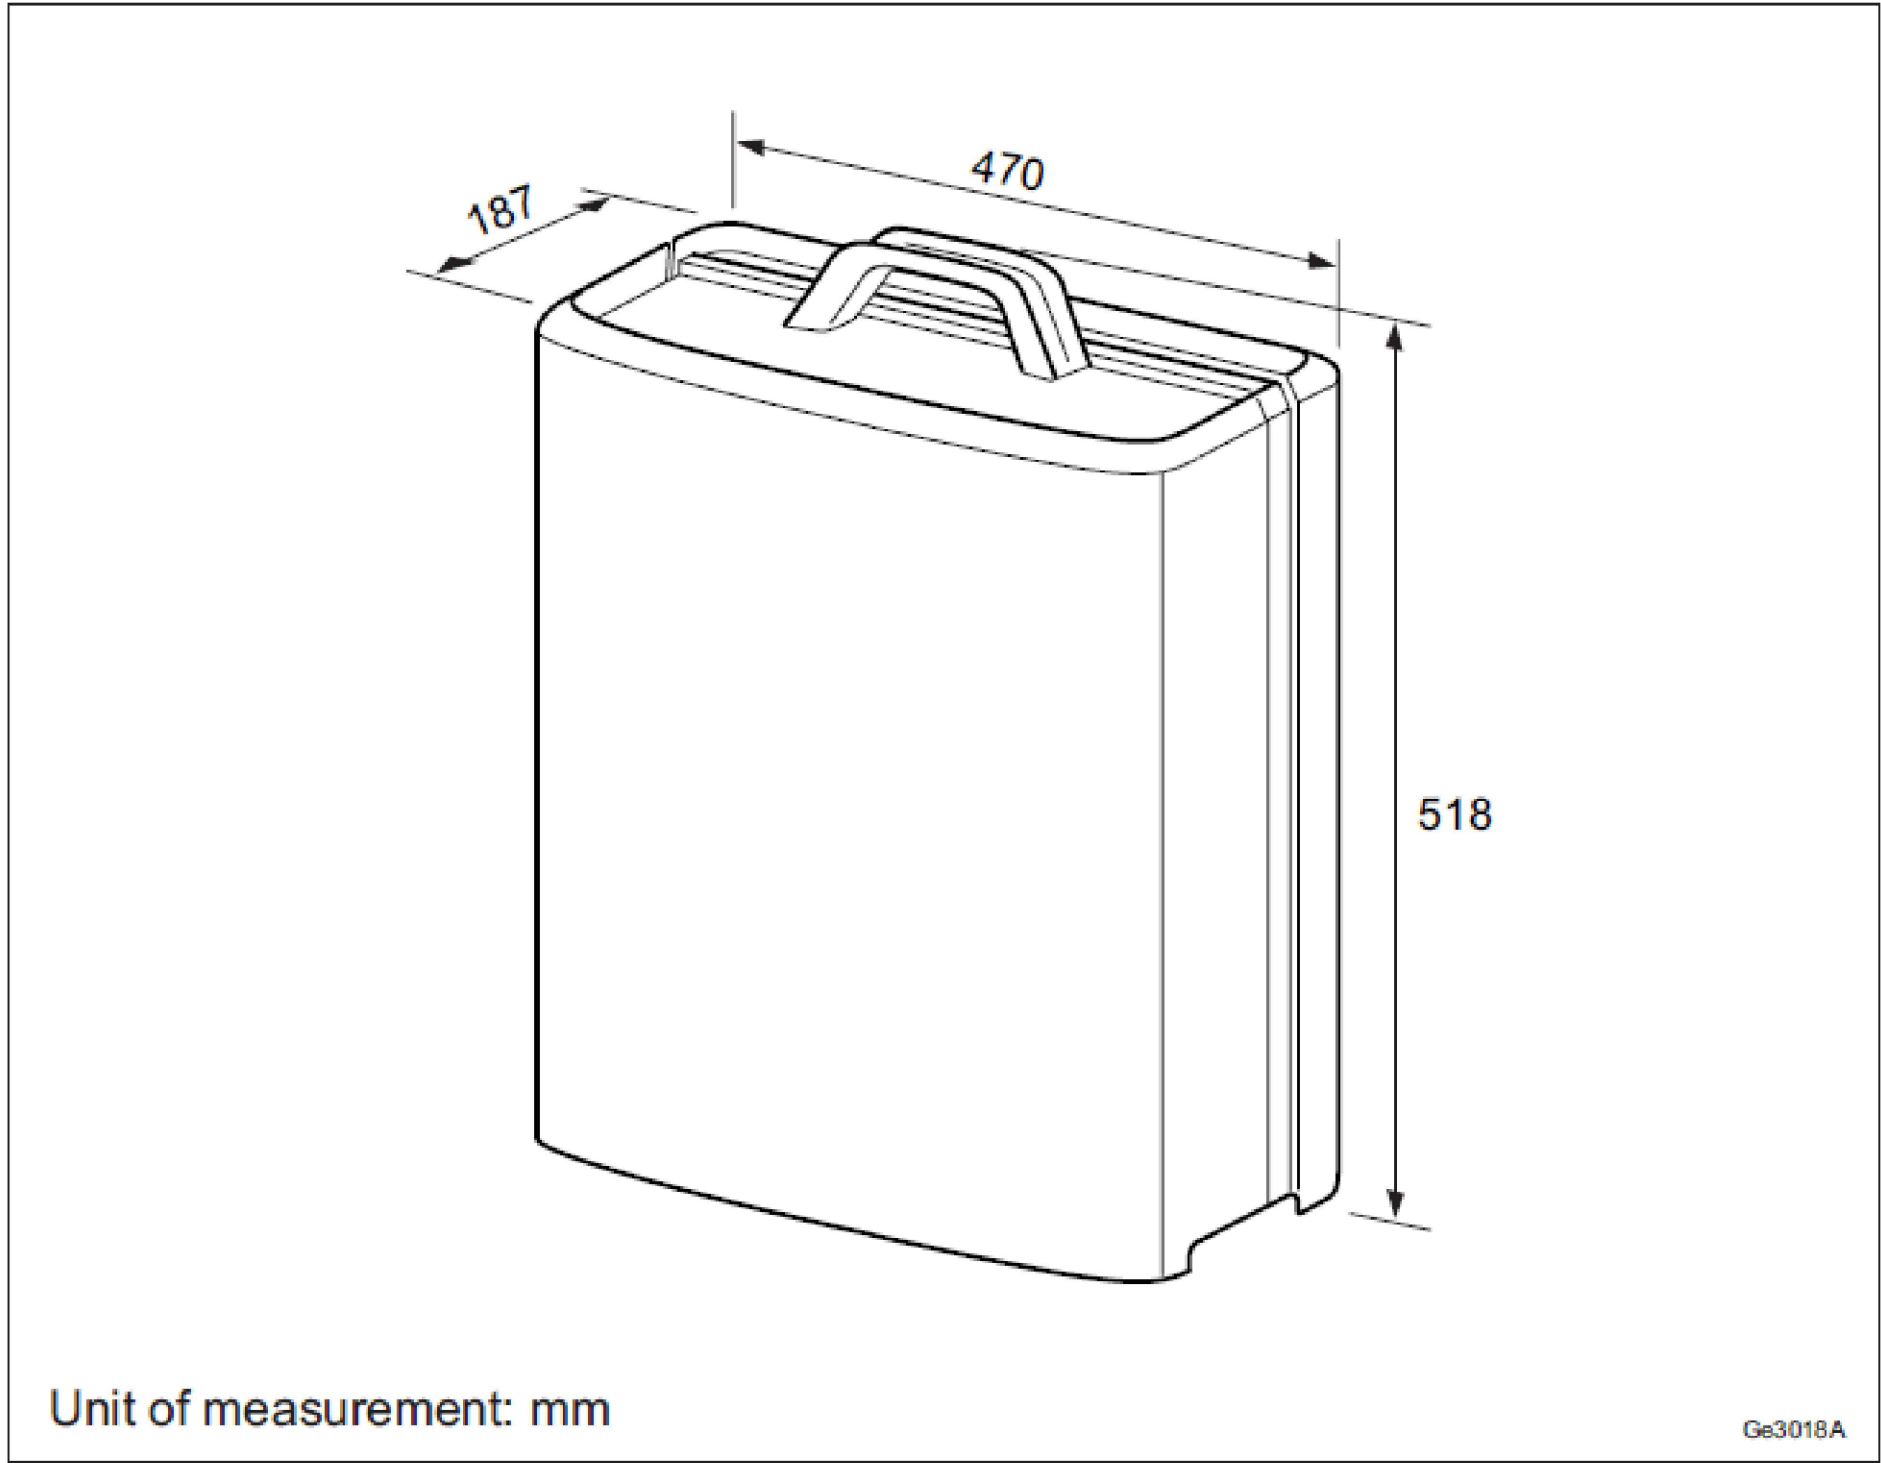
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ALAMEDA, CA 94501  
ALAMEDA COUNTY

SHEET TITLE:  
PROPOSED ANTENNA PLAN VIEW


SHEET NUMBER:  
**A-4**





Description	Value
Width	458 mm
Depth	159 mm
<b>Weight</b>	
RRH 12 B1, RRH 12 B2, RRH 12 B4, and RRH 12 B7	22.4 kg
RRH 12 B3, RRH 12 B5, and RRH 12 B8	26.3 kg
<b>Color</b>	
Gray	
(1) RRH 12 B2 supports only horizontal mounting for 2x20 W and 2x40 W power levels. (2) RRH 12 B7 supports only 2x20 W, and 2x40 W power levels. (3) Information about IBW can be found in RBS Configurations	


RRH-12 SPECIFICATION  
N.T.S.

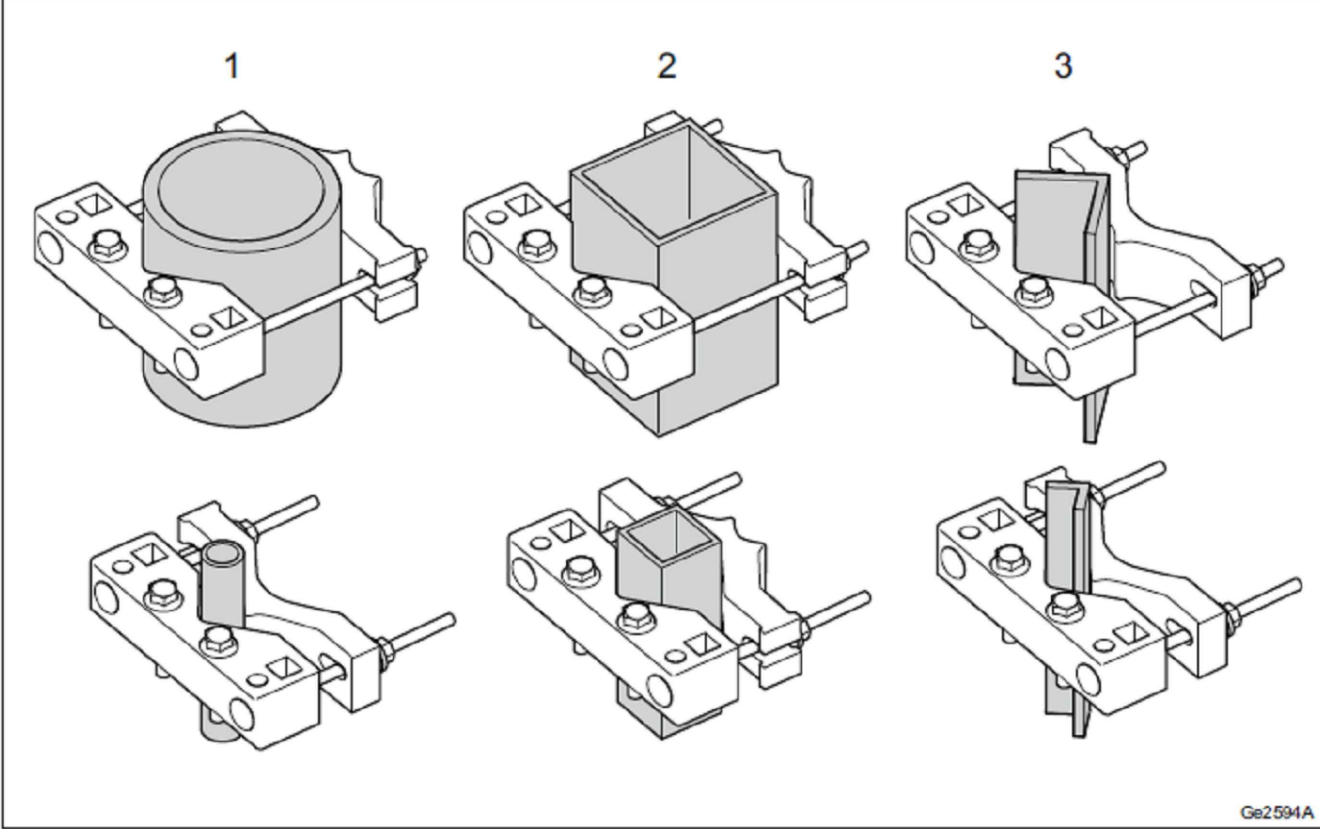

Cross Section	Minimum dimension (mm)	Maximum dimension (mm)
1. Circular	Ø25 <sup>(1)</sup>	Ø120
2. Square	40x40	80x80
3. 90°	20x20 <sup>(2)</sup>	55x55

(1) For triple unit installation, the minimum pole dimension is Ø50 mm  
(2) For triple unit installation, the minimum pole dimension is 45x45 mm

RRH-12 MOUNTING DEVICES  
N.T.S.

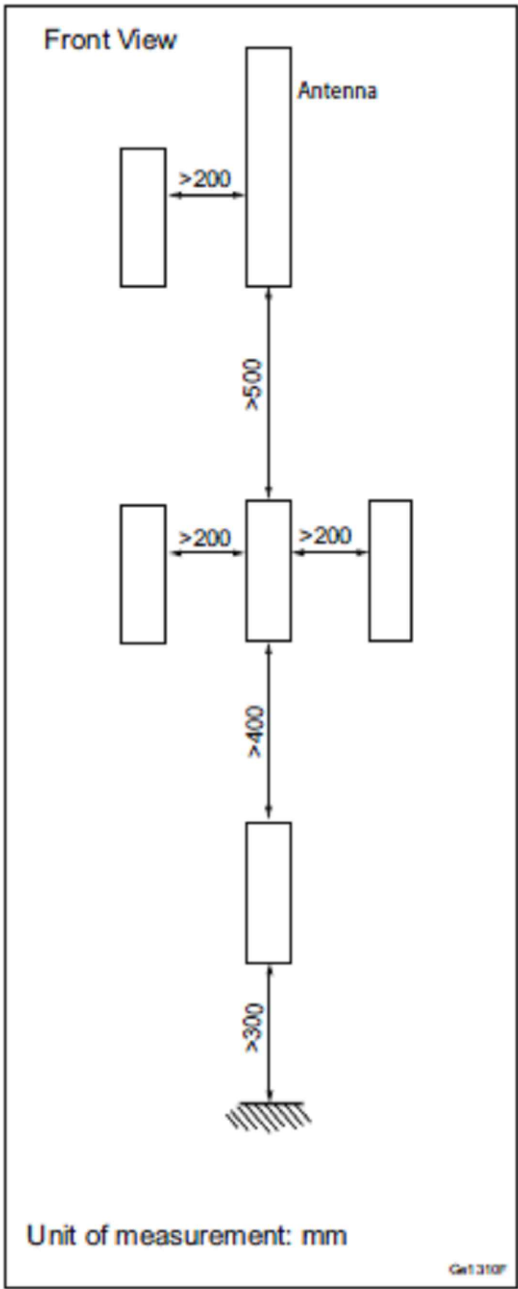

RRH-12 OUTDOOR SPACING REQUIREMENTS  
N.T.S.

PREPARED FOR



at&t  
Mobility

5001 Executive Parkway  
San Ramon, California 94583

Vendor:



Cortel

14621 Arroyo Honda  
San Diego, CA 92127

AT&T Site ID:

CCU3085

AT&T SITE NO:	CCU3085
PROJECT CODE:	-----
DRAWN BY:	SO
CHECKED BY:	JF

4	01/22/15	ZD 100%
3	01/09/15	ZD 100%
2	12/22/14	ZD 100%
1	11/26/14	ZD 100%
0	11/16/14	ZD 100%
REV	DATE	DESCRIPTION

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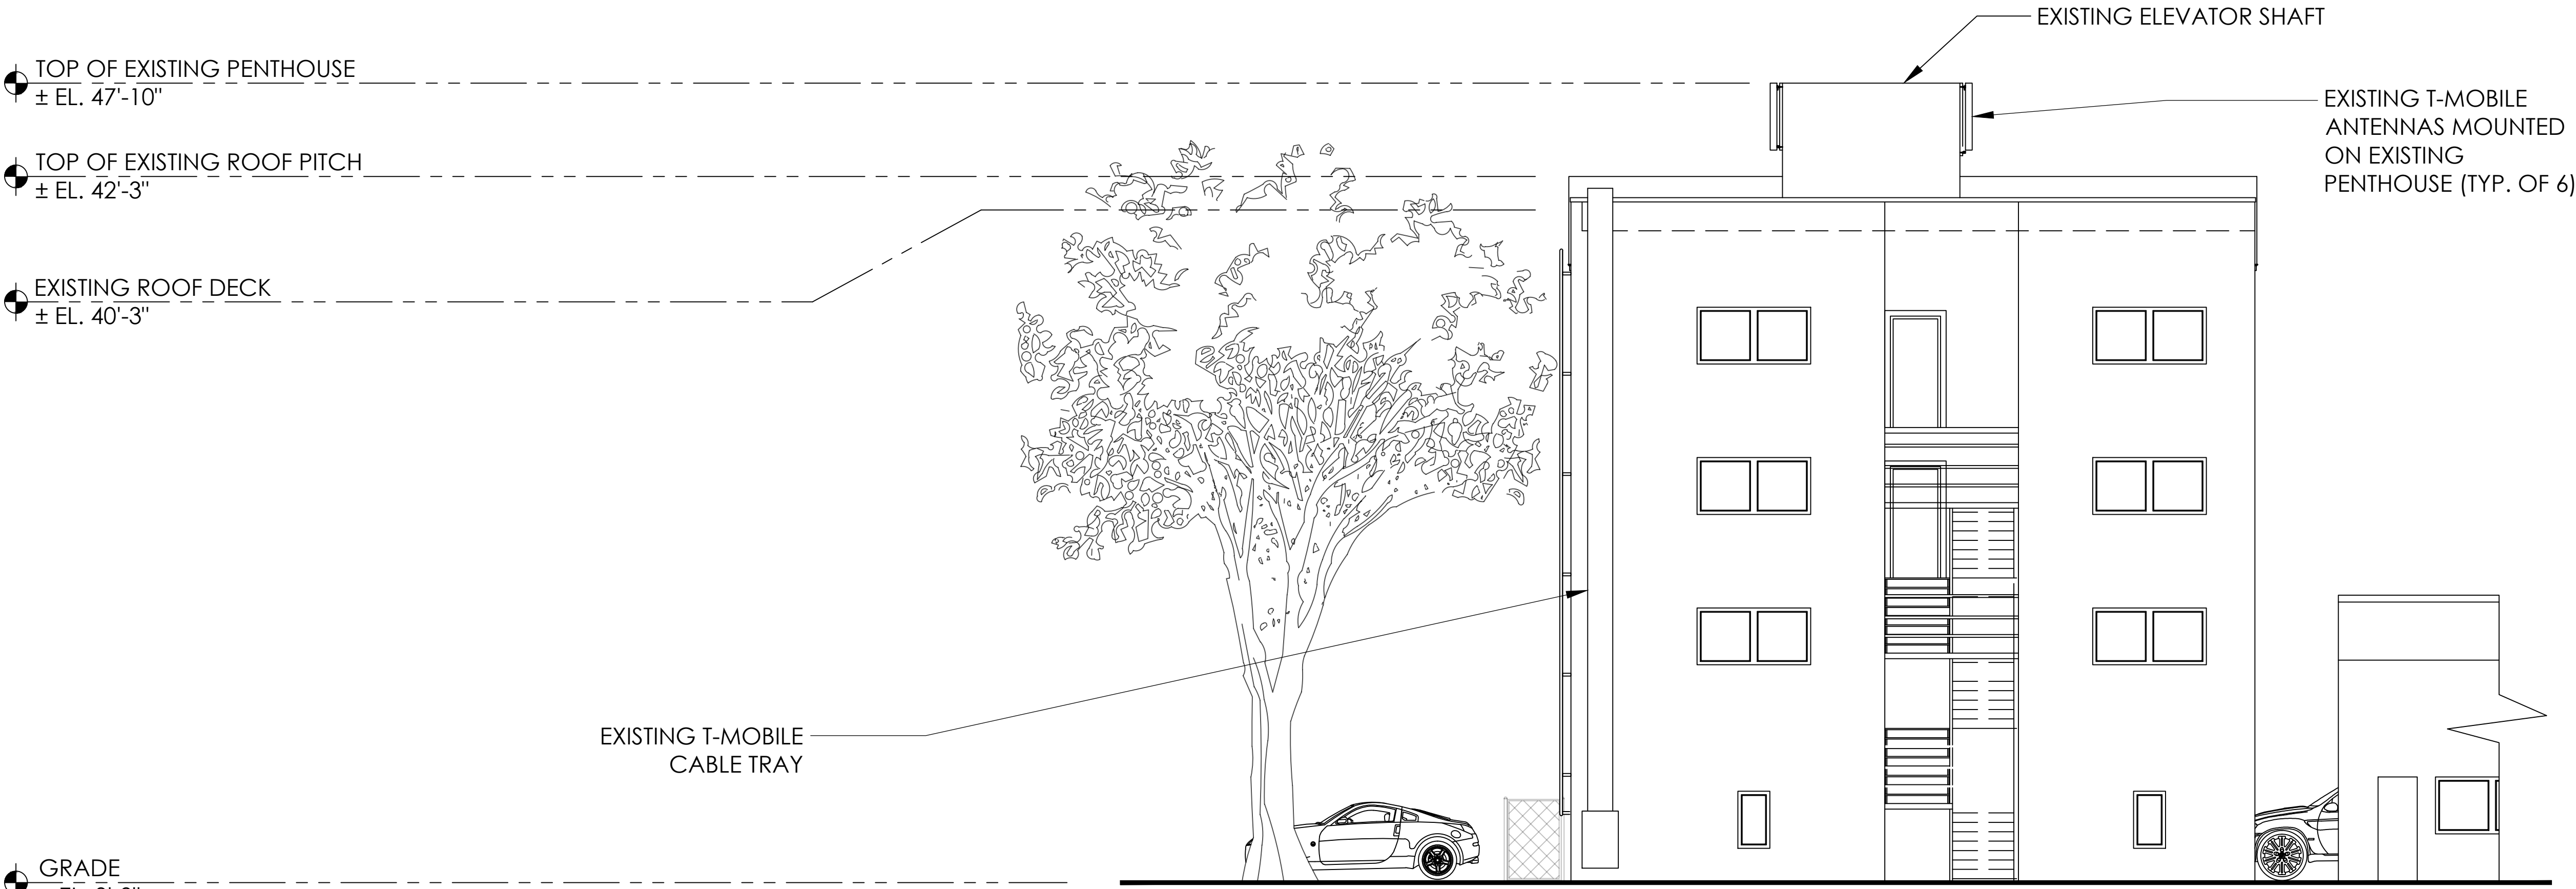
**CCU3085**  
**CENTRAL & ST**  
**CHARLES RELO**  
**1538 ST CHARLES ST**  
**ALAMEDA, CA 94501**  
**ALAMEDA COUNTY**

SHEET TITLE:


PROPOSED ANTENNA PLAN  
VIEW

SHEET NUMBER:

**A-4.1**



EXISTING WEST ELEVATION VIEW  
3/16" = 1'-0"

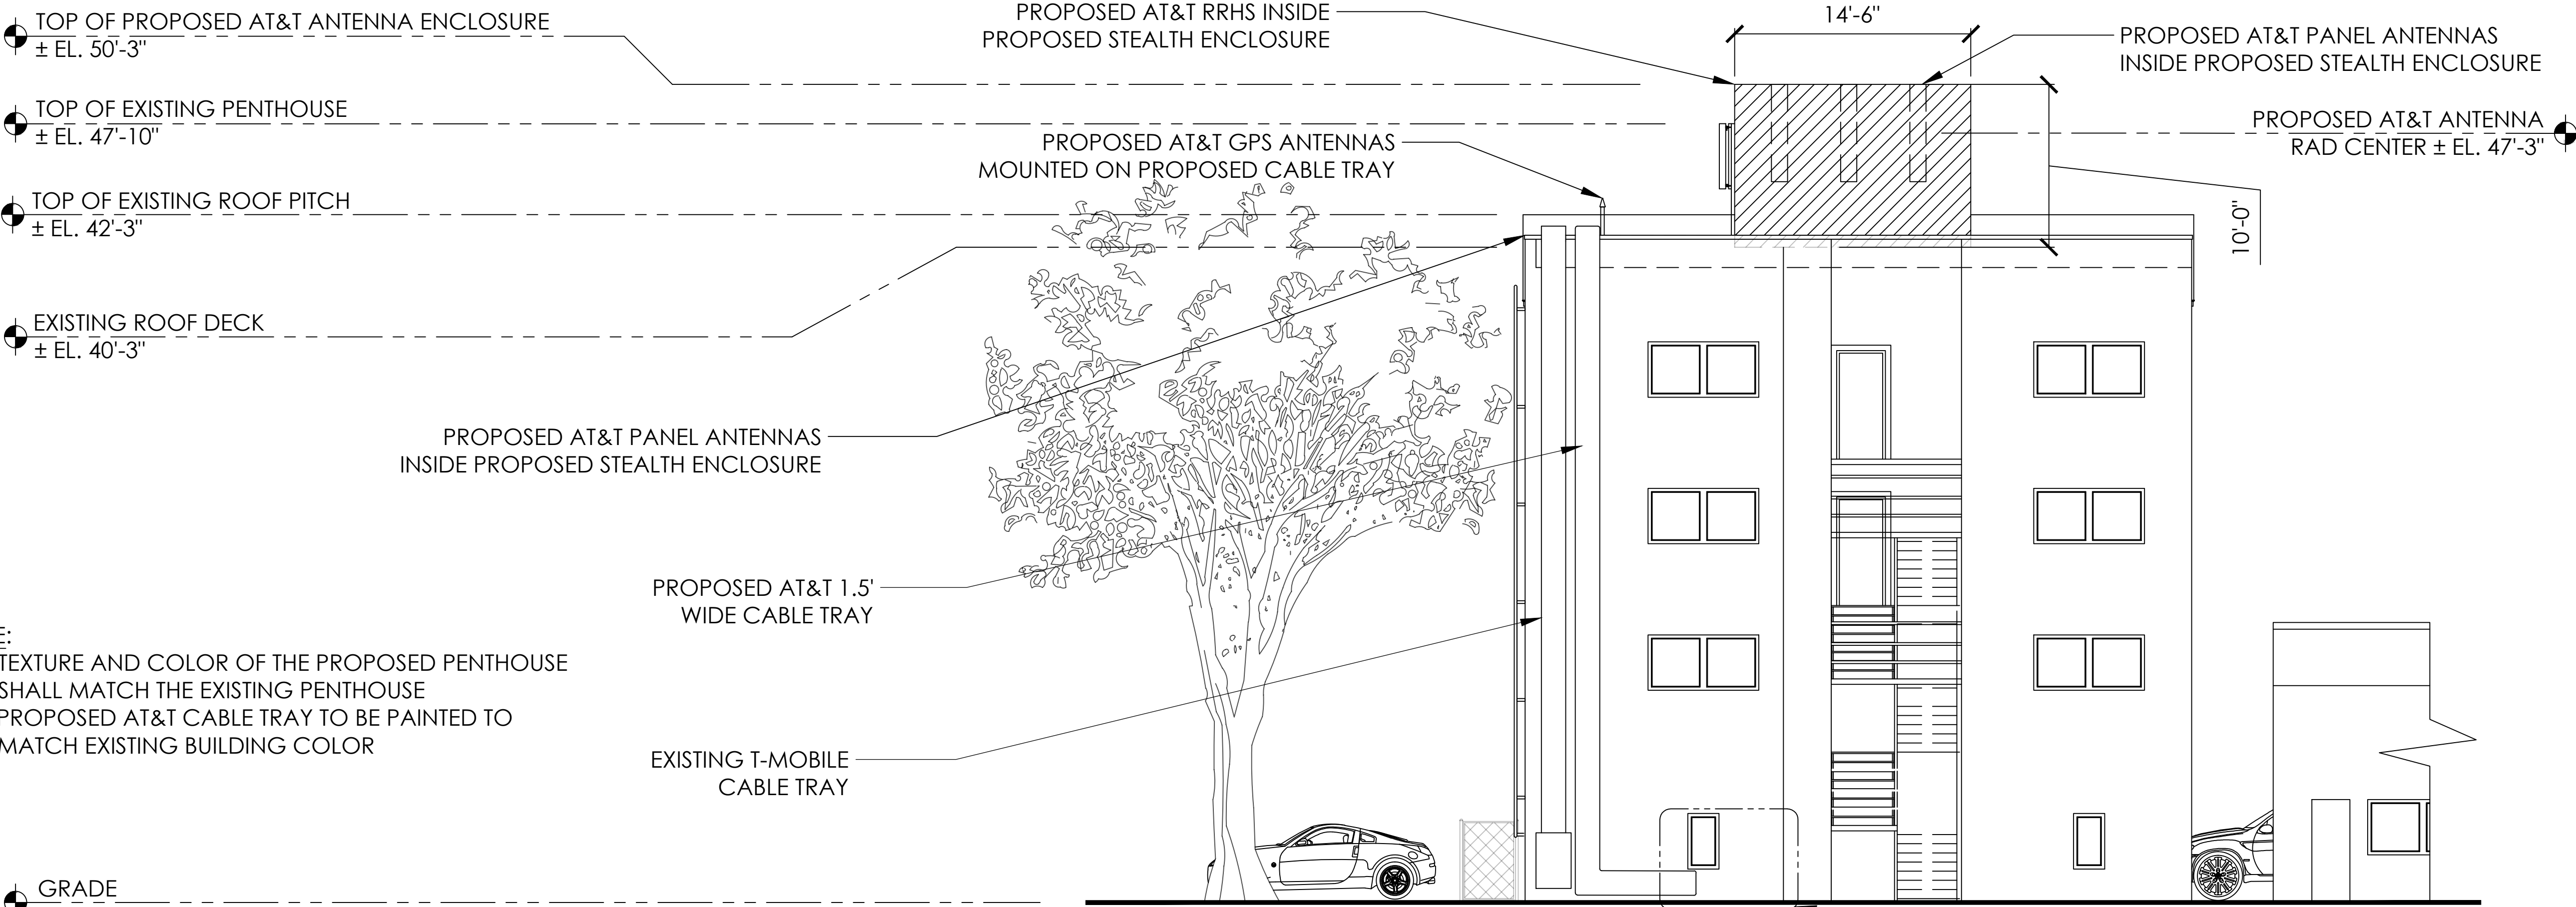

NOTE:  
1. TEXTURE AND COLOR OF THE PROPOSED PENTHOUSE SHALL MATCH THE EXISTING PENTHOUSE  
2. PROPOSED AT&T CABLE TRAY TO BE PAINTED TO MATCH EXISTING BUILDING COLOR

PROPOSED WEST ELEVATION VIEW  
3/16" = 1'-0"

PREPARED FOR

5001 Executive Parkway  
San Ramon, California 94583

Vendor:

14621 Arroyo Honda  
San Diego, CA 92127

AT&T Site ID:

CCU3085

AT&T SITE NO: CCU3085  
PROJECT CODE: -----  
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1	11/26/14	ZD 100%
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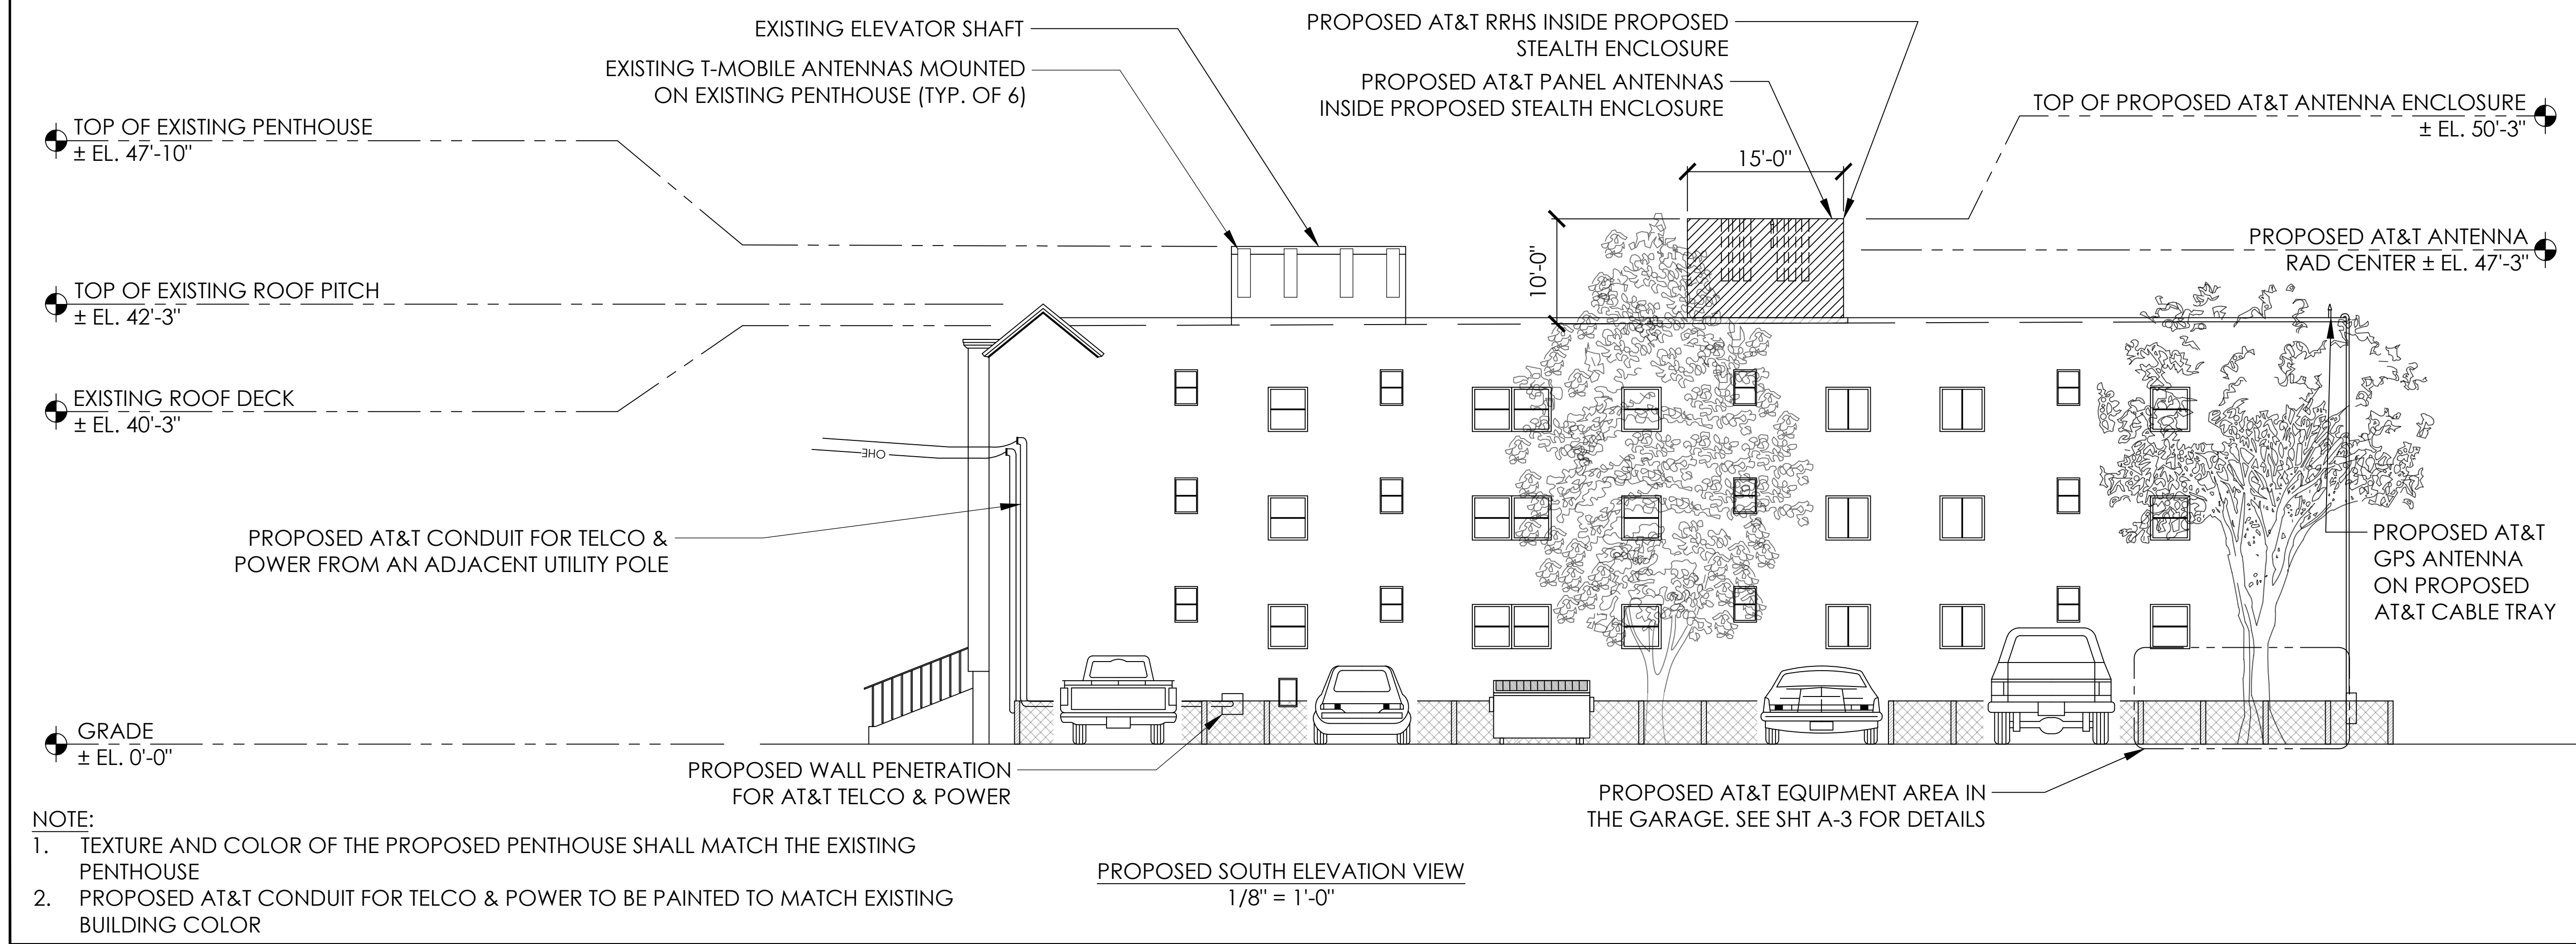
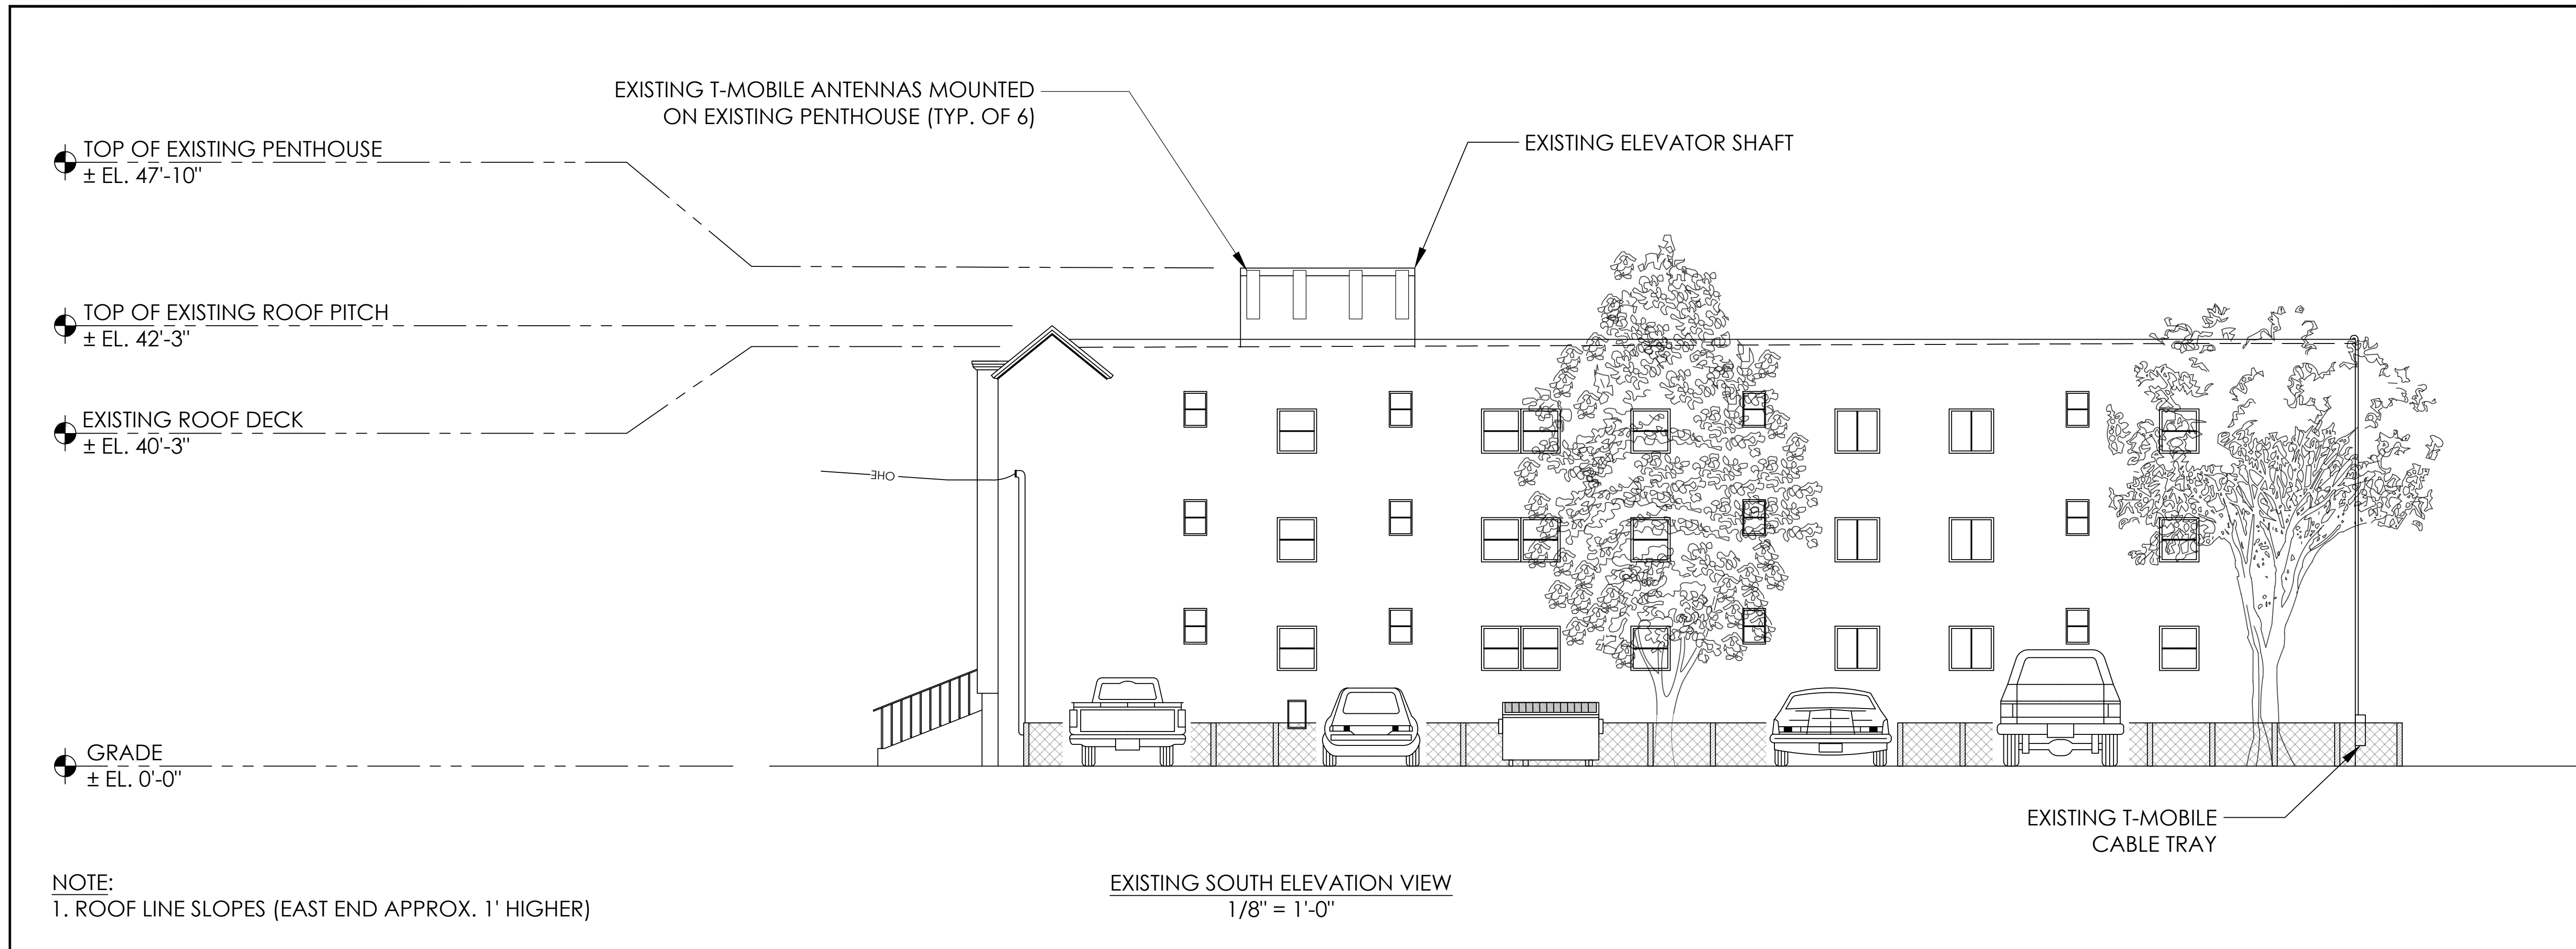
SHEET TITLE:

EXISTING & PROPOSED WEST ELEVATION VIEW


SHEET NUMBER:

**A-5**





PREPARED FOR



5001 Executive Parkway  
San Ramon, California 94583

Vendor:



14621 Arroyo Honda  
San Diego, CA 92127

AT&T Site ID:

CCU3085

AT&T SITE NO: CCU3085

PROJECT CODE: -----

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ALAMEDA COUNTY

SHEET TITLE:

EXISTING & PROPOSED  
SOUTH ELEVATION VIEW


SHEET NUMBER:

**A-6**





EXISTING EAST ELEVATION VIEW  
3/16" = 1'-0"

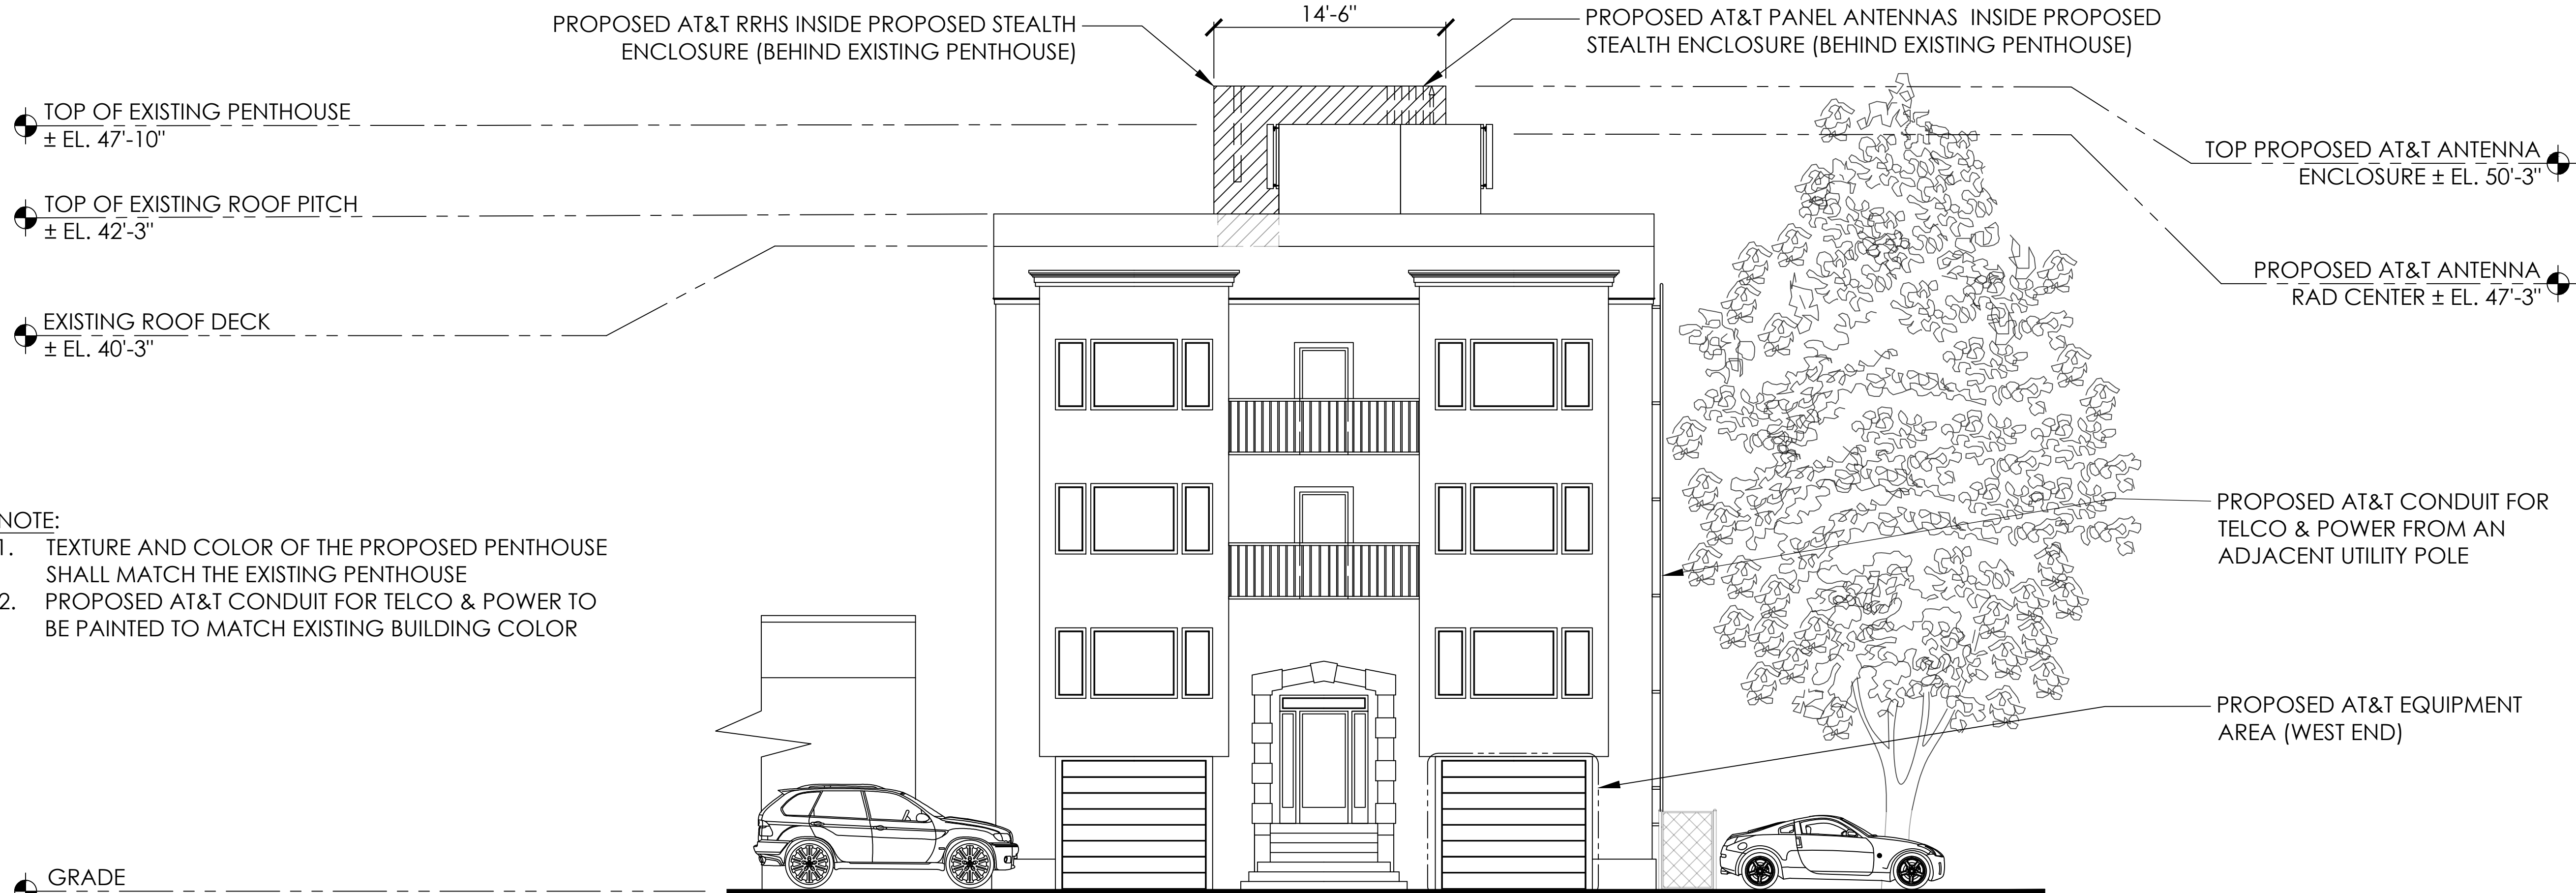

- NOTE:
1. TEXTURE AND COLOR OF THE PROPOSED PENTHOUSE SHALL MATCH THE EXISTING PENTHOUSE
  2. PROPOSED AT&T CONDUIT FOR TELCO & POWER TO BE PAINTED TO MATCH EXISTING BUILDING COLOR

PROPOSED EAST ELEVATION VIEW  
3/16" = 1'-0"

PREPARED FOR

5001 Executive Parkway  
San Ramon, California 94583

Vendor:

14621 Arroyo Honda  
San Diego, CA 92127

AT&T Site ID:

CCU3085

AT&T SITE NO: CCU3085

PROJECT CODE: -----

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SHEET TITLE:

EXISTING & PROPOSED EAST ELEVATION VIEW

SHEET NUMBER:

**A-7**



INFORMATION

AT&T Mobility operates telecommunications antennas at this location. Remain at least 3 feet away from any antenna and obey all posted signs.

Contact the owner(s) of the antenna(s) before working closer than 3 feet from the antenna.

Contact AT&T Mobility at 800-638-2822 prior to performing any maintenance or repairs near AT&T antennas.

This is AT&T Mobility Site # \_\_\_\_\_

Contact the management office if this door/hatch/gate is found unlocked.

INFORMACIÓN

En esta propiedad se ubican antenas de telecomunicaciones operadas por AT&T Mobility. Favor mantener una distancia de no menos de 3 pies y obedecer todos los avisos.

Comuníquese con el propietario o los propietarios de las antenas antes de trabajar o caminar a una distancia de menos de 3 pies de la antena.

Comuníquese con AT&T Mobility 800-638-2822 antes de realizar cualquier mantenimiento o reparaciones cerca de las antenas de AT&T.

Esta es la estación base número \_\_\_\_\_

Favor comunicarse con la oficina de la administración del edificio si esta puerta o compuerta se encuentra sin candado.

Sign 1www.radiataz.comAT&T Mobility


A INFORMATION SIGN 1  
SCALE: 1/2" = 1'

CAUTION

Beyond This Point you are entering a controlled area where RF Emissions may exceed the FCC Occupational Exposure Limits

Obey all posted signs and site

B CAUTION SIGN  
SCALE: 3/4" = 1'

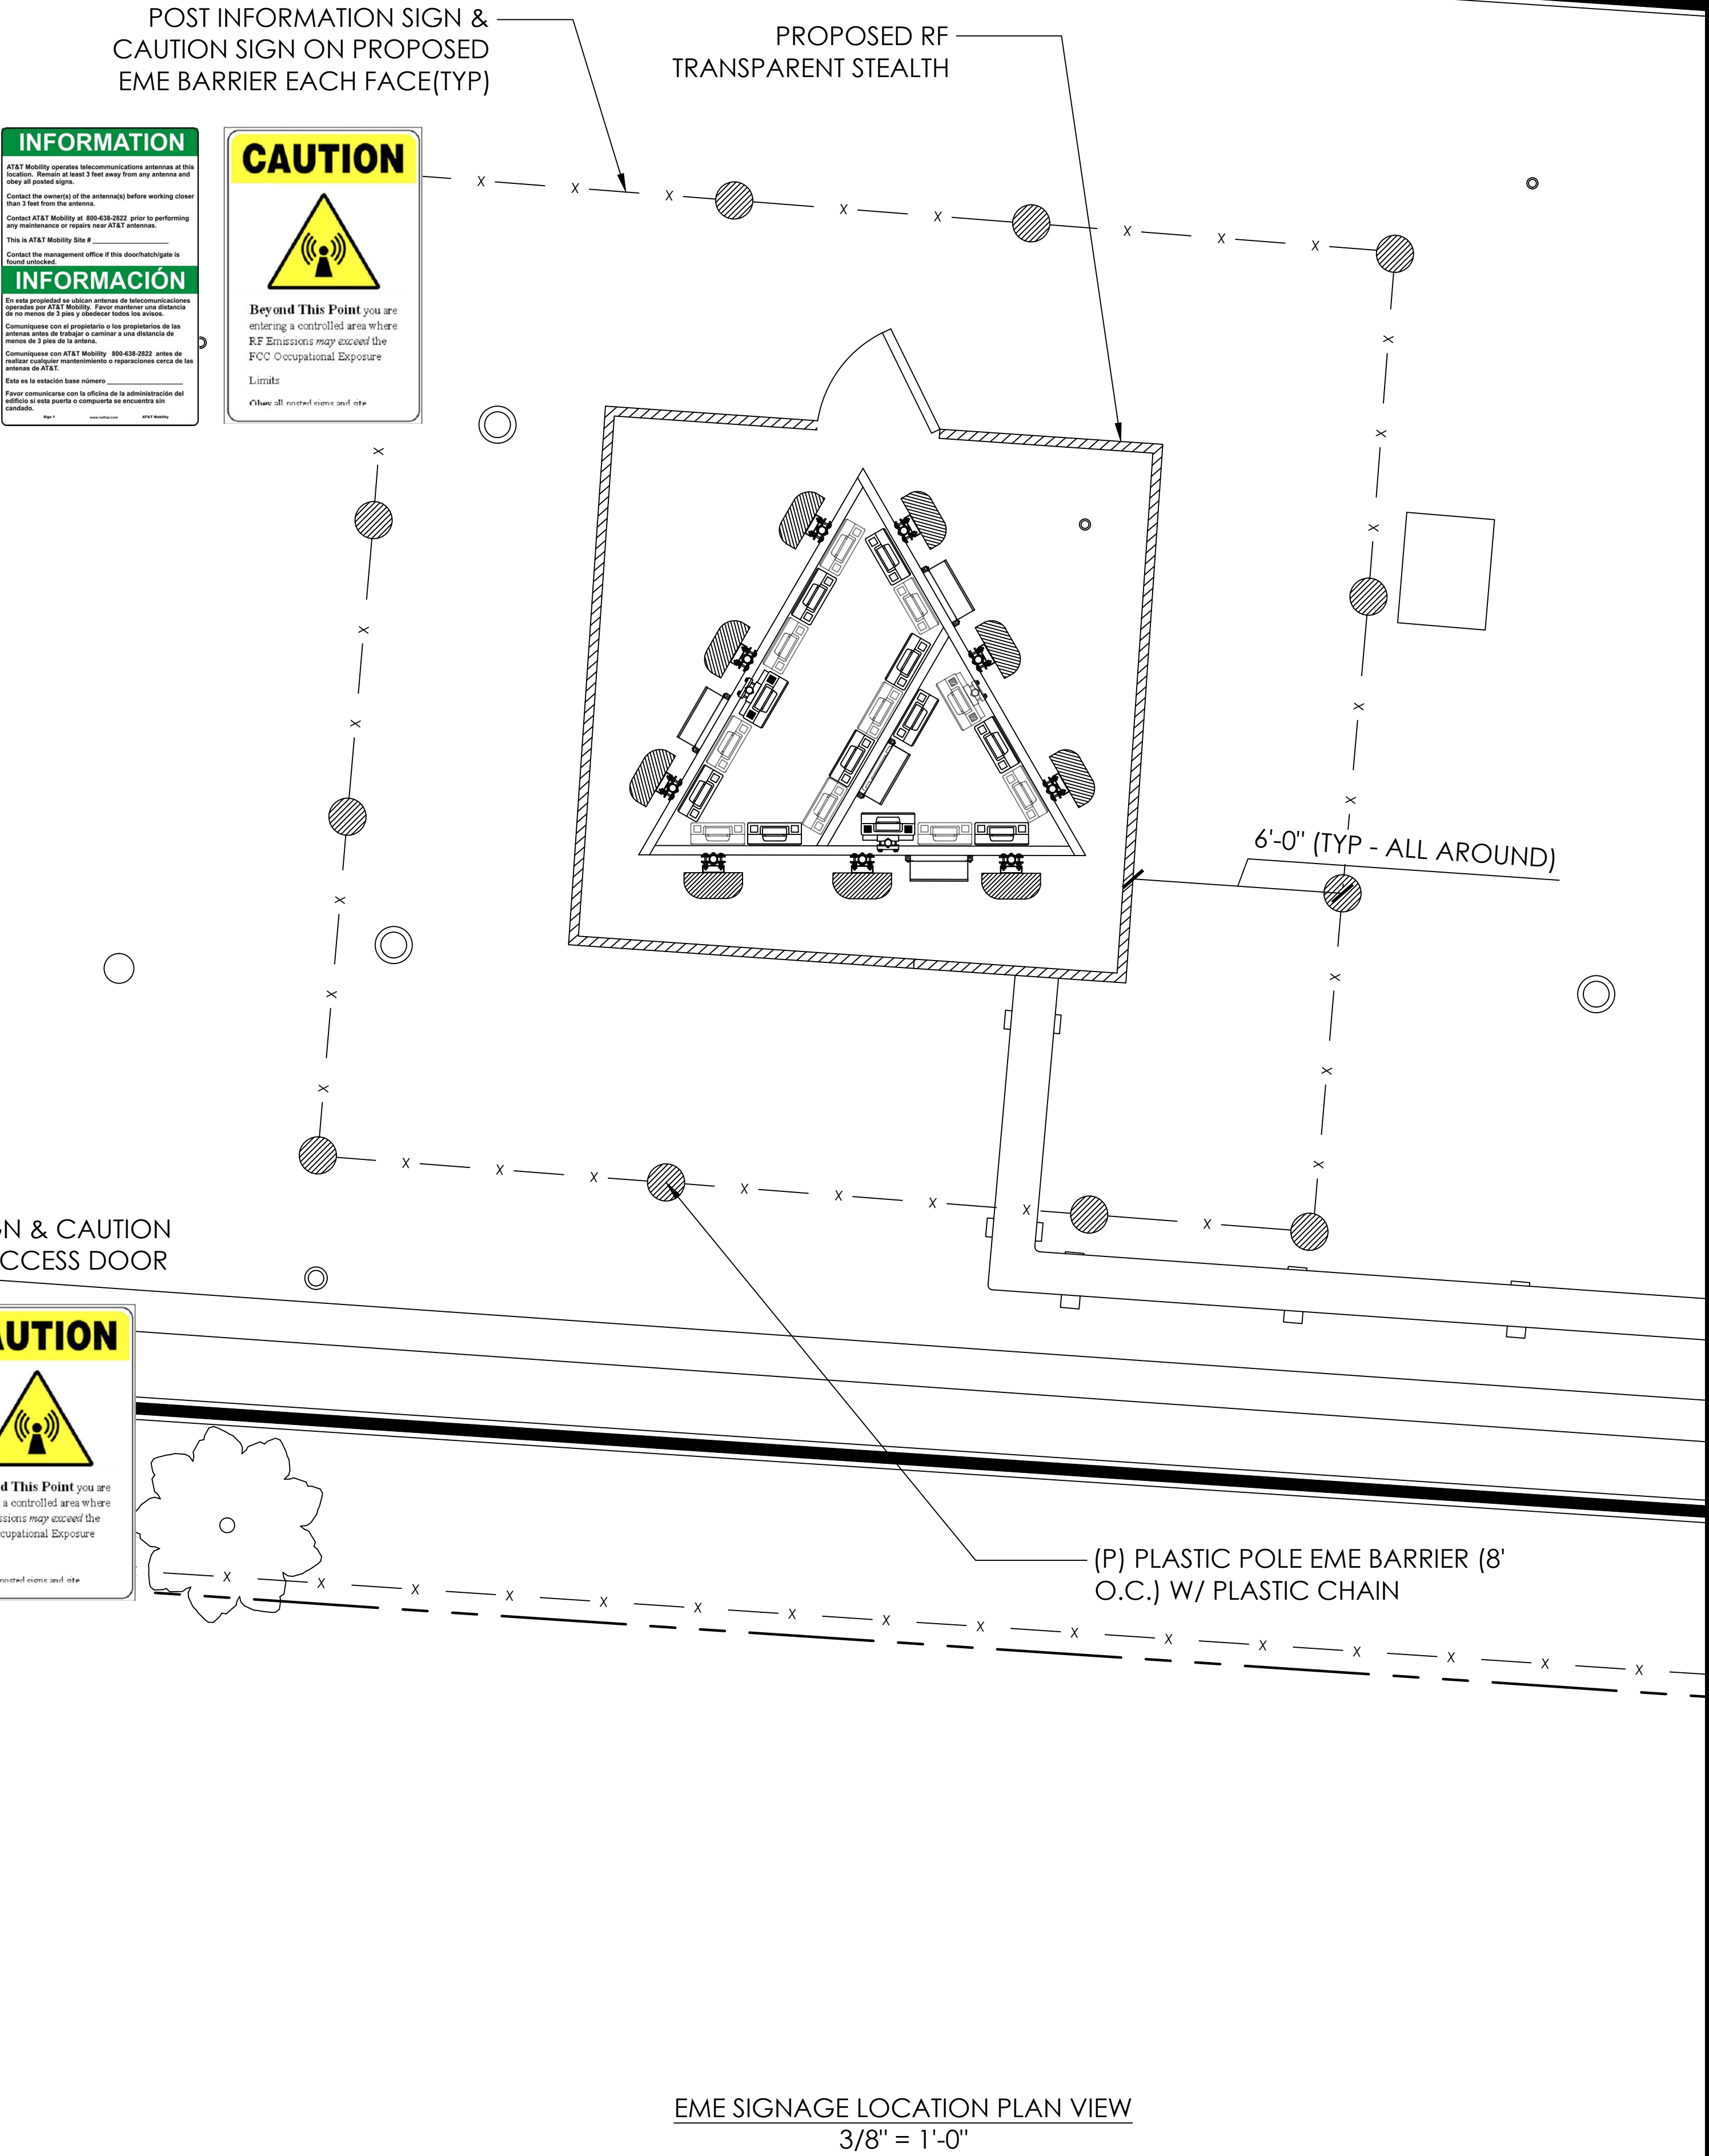

POST INFORMATION SIGN & CAUTION SIGN ON PENTHOUSE ACCESS DOOR

INFORMATION

AT&T Mobility operates telecommunications antennas at this location. Remain at least 3 feet away from any antenna and obey all posted signs.

Contact the owner(s) of the antenna(s) before working closer than 3 feet from the antenna.

Contact AT&T Mobility at 800-638-2822 prior to performing any maintenance or repairs near AT&T antennas.

This is AT&T Mobility Site # \_\_\_\_\_

Contact the management office if this door/hatch/gate is found unlocked.

INFORMACIÓN

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Comuníquese con el propietario o los propietarios de las antenas antes de trabajar o caminar a una distancia de menos de 3 pies de la antena.

Comuníquese con AT&T Mobility 800-638-2822 antes de realizar cualquier mantenimiento o reparaciones cerca de las antenas de AT&T.

Esta es la estación base número \_\_\_\_\_


Favor comunicarse con la oficina de la administración del edificio si esta puerta o compuerta se encuentra sin candado.

Sign 1www.radiataz.comAT&T Mobility

CAUTION

Beyond This Point you are entering a controlled area where RF Emissions may exceed the FCC Occupational Exposure Limits

Obey all posted signs and site

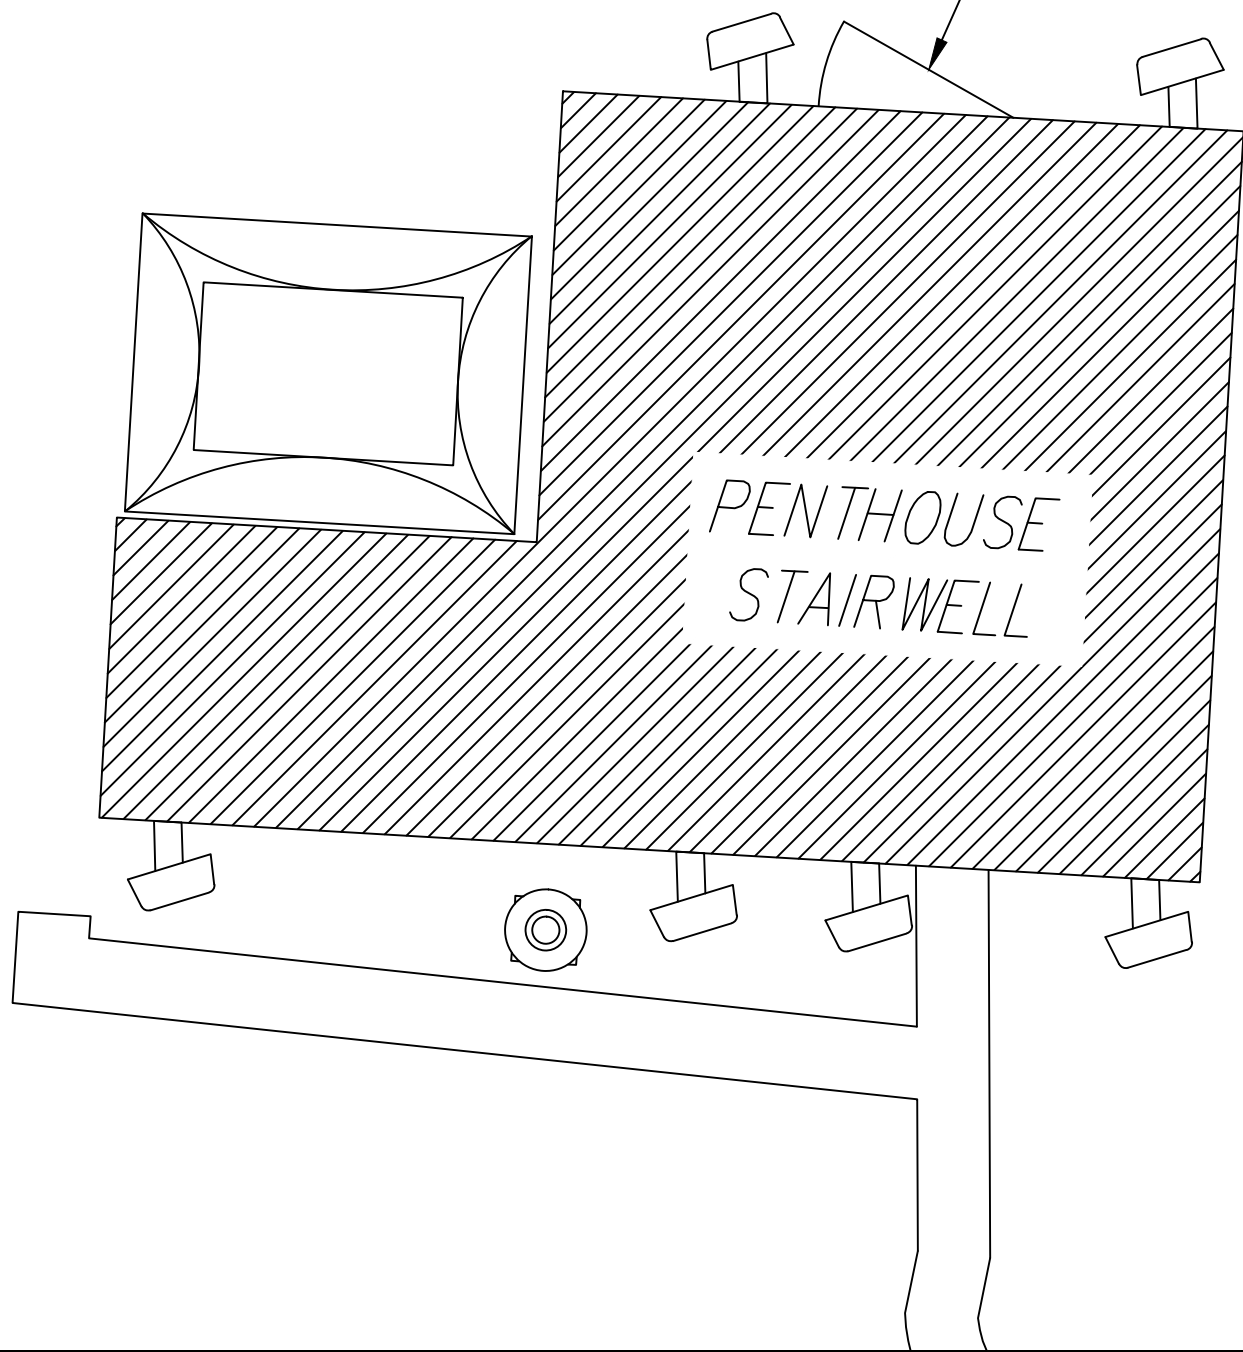

PREPARED FOR

 at&t Mobility

5001 Executive Parkway  
San Ramon, California 94583

Vendor:

 Cortel

14621 Arroyo Hondo  
San Diego, CA 92127

AT&T Site ID:

CCU3085

AT&T SITE NO: CCU3085

PROJECT CODE: -----

DRAWN BY: SO

CHECKED BY: JF

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ALAMEDA COUNTY

SHEET TITLE:

EME SIGNAGE LOCATION PLAN VIEW

SHEET NUMBER:

**A-8**