ABBREVIATIONS

1		1	LONG
L	ANGLE	L	LONG MAXIMUM
@ C		MAX MECH	MECHANICAL
Ģ ø	CENTERLINE DIAMETER	MECH	MANUFACTURER
P PL	PROPERTY LINE	MIN	MINIMUM
ABV	ABOVE	MTL	METAL
ADD'L	ADDITIONAL	(N)	NEW
ADJ	ADJUSTABLE	N.A.	NOT APPLICABLE
A.F.F.	ABOVE FINISH FLOOR	N.I.C.	NOT IN CONTRACT
ALLOW	ALLOWABLE	NO	NUMBER
ALT	ALTERNATE	N.T.S.	NOT TO SCALE
ALUM	ALLUMINUM	OC	ON CENTER
AWN	AWNING	OPG	OPENING
BD	BOARD	OPP	OPPOSITE
BEL	BELOW	PC	PIECE
B.F.F.	BELOW FINISH FLOOR	PERF	PERFORATED PERPENDICULAR
BLDG	BUILDING	PERP	PERPENDICULAR PLATE
BLKG BOT	BLOCKING BOTTOM	PL PLMG	
B.O.	BOTTOM	PENG	PAIR
BTW	BETWEEN	PRS	PAIRS
СН	CEILING HEIGHT	P.T.	PRESSURE TREATED
CAB	CABINET	PTD	PAINTED
CL	CLOSET	PWD	PLYWOOD
CLG	CEILING	(R)	RELOCATED
COL	COLUMN	R	RISER
CONC	CONCRETE	R&S	ROD & SHELF
CONT	CONTINUOUS	R.O.	ROUGH OPENING
CLR	CLEAR	RAD	RADIUS
CSMT	CASEMENT	REF	REFERENCE
CVR	COVER	REFR	REFRIGERATOR
d	PENNY	REM'D	REMOVED
D	DEEP	REQ'D	REQUIRED RETAINING
DBL DET		RET'G S.A.D.	SEE ARCHITECTURAL DRAWINGS
DET D.H.	DETAIL DOUBLE HUNG	S.A.D. SCH	SCHEDULE
DIA	DIAMETER	S.E.D.	SEE ELECTRICAL DRAWINGS
DIAG	DIAGONAL	SF	SQUARE FEET
DIM	DIMENSION	SHLV	SHELF
DN	DOWN	SHR	SHOWER
DS	DOWNSPOUT	SHT	SHEET
DW	DISHWASHER	SHT MTL	SHEET METAL
(E)	EXISTING	SI	SQUARE INCHES
ELEC	ELECTRICAL	SIM	SIMILAR
ELEV	ELEVATION	S.L.D.	SEE LANDSCAPE DRAWINGS
E.N.	EDGE NAIL	S.M.D.	SEE MECHANICAL DRAWINGS
EQ	EQUAL	SQ	SQUARE
EQ A	EQ. MATCH DIM.W/ SAME LETTER	S.S.	STAINLESS STEEL
EQUIP	EQUIPMENT	S.S.D.	SEE STRUCTURAL DRAWINGS STANDARD
E.S. EXT	EACH SIDE EXTERIOR	STD S.W.	SHEAR WALL
FIN	FINISH	5.vv. T	TREAD
FLR	FLOOR	т&В	TOP & BOTTOM
FLR'G	FLOORING	T&G	TONGUE & GROOVE
FNDN	FOUNDATION	T.B.	TOWEL BAR
FT	FEET	Т.О.	TOP OF
FTG	FOOTING	тот	TOTAL
GAL	GALLON	T.P.	TOILET PAPER
GALV	GALVANIZED	TYP	TYPICAL
G.B.	GRAB BAR	UNFIN	UNFINISHED
GYP	GYPSUM	U.O.N.	UNLESS OTHERWISE NOTED
Н	HIGH	VERT	VERTICAL
H.B.	HOSE BIBB	V.I.F.	
HD	HOLDDOWN	W	WIDE
HDWR	HARDWARE	W/	
HORZ	HORIZONTAL	W/D	WASHER/DRYER
HR	HOUR	WD	WOOD WATER HEATER
HT H W		WH	WATER HEATER WHERE OCCURS
H.W. IN	WATER HEATER INCHES	W.O. WP	WATERPROOF
IN	INCHES	WP W.W.F.	WELDED WIRE FABRIC

SYMBOLS

SIMP	JLS				
	REVISION			Ē	DUPLEX OUTLET QUAD OUTLET
	(E) WALL TO REMAIN			₩	
	(E) WALL TO BE REMOVED	₩₽			
	ABOVE OR BELOW				INTERRUPT OUTLET, waterproof GROUND
	(N) WALL			Ē	FAULT INTERRUPT OUTLET APPLIANCE DEDICATED OUTLET
****	(N) 1 HR. RATED WALL			 	WATER MAIN
	DETAIL KEY			—— НВ	HOSE BIBB
	SECTION KEY			—— G	GAS LINE
4 1 2	INTERIOR ELEVATION KEY		Y _{pf}		TELEPHONE, CABLE, DSL
3 (1)	WINDOW & EXTERIOR DOOR KEY			Ţ	THERMOSTAT
A	INTERIOR DOOR KEY			(N)	NEW
	CEILING LIGHT			(E)	EXISTING
⊢∳-	WALL SCONCE			(R)	RELOCATE
×	UNDER CABINET FLUORESCENT LIG	HT			EXHAUST, RETURN OR OUTSIDE
-¢ _A	LOW VOLTAGE LIGHT				
SD	SMOKE DETECTOR				SUPPLY DUCT-SECTION FLOOR REGISTER
CM	CARBON MONOXIDE DETECTOR				WALL REGISTER
••	FAN OR FAN/LIGHT				BASEBOARD REGISTER
\$ \$ _D \$ ₃	SWITCH, DIMMER SWITCH, 3-WAY S	WITCH			BATH CEILING FAN
<u> </u>	SWITCHES: OCCUPANCY SENSOR,	MOTION	I SENSOF	, PHOTOC	ONTROL

GENERAL NOTES

- SITE, THE WORK, OR THE PROSECUTION OF THE WORK.
- OBSERVED BY CONTRACTOR.
- PRIOR WORK.

- CONNECTION WITH THIS WORK.
- THROUGHOUT, UNLESS OTHERWISE NOTED. REFERENCED AT EACH LOCATION.
- MOUNTED ACCESSORIES AS REQUIRED.
- MANUFACTURER'S INSTRUCTIONS.

- PERFORMED BY ALL SUBCONTRACTORS AS WELL AS THE WORK
- REQUIRED. MATERIALS WHEREVER PRACTICAL.

Exhibit 2 Item 7-A, 9-3-15 **Historical Advisory Board**

PROJECT SCOPE OF WORK AND INFORMATION

1. OWNERSHIP AND USE OF DOCUMENTS: THIS IS AN INSTRUMENT OF PROFESSIONAL SERVICE AND SHALL REMAIN THE PROPERTY OF ALEXANDRA SHEETS SAIKLEY ARCHITECT WHETHER THE PROJECT FOR WHICH IT IS MADE IS EXECUTED OR NOT. NO CHANGES, ALTERATIONS, OR DELETIONS MAY BE MADE HERETO EXCEPT BY THE ARCHITECT AND THIS SHALL NOT BE USED OR REPRODUCED BY ANYONE ON OTHER PROJECTS, FOR ADDITIONS TO THIS PROJECT, OR FOR COMPLETION OF THIS PROJECT BY OTHERS WITHOUT THE EXPRESS WRITTEN CONSENT OF ALEXANDRA SHEETS SAIKLEY ARCHITECT. 2. "APPLICABLE CODE REQUIREMENTS" MEANS ALL LAWS, STATUTES, THE MOST RECENT BUILDING CODES, ORDINANCES, RULES, REGULATIONS, AND LAWFUL ORDER OF ALL PUBLIC AUTHORITIES HAVING JURISDICTION OVER OWNER, CONTRACTOR, ANY SUBCONTRACTOR, THE PROJECT, THE PROJECT

3. ALL WORK AND MATERIALS SHALL BE IN FULL CONFORMANCE WITH APPLICABLE CODE REQUIREMENTS, INCLUDING THEIR MOST RECENT REVISIONS, ADDITIONS, AMENDMENTS, AND INTERPRETATIONS. IN THE EVENT OF CONFLICT, THE MOST STRINGENT REQUIREMENTS SHALL APPLY. 4. CONTRACTOR SHALL CAREFULLY STUDY AND COMPARE EACH OF THE CONTRACT DOCUMENTS WITH THE OTHERS AND WITH INFORMATION FURNISHED BY THE OWNER, AND SHALL PROMPTLY REPORT IN WRITING TO OWNER ANY ERRORS, INCONSISTENCIES, OR OMISSIONS IN THE CONTRACT DOCUMENTS OR INCONSISTENCIES WITH APPLICABLE CODE REQUIREMENTS

5. CONTRACTOR SHALL REVIEW AND VERIFY ALL EXISTING CONDITIONS, VERIFY FIELD CONDITIONS, TAKE FIELD MEASUREMENTS, AND CAREFULLY COMPARE WITH THE CONTRACT DOCUMENTS SUCH CONDITIONS, FIELD MEASUREMENTS, AND OTHER INFORMATION KNOWN TO CONTRACTOR BEFORE COMMENCING THE WORK. ERRORS, INCONSISTENCIES, OR

OMISSIONS DISCOVERED AT ANY TIME SHALL BE PROMPTLY REPORTED IN WRITING TO THE OWNER AND ARCHITECT. DO NOT PROCEED WITH AFFECTED WORK UNTIL THE VARIATION, DISCREPANCY, AND CONFLICT ARE RESOLVED WITH THE OWNER AND ARCHITECT. 6. IF CONTRACTOR PERFORMS ANY CONSTRUCTION ACTIVITY WHICH IT KNOWS

OR SHOULD KNOW INVOLVES AN ERROR, INCONSISTENCY, OR OMISSION REFERRED TO GENERAL NOTES 4 AND 5 ABOVE, WITHOUT NOTIFYING AND OBTAINING THE WRITTEN CONSENT OF OWNER, CONTRACTOR SHALL BE RESPONSIBLE FOR THE RESULTANT LOSSES, INCLUDING, WITHOUT LIMITATION, THE COSTS OF CORRECTING DEFECTIVE WORK.

7. CONTRACTOR IS RESPONSIBLE TO VERIFY ALL DIMENSIONS AND INSPECT CONDITIONS OF PRIOR WORK OF THE OTHER TRADES BEFORE STARTING WORK. PROCEEDING WITH THE WORK SHALL CONSTITUTE ACCEPTANCE OF

8. THE EXISTENCE AND LOCATIONS OF UNDERGROUND UTILITIES INDICATED ON THE DRAWINGS ARE NOT GUARANTEED AND SHALL BE INVESTIGATED AND FIELD VERIFIED BY THE CONTRACTOR BEFORE BEGINNING ANY WORK. 9. CONTRACTOR SHALL DETERMINE THE LOCATION OF ALL UTILITY SERVICES NECESSARY TO THE EXECUTION AND COMPLETION OF INDICATED WORK PRIOR TO ITS COMMENCEMENT. CONTRACTOR SHALL BE RESPONSIBLE FOR THE APPROPRIATE "HOOK-UP" TO ALL UTILITIES NECESSARY TO THE EXECUTION AND SUPPORT OF THE COMPLETED WORK.

10. ALL EXISTING CONSTRUCTION AND LANDSCAPE FEATURES THAT ARE TO REMAIN AS PART OF THE PROJECT SHALL BE PROTECTED FROM DAMAGE THROUGHOUT THE PERIOD OF CONSTRUCTION WORK. ANY DAMAGED CONSTRUCTION OR FEATURES SHALL BE REPLACED AT THE EXPENSE OF THE CONTRACTOR TO THE SATISFACTION OF THE ARCHITECT WITH MATERIALS EQUIVALENT OR SUPERIOR TO THE ORIGINAL ITEM(S). 11 EXECUTE DEMOLITION WORK TO ENSURE THE SAFETY OF PERSONS AND

ADJACENT PROPERTY FROM DAMAGE DUE TO VIBRATION. SETTLEMENT. FALLING DEBRIS, UNSTABLE STRUCTURE, OR OTHER CAUSES IN

12. DETAILS ARE USUALLY KEYED AND NOTED "TYPICAL" ONLY ONCE, WHEN THEY FIRST OCCUR, AND ARE REPRESENTATIVE OF SIMILAR CONDITIONS 13. DETAILS SHOWN ON DRAWINGS SHALL BE INCORPORATED INTO THE

PROJECT AT ALL APPROPRIATE LOCATIONS WHETHER OR NOT SPECIFICALLY

14. ALL ITEMS NOT INDICATED AS (E) OR EXISTING ARE NEW. 15. PROVIDE BLOCKING AT PARTITIONS, CEILINGS, AND WALLS FOR ALL

16. ALL MATERIALS AND EQUIPMENT SHALL BE INSTALLED PER

17. ALL SUPPORTS, ANCHOR CLIPS, FASTENERS, BRACES, BACKING PLATES, REINFORCEMENTS FOR ALL ASSEMBLIES, SYSTEMS, FIXED EQUIPMENT, ACCESSORIES, AND SO FORTH (THAT ARE NOT PART OF THE STRUCTURAL SYSTEM) WHICH HAVE BEEN SHOWN, SPECIFIED, OR SIZED SHALL BE THE RESPONSIBILITY OF THE CONTRACTOR TO PROVIDE ALL SUCH ITEMS AS ARE REQUIRED TO COMPLETE THE WORK IN CONFORMANCE WITH ALL APPLICABLE CODE REQUIREMENTS AND DESIGN INTENT. CONTRACTOR

SHALL ALSO PROVIDE ENGINEERING CALCULATIONS FOR ALL SUCH ITEMS AS REQUIRED BY THE AUTHORITY HAVING JURISDICTION. 18. CONTRACTOR SHALL SUPERVISE, COORDINATE, AND DIRECT THE WORK USING CONTRACTOR'S BEST SKILL AND ATTENTION. CONTRACTOR SHALL BE

SOLELY RESPONSIBLE FOR AND HAVE CONTROL OVER CONSTRUCTION MEANS, METHODS, TECHNIQUES, SEQUENCES, PROCEDURES, AND THE COORDINATION OF ALL PORTIONS OF THE WORK.

19. CONTRACTOR ASSUMES SOLE AND COMPLETE RESPONSIBILITY FOR JOB SITE SAFETY CONDITIONS DURING THE ENTIRE COURSE OF CONSTRUCTION, INCLUDING SAFETY OF ALL PERSONS AND PROPERTY; THAT THIS

REQUIREMENT SHALL APPLY CONTINUOUSLY AND NOT BE LIMITED TO NORMAL WORKING HOURS; AND THAT CONTRACTOR SHALL DEFEND, INDEMNIFY, AND HOLD THE OWNER AND THE ARCHITECT HARMLESS FROM ANY AND ALL LIABILITY, REAL, OR ALLEGED, IN CONNECTION WITH THE PERFORMANCE OF THE WORK ON THIS PROJECT, EXCEPT FOR LIABILITY ARISING FROM THE SOLE NEGLIGENCE OF THE OWNER OR THE ARCHITECT. 20.MATERIAL AND WORKMANSHIP WARRANTY: CONTRACTOR SHALL REPLACE ANY DEFECTIVE MATERIALS AND CORRECT POOR WORKMANSHIP WITH NO ADDITIONAL COST TO THE OWNER. CONTRACTOR SHALL REMEDY ANY DEFECTS IN MATERIAL OR WORKMANSHIP WHICH APPEAR WITHIN ONE YEAR FROM THE DATE OF COMPLETION. THIS WARRANTY APPLIES TO WORK

PERFORMED BY THE EMPLOYEES OF THE CONTRACTOR. 21.CONTRACTOR RESPONSIBLE FOR OBTAINING EARTHWORK (GRADING / EXCAVATION), ELECTRICAL, PLUMBING, AND MECHANICAL PERMITS AS

22.ALL CONSTRUCTION WASTE NEEDS TO MEET LOCAL CONSTRUCTION WASTE MANAGEMENT (CONSTRUCTION AND DEMOLITION DEBRIS WASTE REDUCTION AND RECYCLING PROGRAM) REQUIREMENTS. CONTRACTOR TO DISPOSE OF ALL WASTE PER CITY REQUIREMENTS. SALVAGE AND RECYCLE

PROJECT SCOPE:

- REBUILD FRONT PORCH IN-KIND
- REMODEL FIRST STORY
- REPLACE ALL WINDOWS - ADD SECOND STORY

APN: 71-282-18

NUMBER OF STORIES: 1

TYPE OF CONSTRUCTION: V-B

ZONING: R-3

OCCUPANCY: SINGLE-FAMILY RESIDENTIAL

BUILDING HEIGHT: 13'-10" +/- EXISTING, 23'-0" +/- PROPOSED

LOT SIZE: 40' x 56' = 2,240 SF

HOUSE SQUARE FOOTAGE:	EXISTING	PROPOSED
GARAGE (NON-HABITABLE)	192 SF	192 SF
FIRST FLOOR (HABITABLE) SECOND FLOOR (HABITABLE) TOTAL BUILDING (HABITABLE)	505 SF - 764 SF	530 SF <u>300 SF</u> 1,278 SF
LOT COVERAGE:	956 SF = 43%	956 SF = 43%

BUILDING CODE:

2013 CALIFORNIA RESIDENTIAL, ENERGY, MECHANICAL, ELECTRICAL, PLUMBING AND FIRE CODES

EXISTING SITE PHOTOS



PLAN NOTES

- 1. PLAN DIMENSIONING: DIMENSIONS ARE TO (IN ORDER OF PRIORITY): - FACE OF STUD (INTERIOR WALLS)
- CENTERLINE OF GRID
- FACE OF CONCRETE - EDGE OF SLAB
- DOORS AND WINDOWS ARE DIMENSIONED TO CENTERLINES OR FACE OF JAMB, U.O.N.
- 2. WRITTEN DIMENSIONS TAKE PRECEDENCE. DO NOT SCALE DRAWINGS.
- 3. DIMENSIONS NOTED V.I.F. SHALL BE CHECKED AND CONFIRMED BY THE CONTRACTOR PRIC TO CONSTRUCTION. REPORT ANY VARIANCES, OR DISCREPANCIES TO THE ARCHITECT FOR RESOLUTION BEFORE PROCEEDING. SEE GENERAL NOTES 5,6,7.

	SHEET INDEX	DESIGN REVIEW AS
	 A0.1 COVER SHEET: GENERAL AND PROJECT INFORMATION AND NOTES A0.2 SITE PHOTOGRAPHS A1.1 EXISTING/DEMO SITE AND ROOF PLAN A1.2 PROPOSED SITE AND ROOF PLAN A2.1 EXISTING/DEMO FLOOR PLANS A2.2 PROPOSED FLOOR PLANS A4.1 EXISTING/DEMO BUILDING ELEVATIONS A4.2 PROPOSED BUILDING ELEVATIONS A9.1 WINDOW SCHEDULE 	SUBMITTAL 03/27/15 DESIGN REVIEW RESUBMITTAL 07/06/15 AS
	PROJECT DIRECTORY	ARCHITECT ARCHITECTS SAIKLEY ARCHITECTS 5464-C COLLEGE AVENUE 04KLAND, CA 94618 (510) 420-1234 as@asarch.org www.asarch.org
	CLIENT: TITLE 24 CONSULTANT: MEREDITH AND KEN LEVINS CHRIS FERRE 1732 UNION STREET TRUCKEE, CA 96161 ALAMEDA, CA 94501 (800) 550-0818 ph (925) 980-8811 (530) 550-9485 fax MEREDITHLEVINS@GMAIL.COM CALC24@ATT.NET KLEVINS@GMAIL.COM CALC24@ATT.NET KLEVINS@GMAIL.COM CALC24@ATT.NET MEREDITHLEVINS@GMAIL.COM CALC24@ATT.NET KLEVINS@GMAIL.COM CALC24@ATT.NET KLEVARCHITECTS S464-C COLLEGE AVENUE OAKLAND, CA 94618 (510) 420-1234 ph (877) 880-9739 fax AS@ASARCH.ORG STRUCTURAL CONSULTANT: RAFFERTY RAFFERTY 2842 JACKSON STREET ALAMEDA, CA 94501 (510) 864-2017 ph 510 864-2017 ph 510 864-2018 fax RAFFENG@GMAIL.COM KAFFENG@GMAIL.COM	IJ332 UNION STREETS SAIKLEY ALL RIGHTS RESERVED
DR R	VICINITY MAP	SHEET TITLE: COVER PAGE DATE: JULY 06, 2015 SCALE: JOB NO: 1453 DRAWN BY: KM/HAM AQA1



1734 UNION STREET



1733 UNION STREET

1732 UNION STREET ALAMEDA CA 94501







FRONT



SIDE



1729 UNION STREET, 1731 UNION STREET, 1733 UNION STREET





FRONT





REAR

SIDE




1729 UNION STREET




1727 UNION STREET


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	SAIKLEY ARCHITECTS	5464-C COLLEGE AVENUE OAKLAND, CA 94618	(510) 420-1234 as@asarch org	50.0			
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PROJECT	<u>(r</u>		1732				
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	VGENS VGENS VIIII	ED AR JRA SHEETJ	CHITES SAINE	2			
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OF CALIFORNIE							
SHEET TITLE: SITE PHOTOGRAPHS							
DATE: JULY 06, 2015							
SCALE: JOB NO: 1453							
drawn by: KM/HAM							
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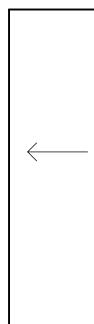
1. SITE DIMENSIONS ARE BASED ON FIELD MEASUREMENTS AND ARE +/-.




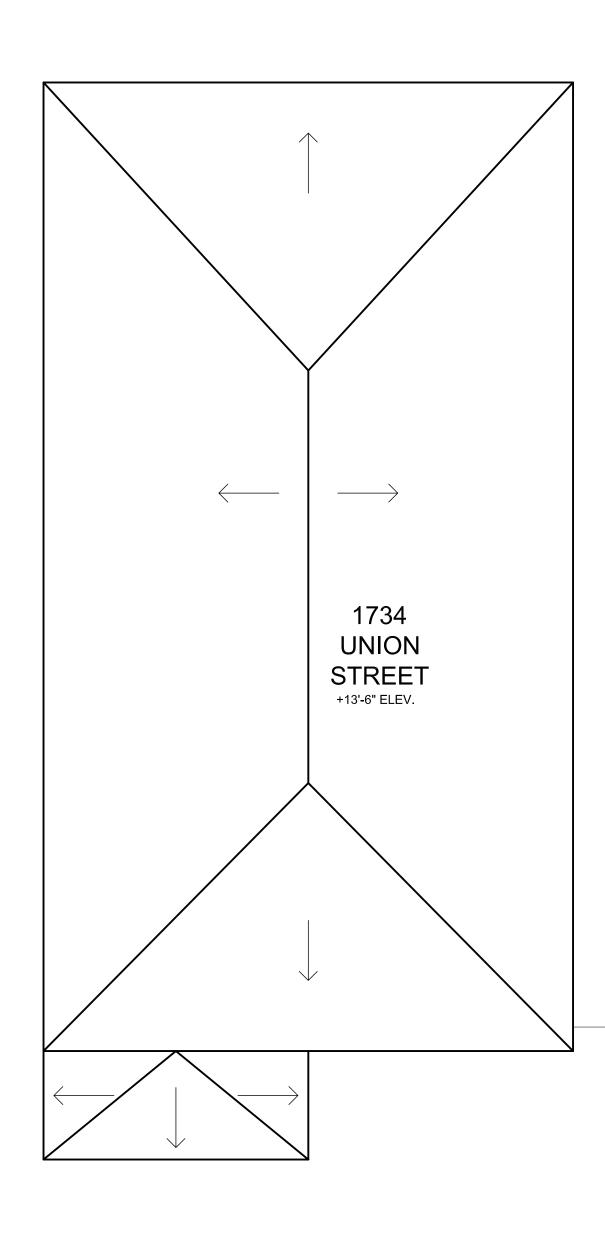

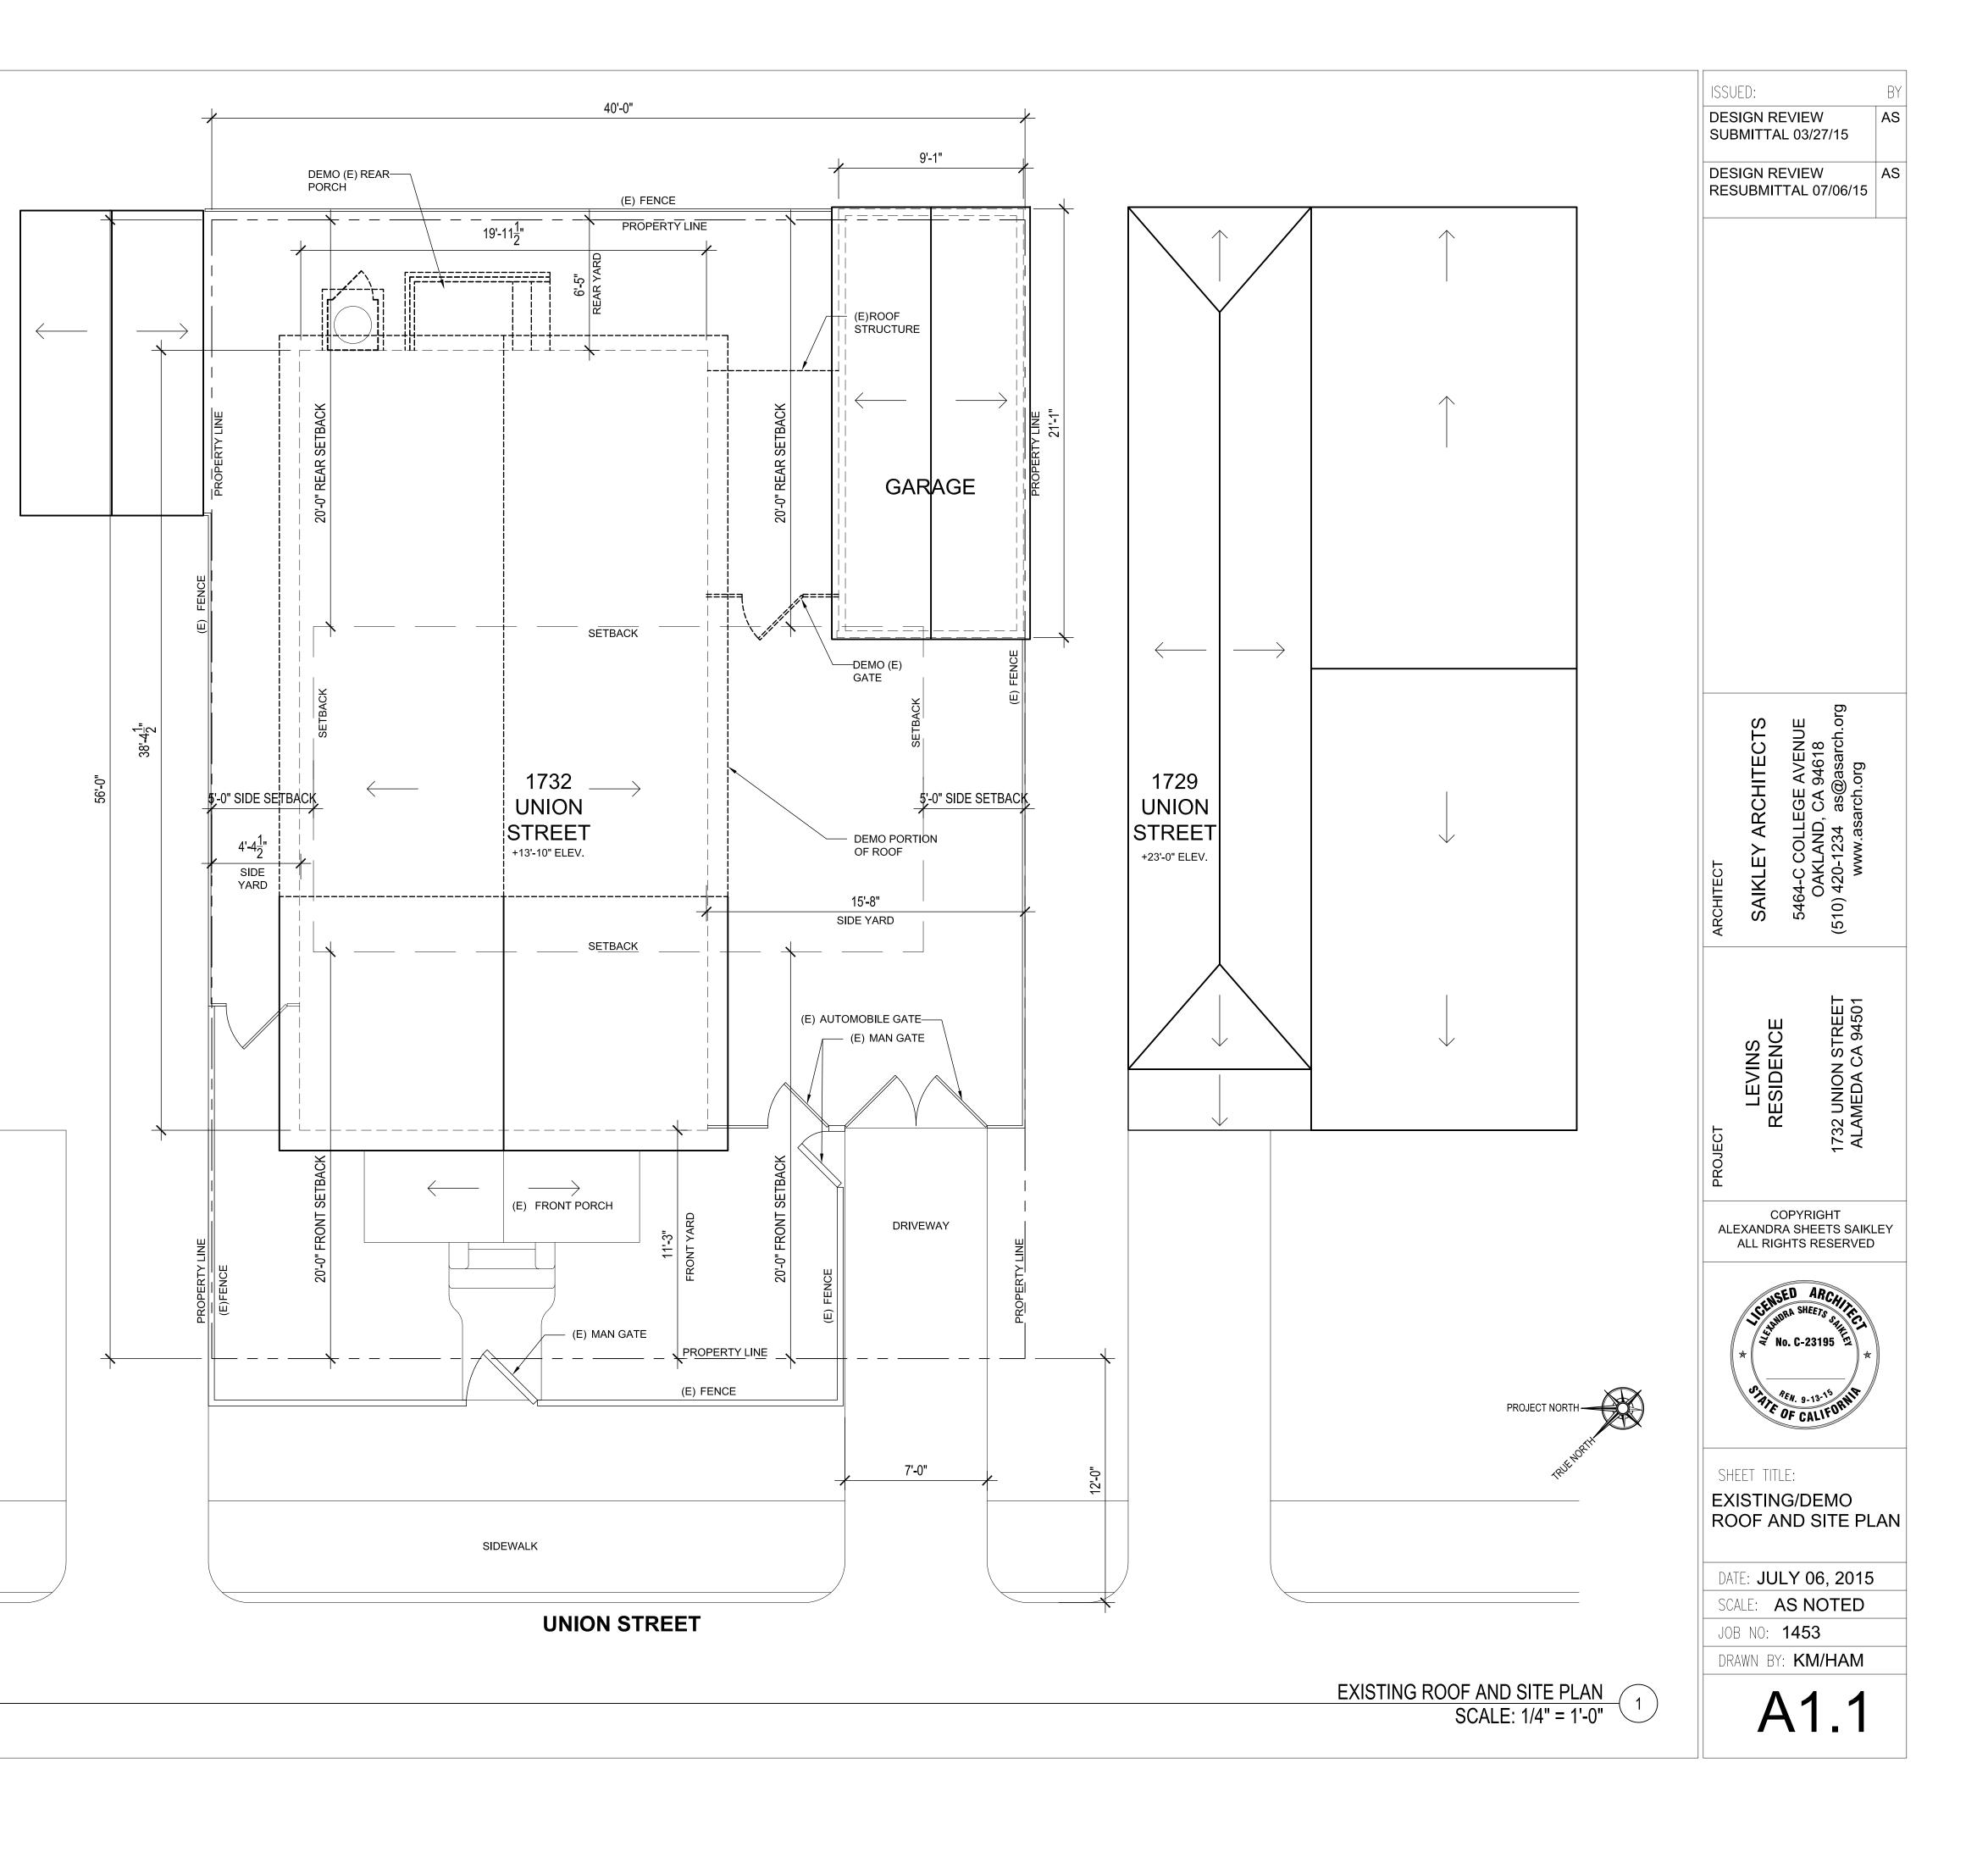1. SITE DIMENSIONS ARE BASED ON FIELD MEASUREMENTS AND ARE +/-.



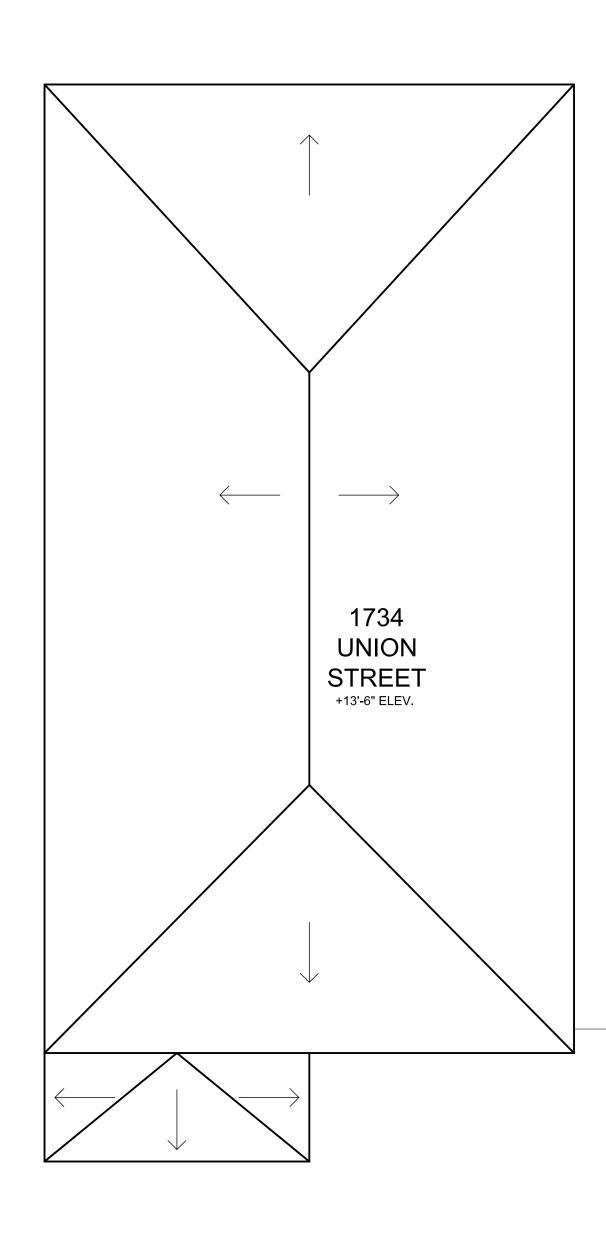

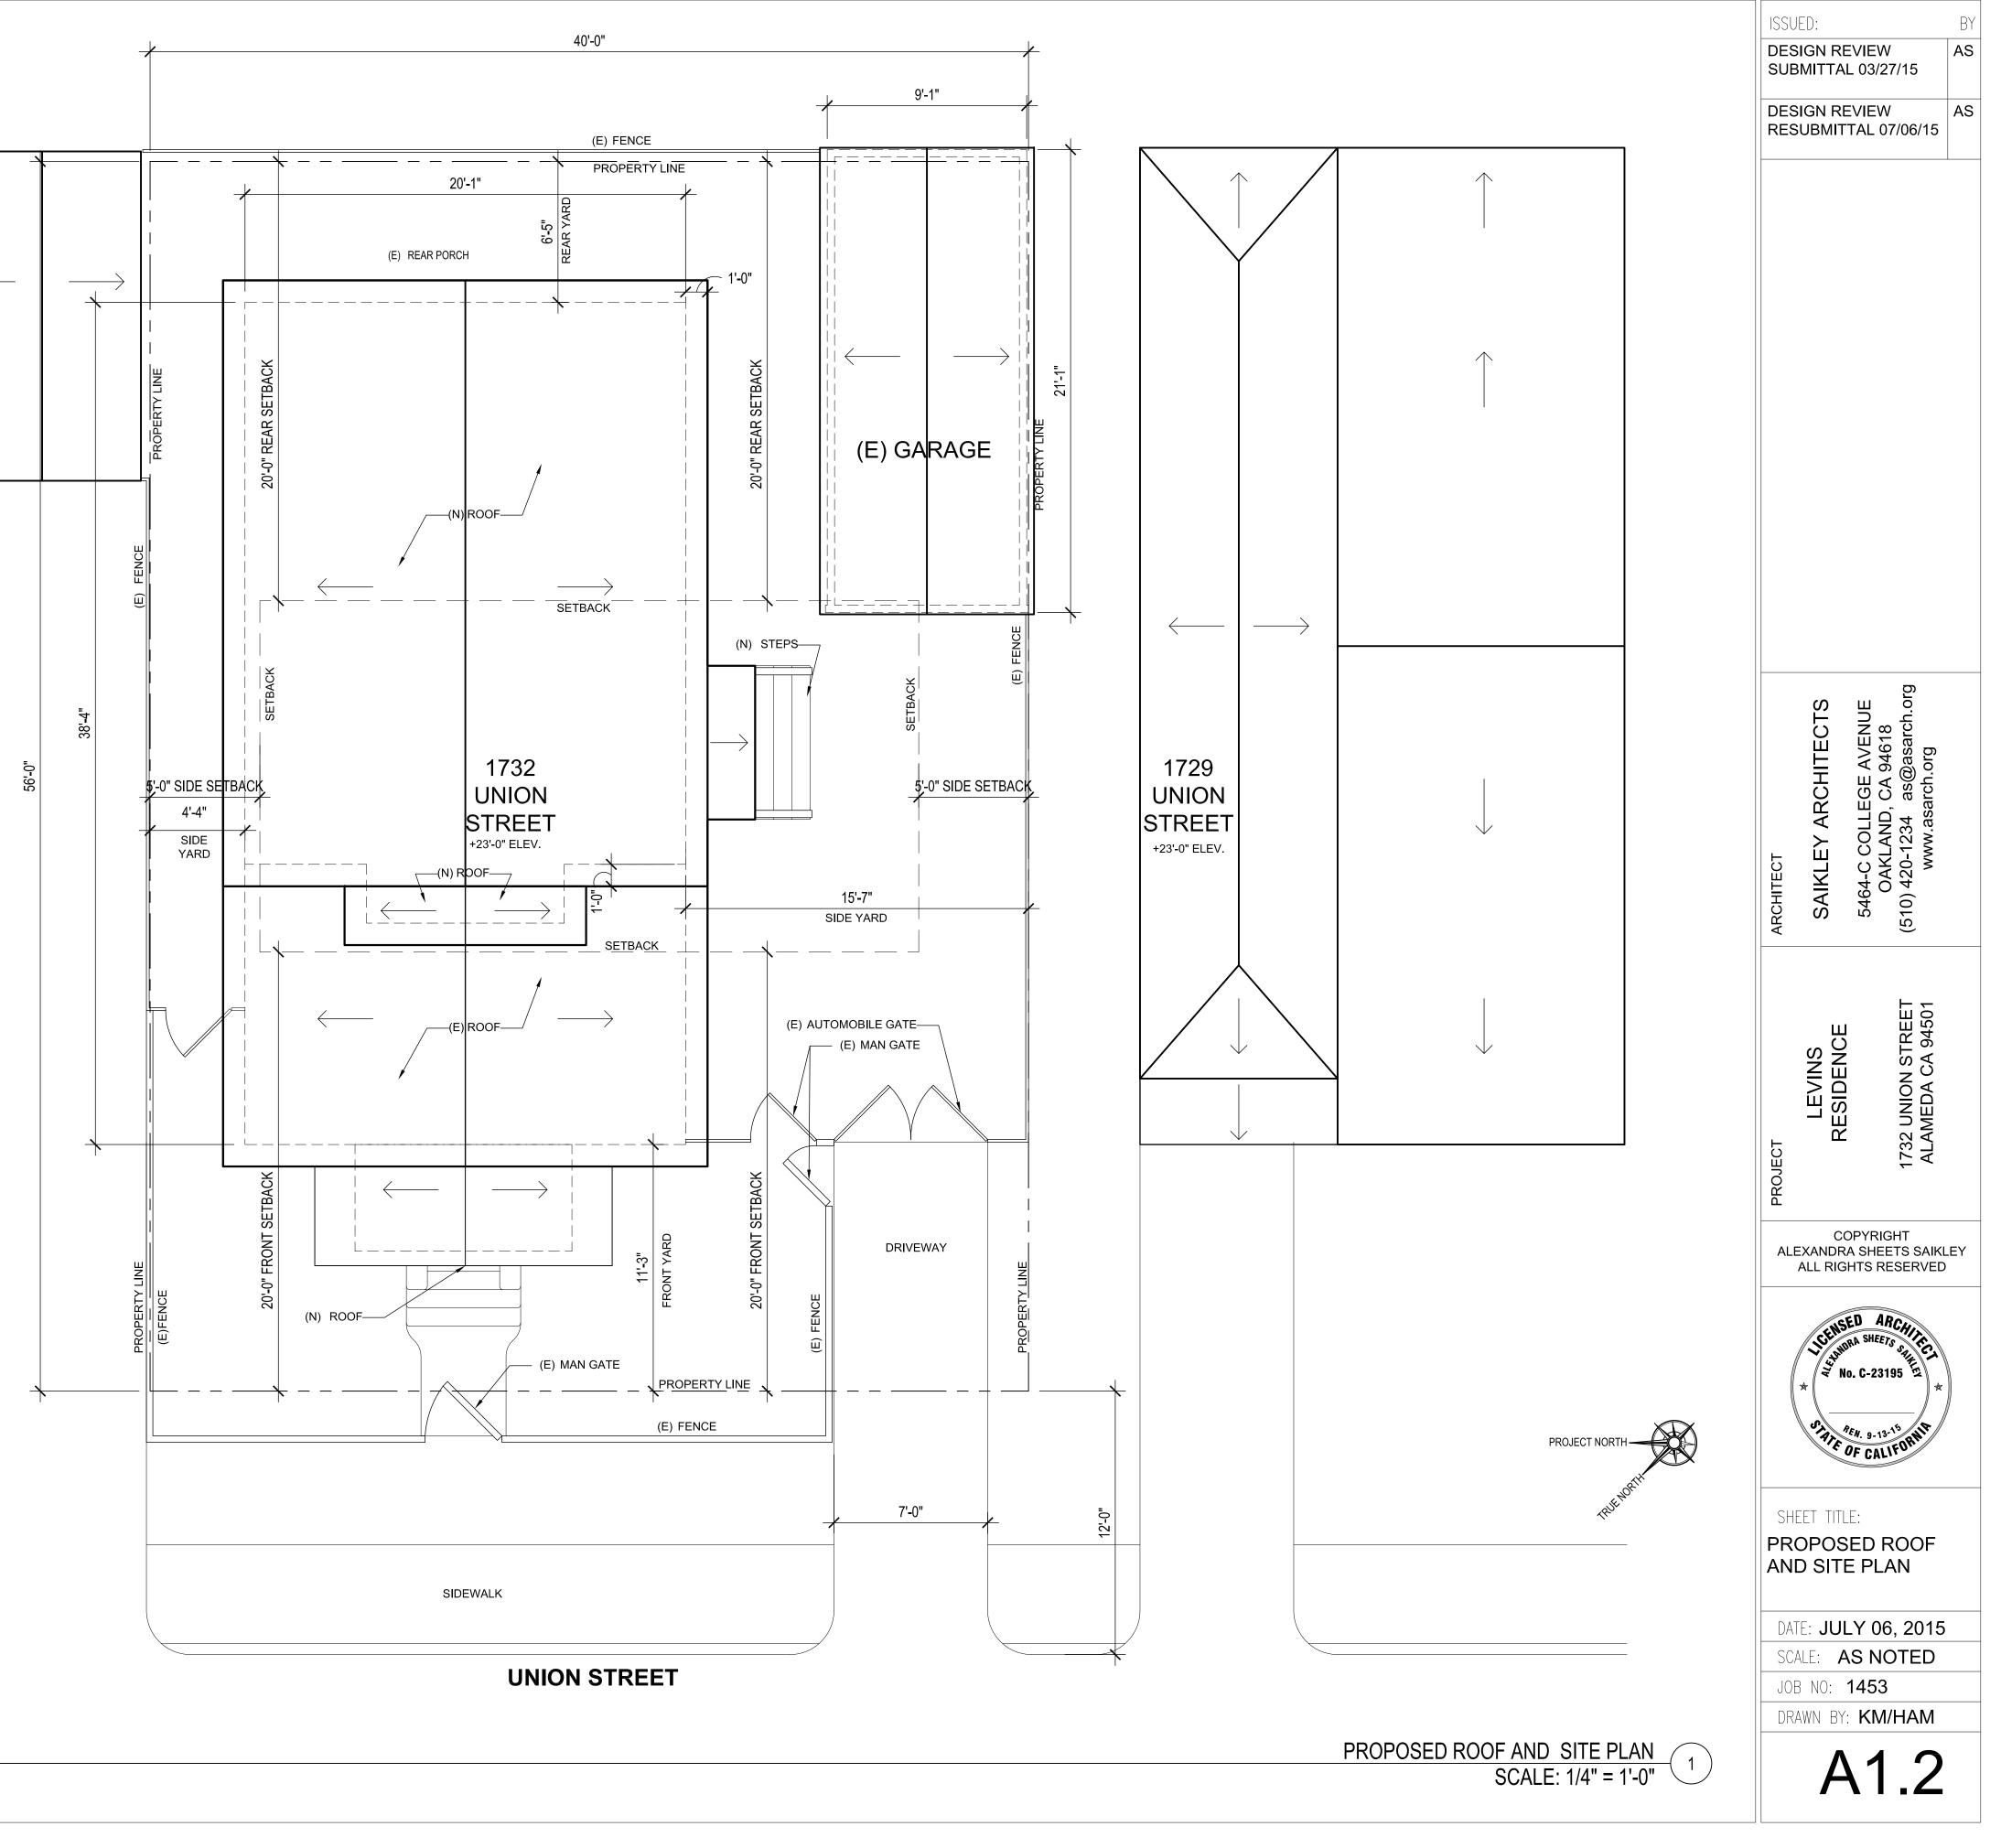

ALL HEIGHTS ARE +/-, CONTRACTOR TO V.I.F.
 ALL WINDOWS TO BE REPLACED.
 ALL INTERIOR DOORS TO BE REPLACED.

KEY NOTES

(E) FIREPLACE TO REMAIN

(E) CABINETRY TO BE REMOVED

(E) PLUMBING TO BE REMOVED

(E) WASHER/DRYER TO BE RELOCATED

(E) PORCH TO BE REMOVED

6 (E) EXTERIOR DOOR TO BE REMOVED


7 REMOVE ALL FINISHES

ASSESS DRY-ROT DAMAGE. DEMOLISH DAMAGED PORTION OF (E) PORCH.


(9) (E) GATE AND ROOF **STRUCTURE TO BE** REMOVED

10 REMOVE (E) CONC. PAD AND METAL LOCKER, WATER HEATER TO BE RELOCATED




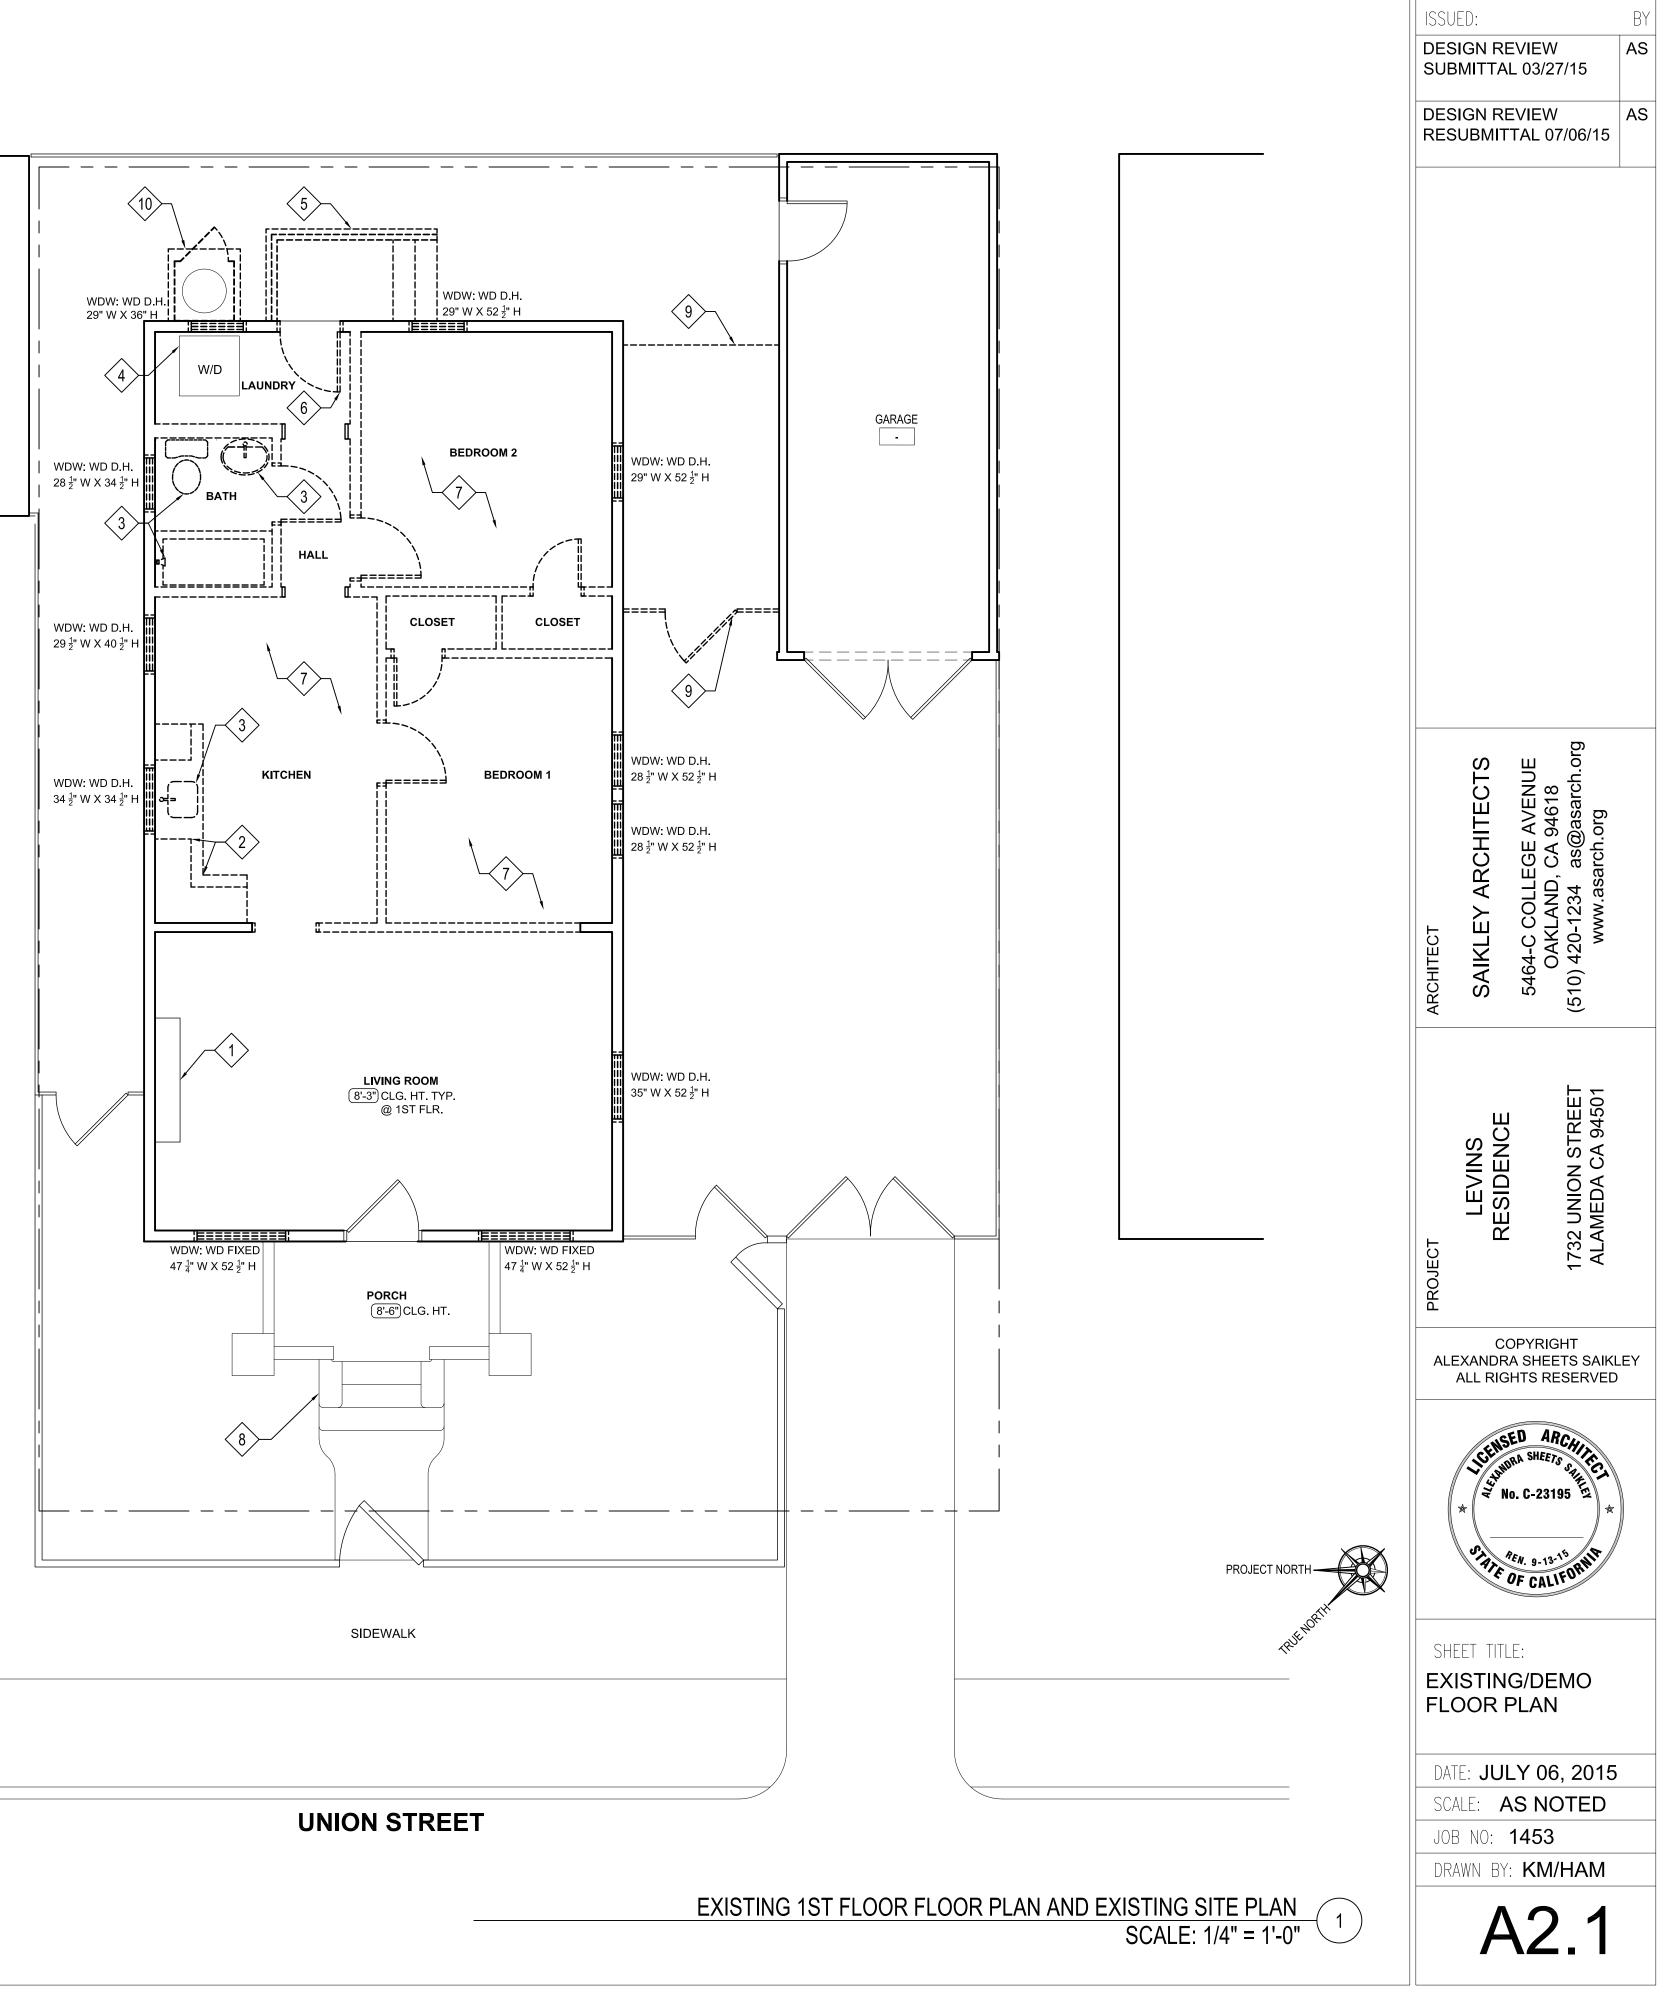


ALL HEIGHTS ARE +/-, CONTRACTOR TO V.I.F.
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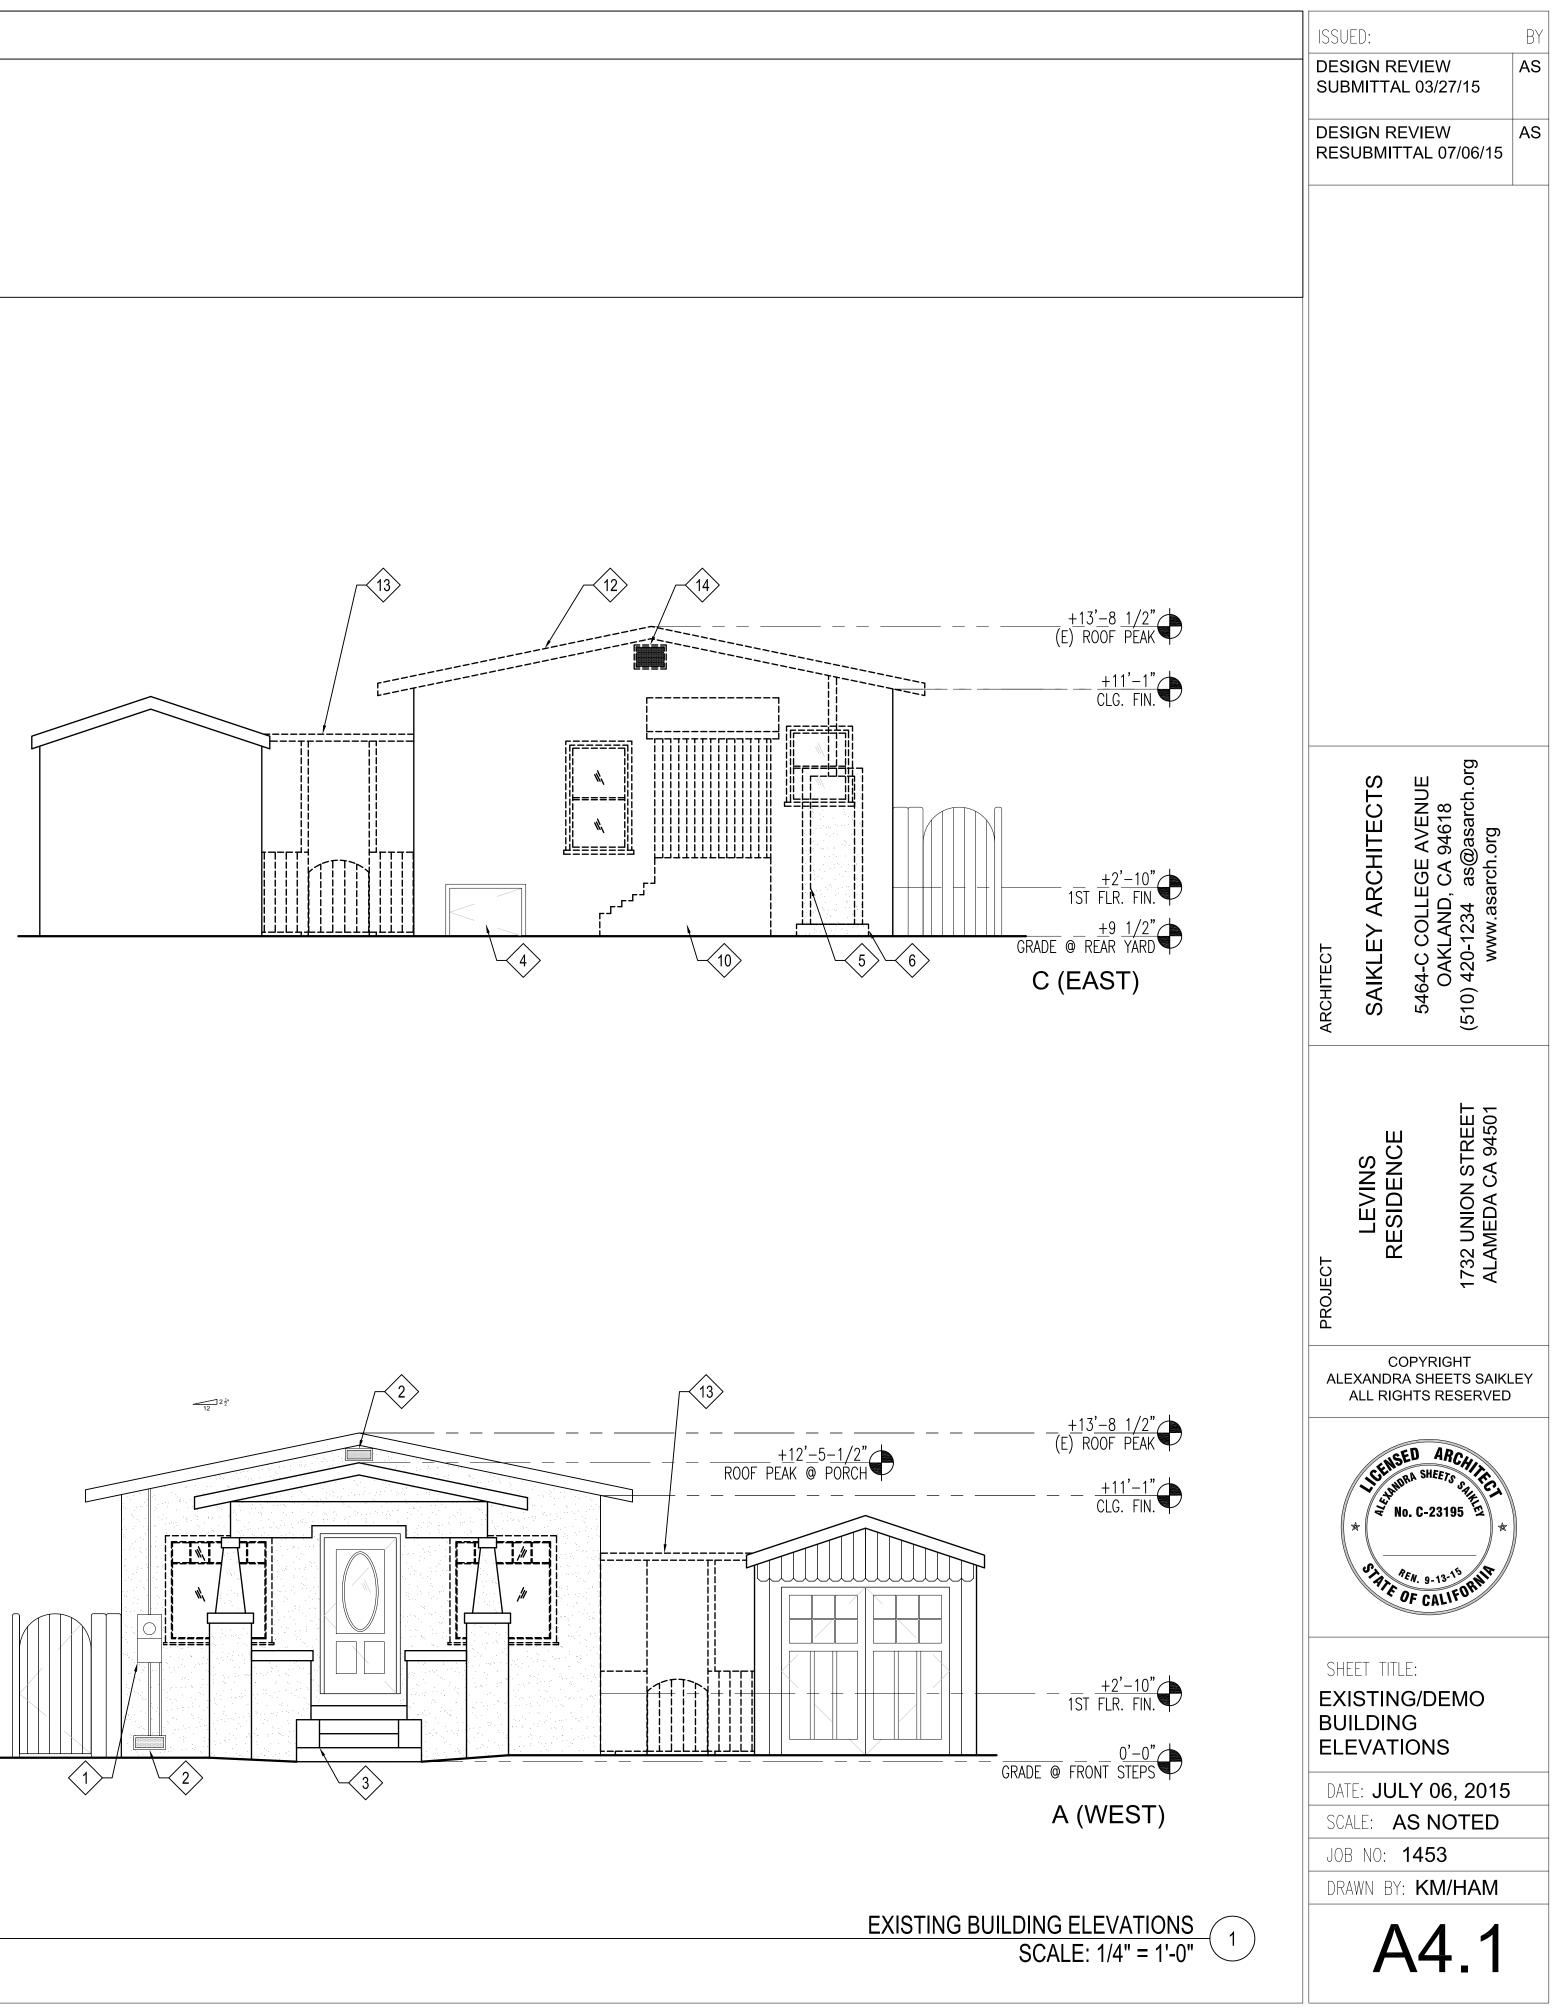


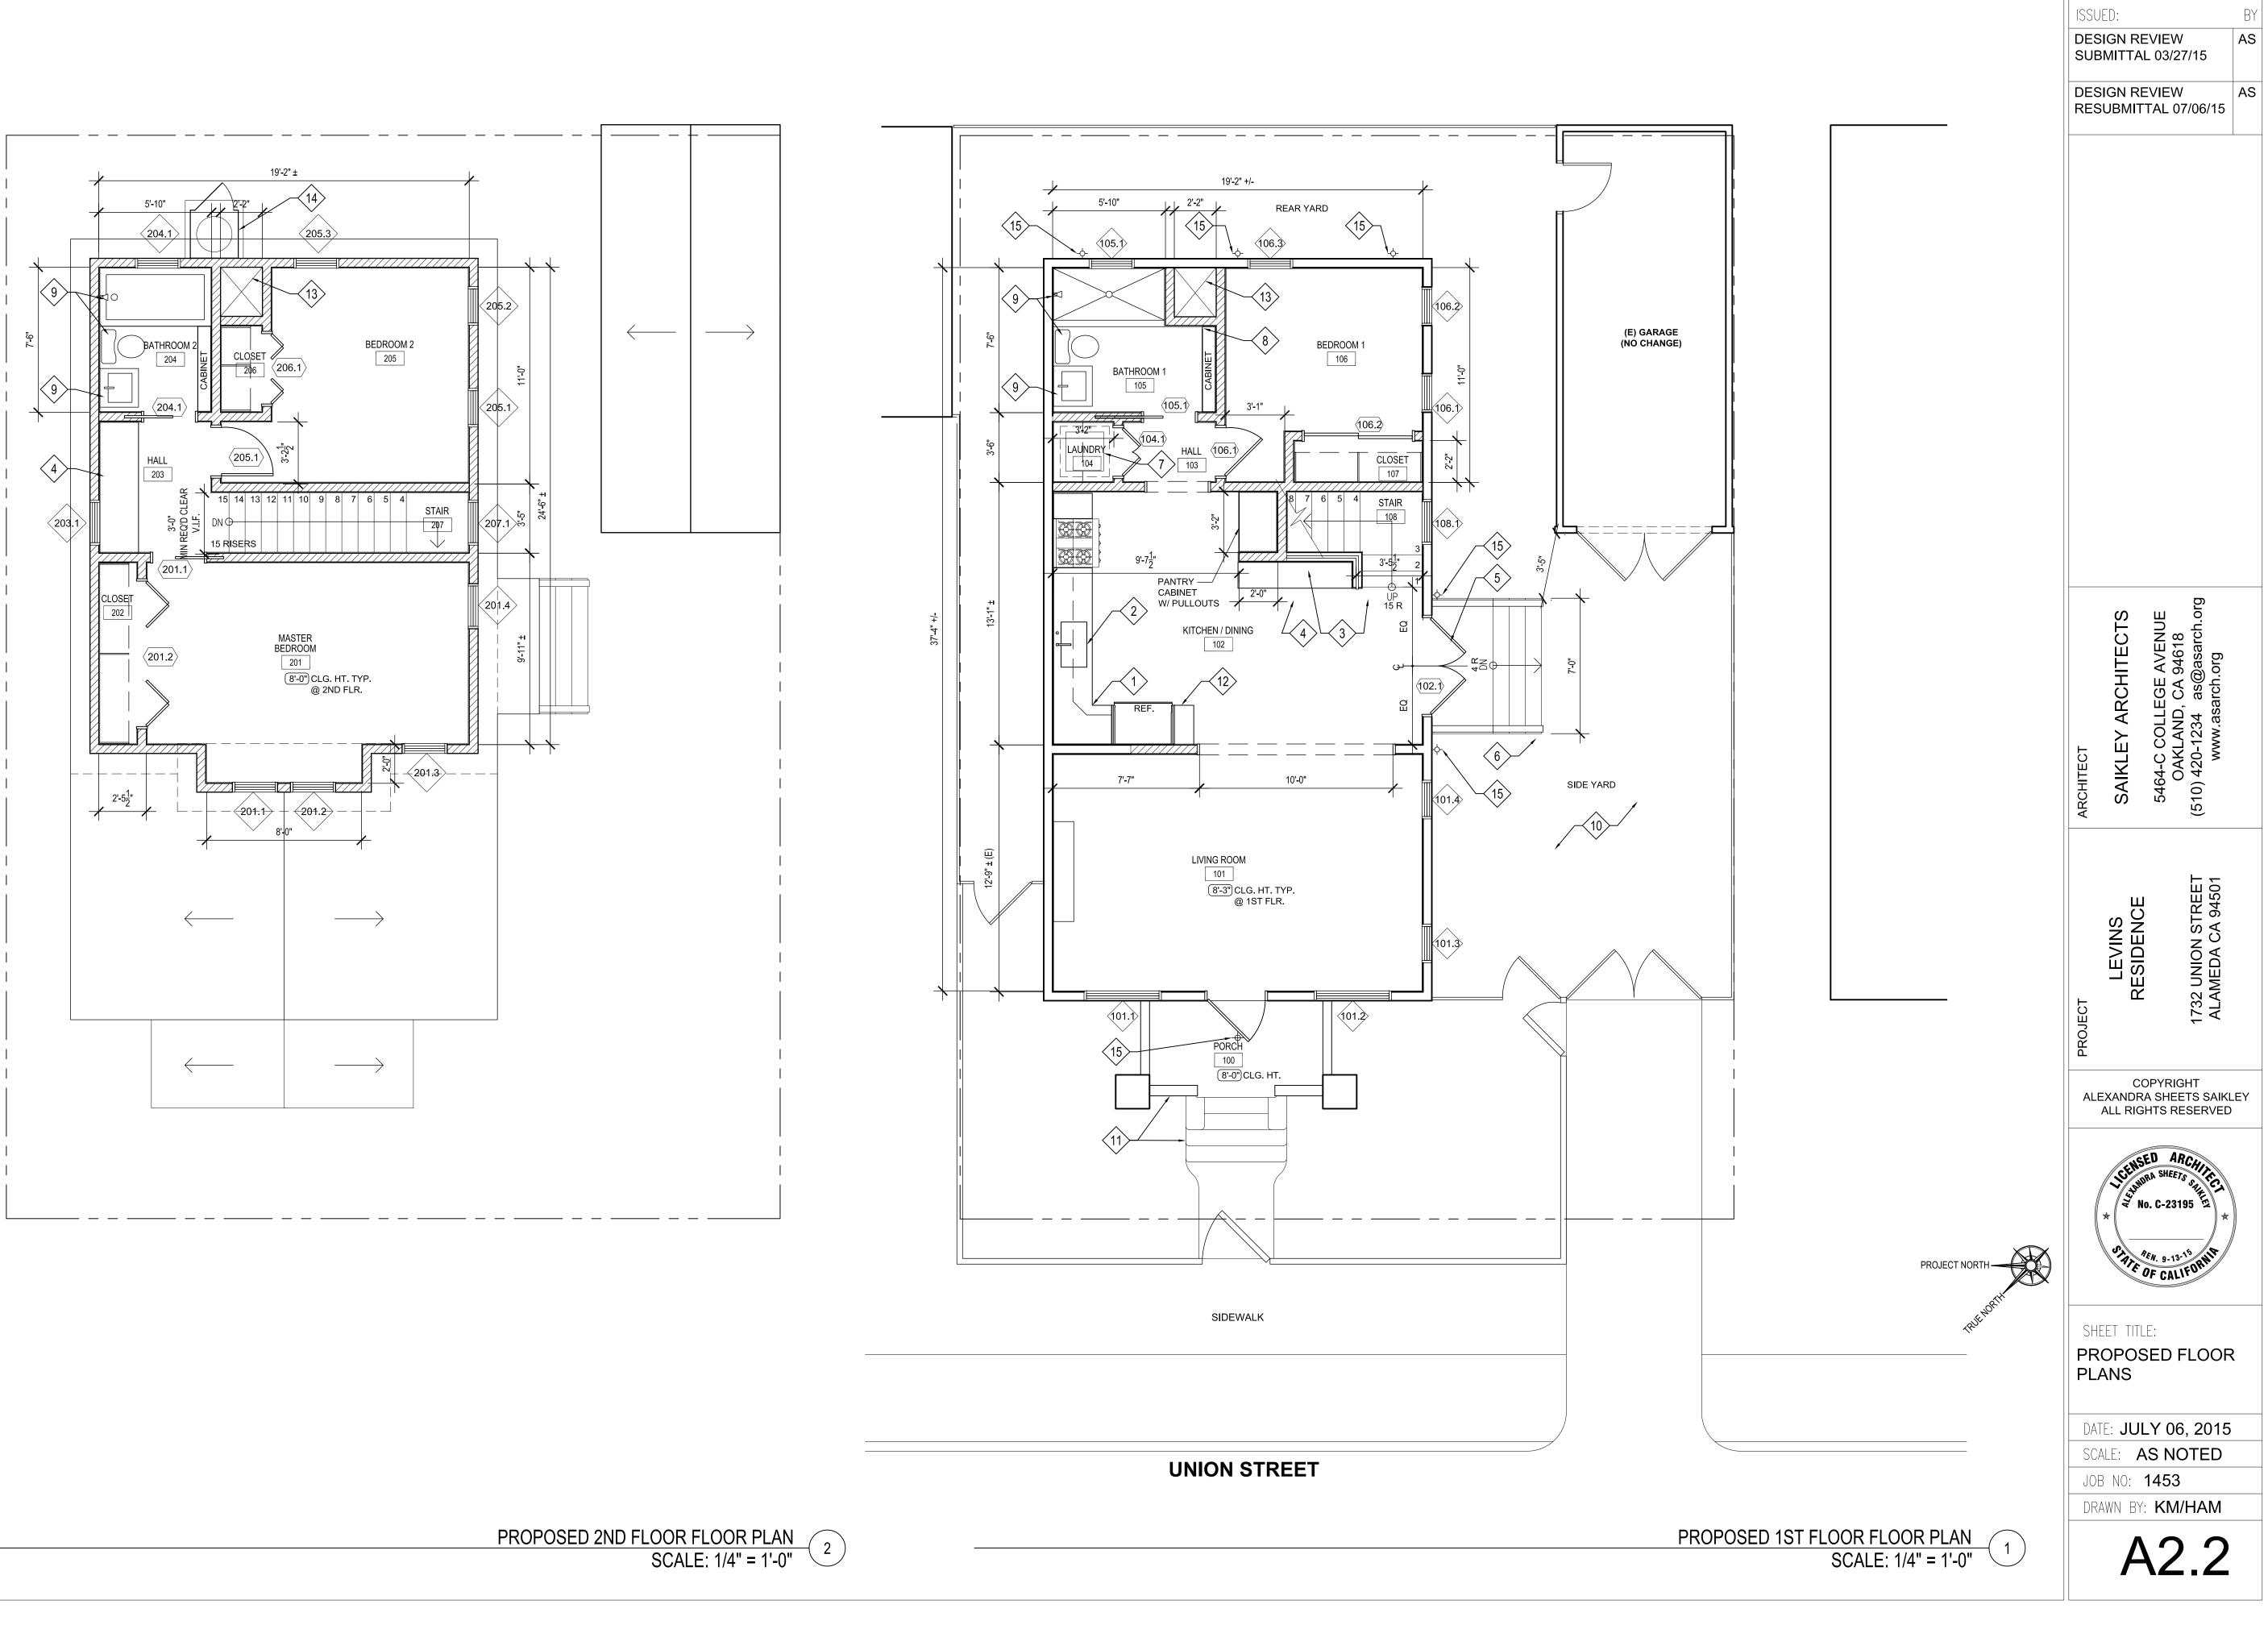- **KEY NOTES**
- (N) CABINETRY
- 2 (N) SINK
- (N) WOOD STAIRS W/ OPEN RAIL
- $\langle 4 \rangle$ (N) BUILT-IN STORAGE BENCH
- (N) FRENCH DOORS TO SIDE YARD
- 6 (N) EXTERIOR WOOD LANDING AND STAIRS W/ OPEN RAILING
- 7 RELOCATED WASHER/DRYER
- (N) BUILT-IN CABINET
- 9 (N) PLUMBING
- 10 SIDE YARD TO BE REGRADED FOR PROPER SURFACE DRAINAGE
- REBUILD CONC. PORCH, STAIRS, AND ROOF ABOVE TO MATCH EXISTING, CONTRACTOR TO ASSESS AS REQ'D.
- (N) BROOM CLOSET
- CHASE FOR HVAC DUCT
- 14 RELOCATED METAL LOCKER W/ (E) HOT WATER TANK ON CONC. PAD
- (N) EXTERIOR LIGHTING

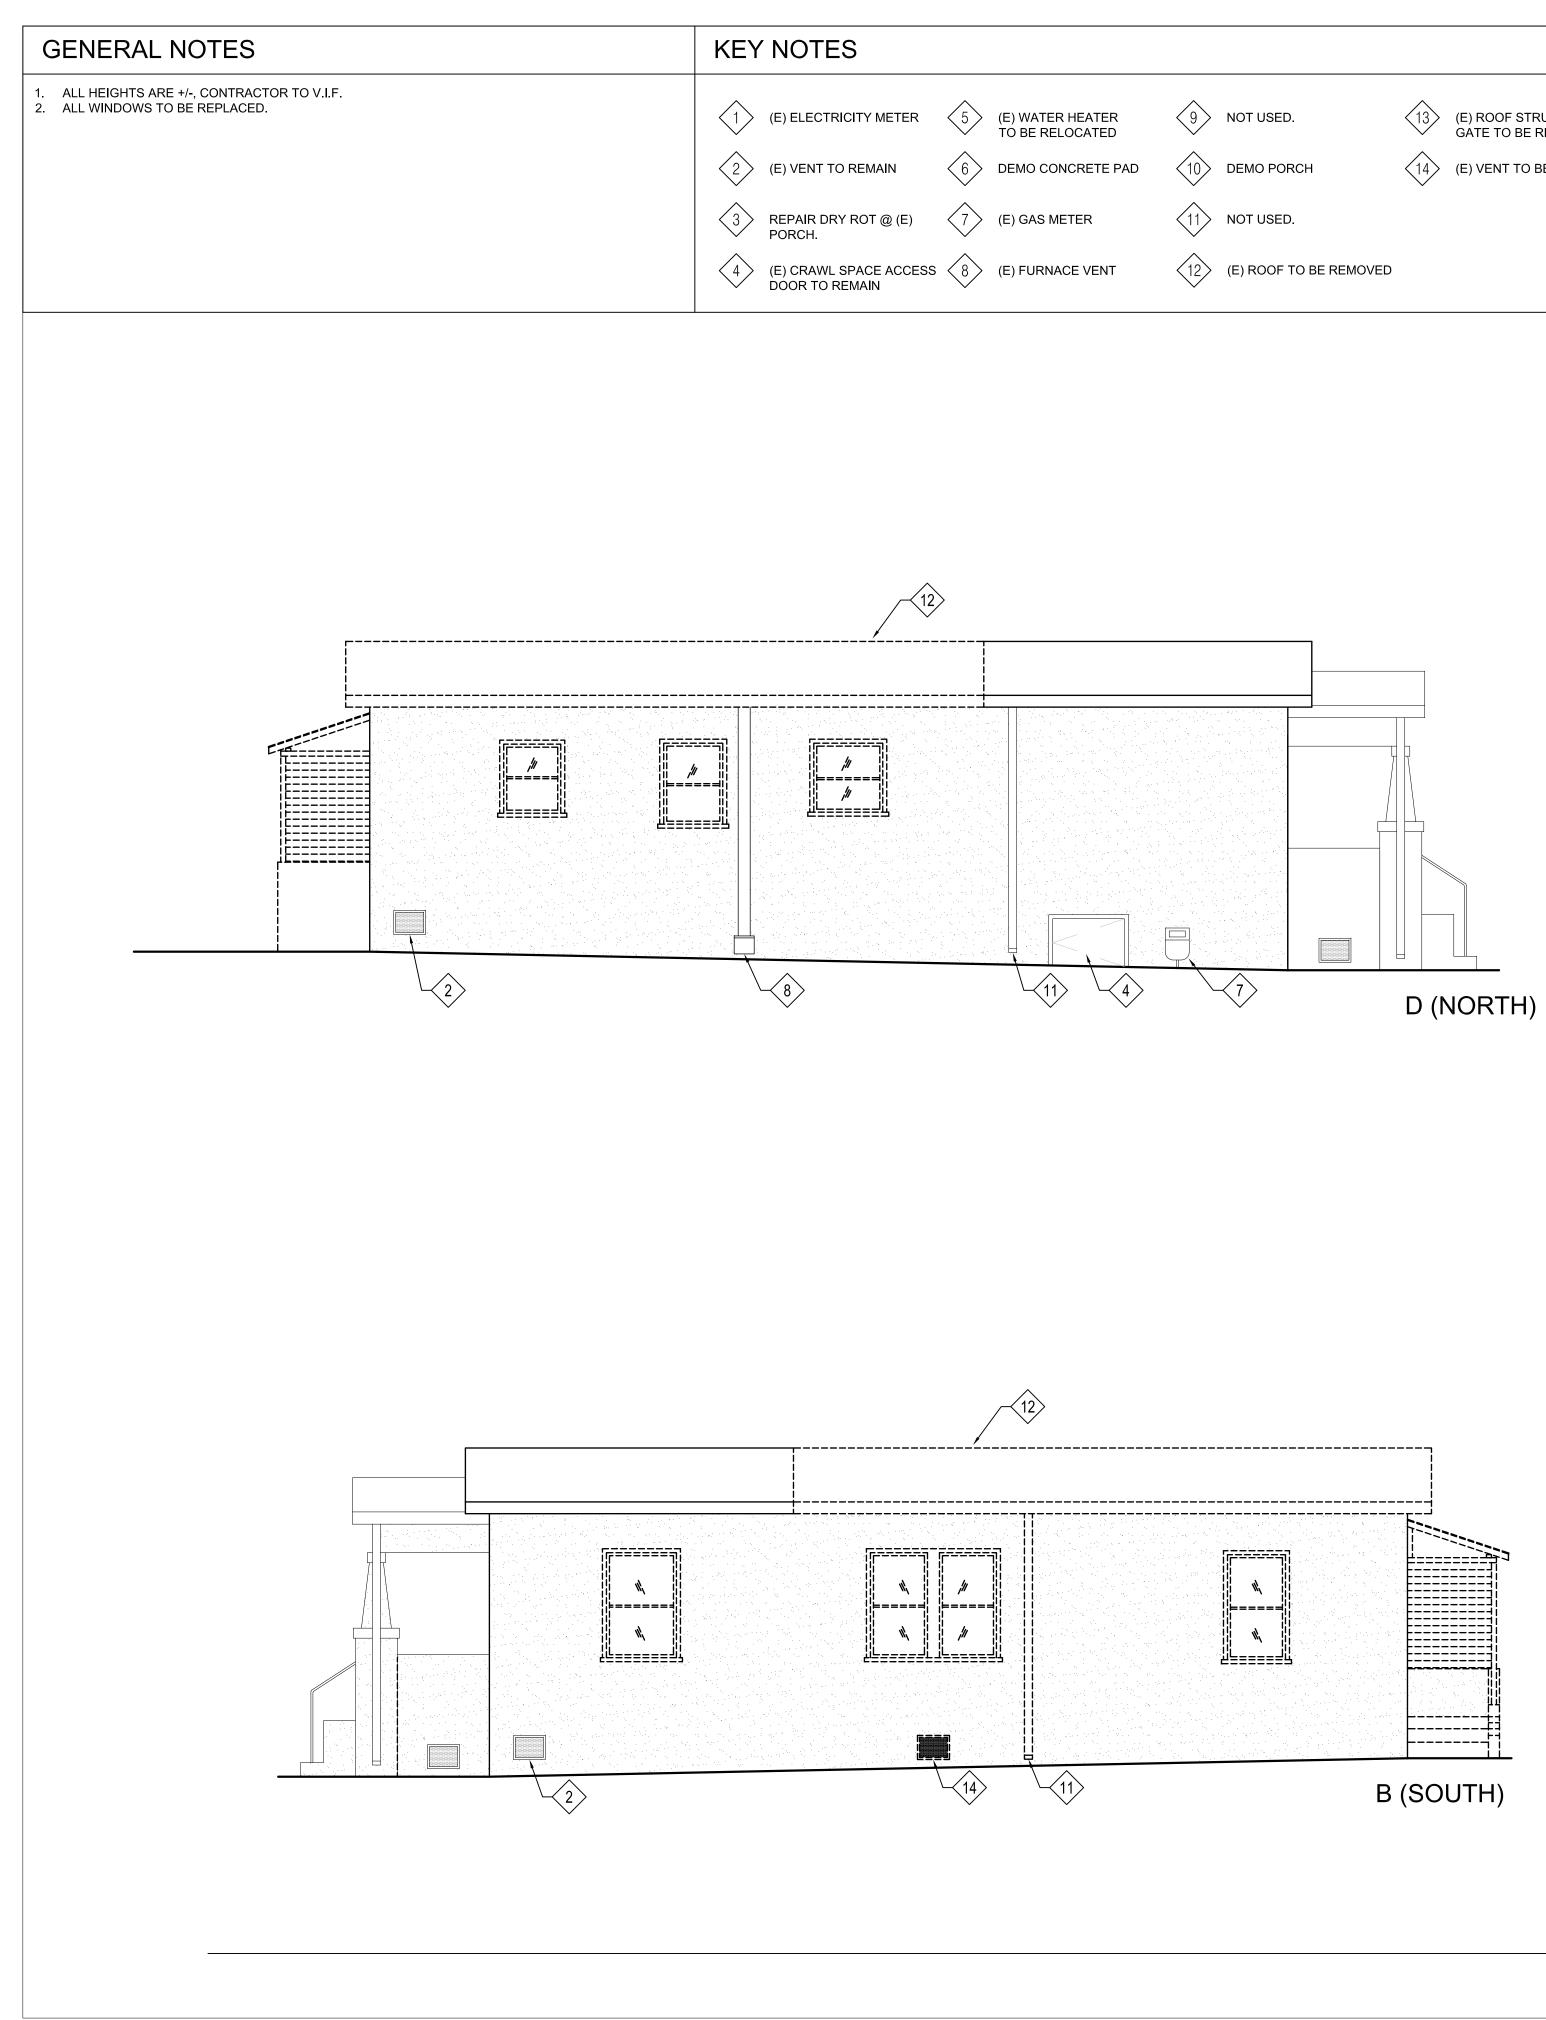

(E) ROOF STRUCTURE & GATE TO BE REMOVED (E) VENT TO BE REMOVED



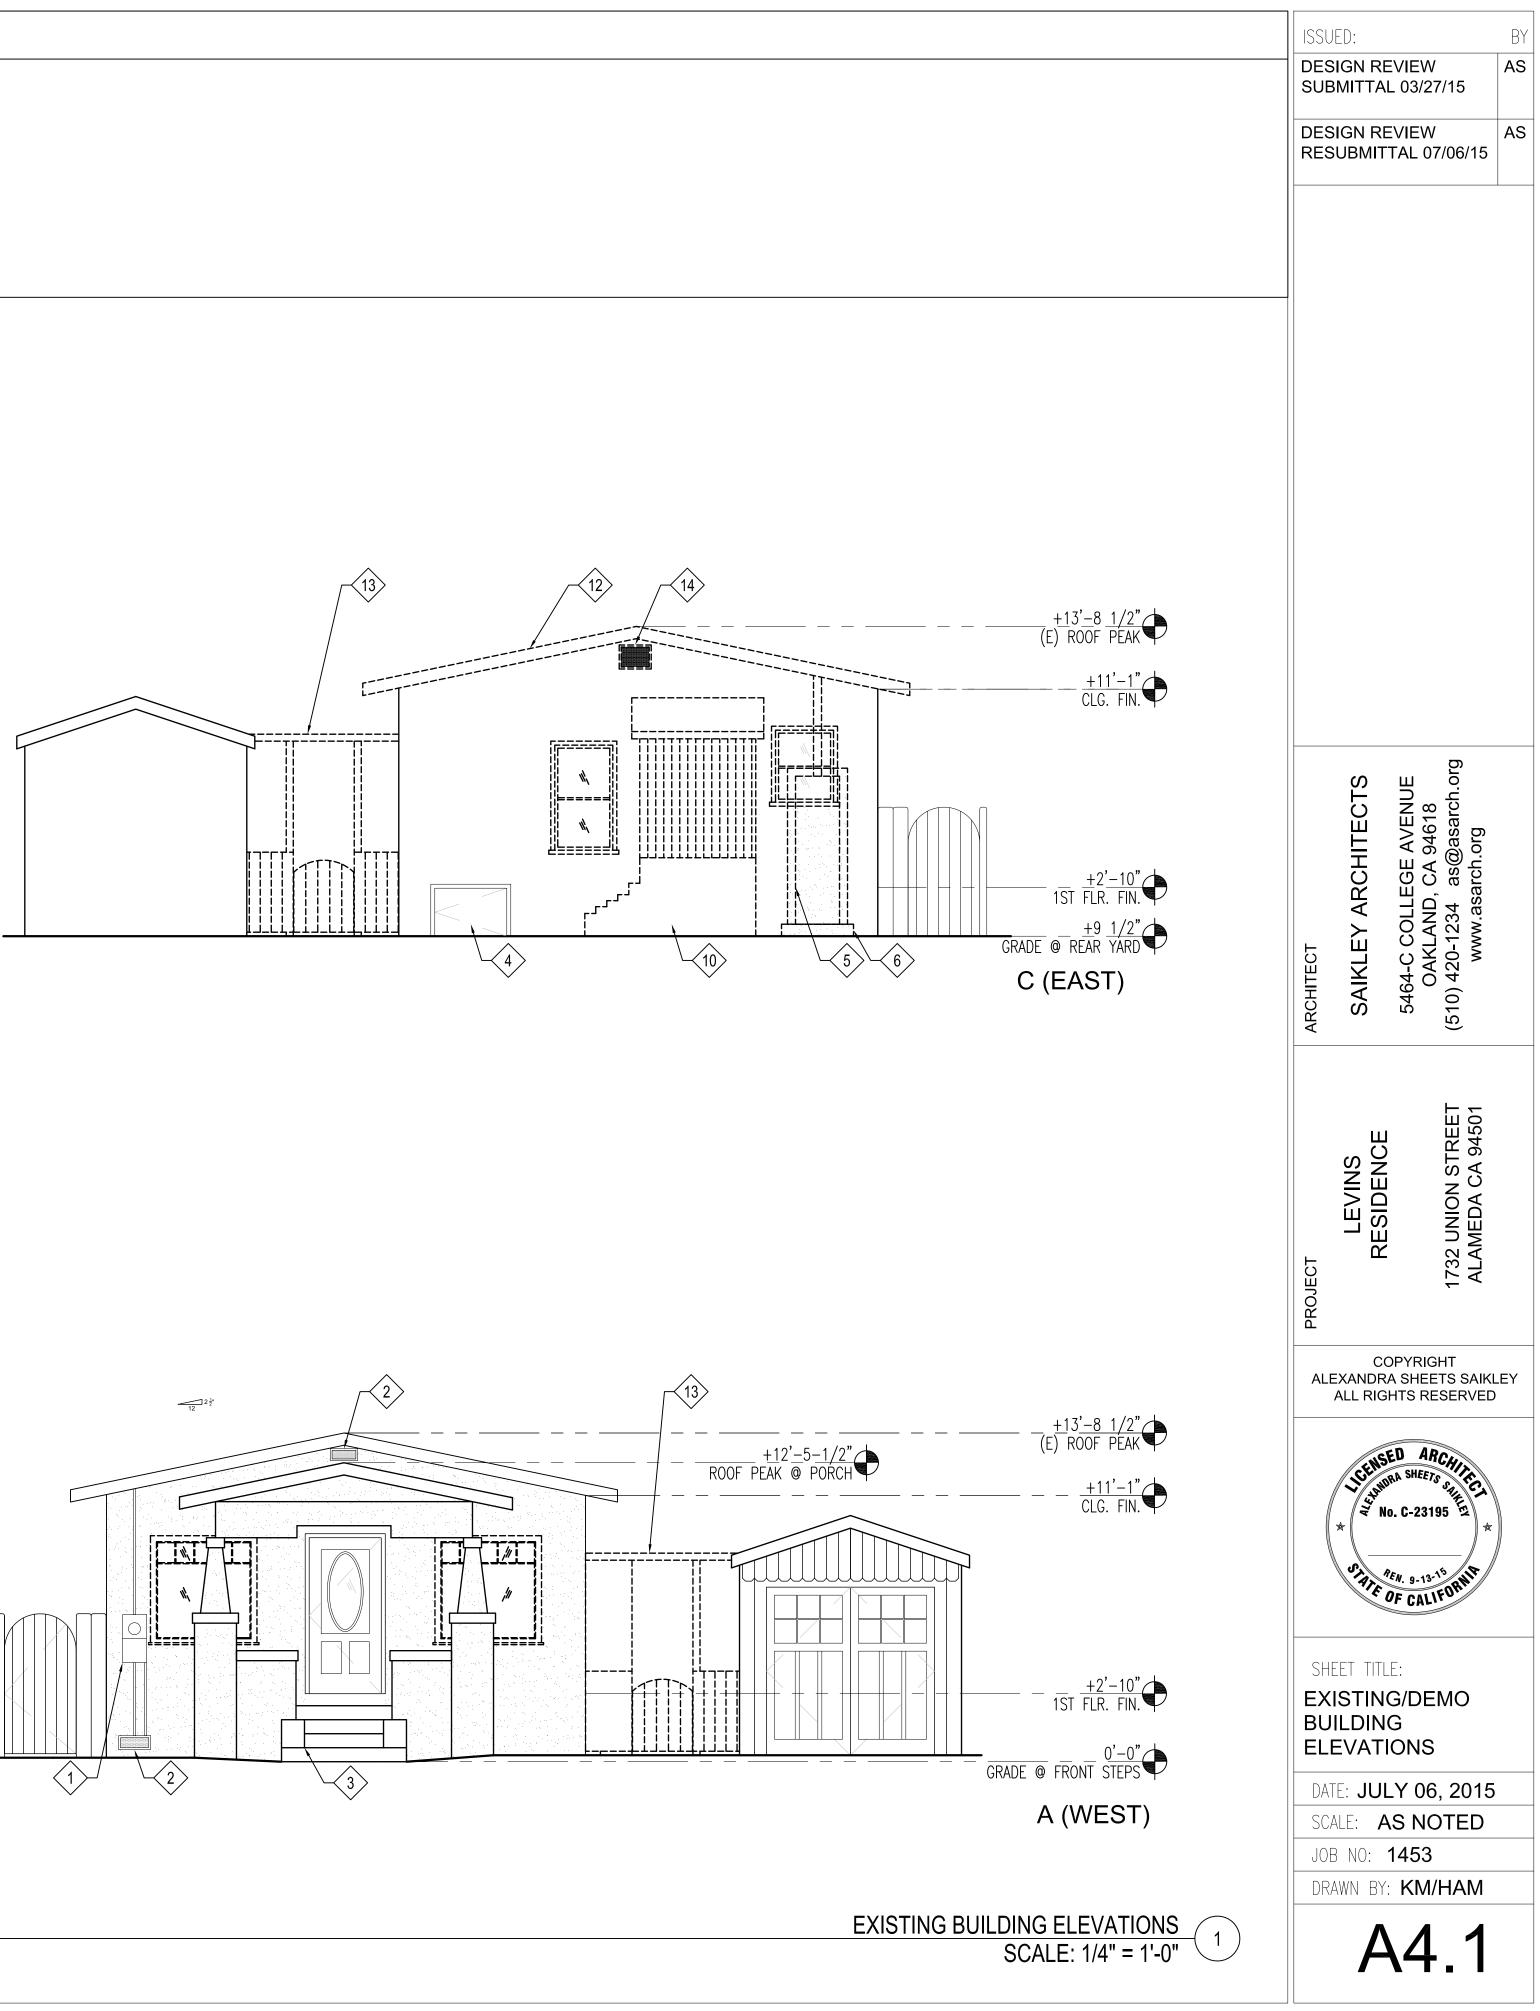



NOTE: WINDOW SCHEDULE WILL BE UPDATED AFTER PLANNING'S REVIEW OF DESIGN OPTIONS.

	OW SC	CHEDU	LE		WINDOW	/ TYPES
LOCATION	WINDOW NUMBER	WINDOW TYPE	SIZE (W x H) ROUGH OPENING	NOTES		
1ST FLOOR					AA	AAA
LIVING ROOM	101.1	EE	48" X 48"	(N) WDW IN (E) OPENING, VERIFY SIZE IN FIELD	CASEMENT C	
101	101.2	EE	48" X 48"	(N) WDW IN (E) OPENING, VERIFY SIZE IN FIELD		MULLIONS M
	101.3	CC	24" X 24"			
	101.4	CC	24" X 24"			
BATH 1 105	105.1	DD	29" X 19-5/8"			
BEDROOM 1	106.1	CC	24" X 24"			
106	106.2	CC	24" X 24"			
	106.3	AA	29" X47-5/8"	EGRESS WINDOW, REFER TO NOTE 2.		
STAIR 108	108.1	AA	29" X47-5/8"		-	
2ND FLOOR						
MASTER	201.1	CCC	29" X 47-5/8"		-	
BEDROOM	201.2	CCC	29" X 47-5/8"		-	
201	201.3	CCC	29" X 47-5/8"		DD	EE
	201.4	AAA	29" X 47-5/8"	EGRESS WINDOW, REFER TO NOTE 2.	AWNING	AWNING W/
HALL 203	203.1	AAA	29" X 47-5/8"		OBSCURE	MULLIONS
BATH 2 204	204.1	DD	29" X 19-5/8"		1	
BEDROOM 2	205.1	СС	24" X 24"			
205	205.2	CC	24" X 24"			
	205.3	AA	29" X47-5/8"	EGRESS WINDOW, REFER TO NOTE 2.		
STAIR 207	207.1	BB	29" X47-5/8"			
1. WINDOW ALL WINDO NOT TO BE 2. BEDROC MIN. 24" C	OWS SHALL BE REMOVED UN OM EGRESS WII LEAR OPENING ILL HEIGHT A.F	TOR: 0.36. MAX LABELED WITH TIL INSPECTED NDOWS TO PR G HEIGHT, MIN		PRMATION, E FEET NET OPENING,		

ISSUED: DESIGN F SUBMITT	AL 03/2	27/15		BY AS					
DESIGN REVIEW AS RESUBMITTAL 07/06/15									
ECTS	ENUE	arch.org							
ARCHITE	LEGE AV	UAKLANU, CA 94618 420-1234 as@asarch www.asarch.ord	ସରସା ଦା <u>।</u> ପା ପ						
ARCHITECT SAIKLEY ARCHITECTS	5464-C COLLEGE AVENUE	04KLANU, CA 94618 (510) 420-1234 as@asarch.org אאאאי asarch ord							
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*			*						
SHEET TITLE:									
WINDO	WINDOW SCHEDULE								
SCALE:	DATE: JULY 06, 2015 SCALE: AS NOTED								
	JOB NO: 1453 DRAWN BY: KM/HAM								
 	15	1.							

S				
BB FIXED W/ MULLIONS	CC AWNING	 	 A <u>LIGN HEAD H</u> T ALIGN HEAD HT	[<u>. @</u> 6'-8" [. @ 6'-4"
	·	 	 ELEV FINISH FI	/: 0'-0" LOOR
// 5 		 	 <u>ALI</u> G <u>N H</u> E <u>AD H</u> I	Г <u>. @</u> <u>6'-</u> 8"
		 	 ELEV FINISH FI	/: 0'-0" LOOR