






## PARK ESQUINA

## **BLANDING AVENUE**

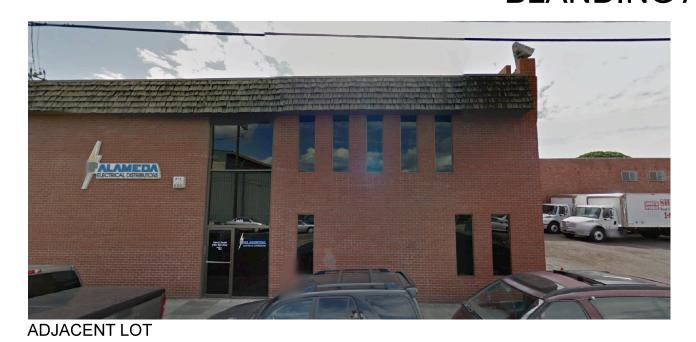








### **VICINITY MAP**

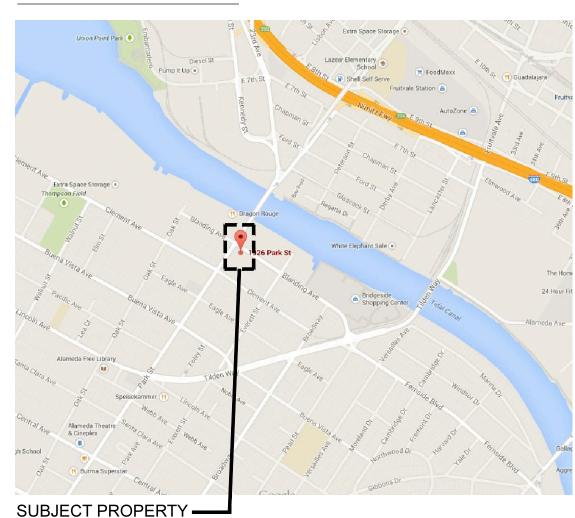

### SCOPE OF WORK

PROPOSED CORE AND SHELL OF A NEW COMMERCIAL FACILITY COMPOSED OF A SERIES OF FIVE SMALLER TWO-STORY STRUCTURES.

STRUCTURE AT THE CORNER OF PARK STREET AND BLANDING AVENUE TO HOUSE RETAIL AND/OR RESTAURANT ON THE GROUND FLOOR AND RESIDENTIAL UNIT ON THE SECOND AND THIRD FLOORS WITH A PRIVATE ROOF DECK ABOVE THE SECOND FLOOR.

FOUR ADDITIONAL STRUCTURES ALONG BLANDING AVENUE TO HOUSE OFFICE TENANTS ON GROUND FLOOR AND SECOND FLOOR.

SEPARATE PERMITS:

TENANT IMPROVEMENT WORK TO BE UNDER SEPARATE PERMITS, INCLUDING COMMERCIAL KITCHEN REQUIREMENTS FOR RESTAURANT TENANT.

### PROJECT INFORMATION

ADDRESS: 1926 PARK STREET ALAMEDA, CA 94501

PARCEL: 70-194-1

PROPOSED USE:

LOT AREA:

**ZONING DISTRICT:** NP-G, NORTH PARK ST GATEWAY **CONSTRUCTION TYPE:** VB

RETAIL / CAFE, WORK-LIVE & OFFICE

OCCUPANCY TYPE: GROUP B (BUSINESS)

6,693 sf

**SETBACKS:** MINIMUM **PROPOSED** FRONT: **REAR**: SIDE STREET: 0' - 15' 0' FOR 20' SIDE YARD:

#### **BUILDING HEIGHT & BULK:**

HEIGHT # STORIES PROPOSED: THREE +/- 29'-2" PERMITTED: 60' SIX

NINE (9) REQUIRED PARKING SPACES WILL BE PROVIDED OFF-SITE WITHIN A DISTANCE OF 1,000 FEET

### PROJECT DIRECTORY

MARCEL SENGUL 1726 PARK STREET ALAMEDA, CA 94501 TEL: 415 503 8629 EMAIL: MARCELSENGUL@GMAIL.COM

**ARCHITECT** BRIDGETT SHANK TIMBRE ARCHITECTURE 419 MERRITT AVE, SUITE D OAKLAND, CA 94610

TEL: 415 200 8106 EMAIL: BRIDGETT@TIMBREARCH.COM STRUCTURAL ENGINEER

NATE WILLIAMS MOSSWOOD ENGINEERING 3360 ADELINE STREET BERKELEY, CA 94703 TEL: 415 839 1022 NATE@MOSSWOODENGINEERING.COM

### DRAWING INDEX

GENERAL G0.0 COVER SHEET

LANDSCAPE L3.0 LANDSCAPE PLAN

ARCHITECTURAL A1.0 SITE PLAN A2.0 FIRST FLOOR PLAN A2.1 SECOND FLOOR PLAN

A2.2 ROOF PLAN A3.0 EXTERIOR ELEVATIONS A3.1 EXTERIOR ELEVATIONS

A3.2 EXTERIOR ELEVATIONS

A10.0 WINDOW AND DOOR SCHEDULE

TIMBRE ARCHITECTURE Oakland, CA 94610 p 415 200 8106

## Park Esquina

ADDRESS 1926 Park Street Alameda, CA 94501

Marcel Sengul

CURRENT RELEASE DATE October 05, 2015

Park Esquina, LLC

CURRENT RELEASE SET **DESIGN REVIEW** 

PREVIOUS RELEASE DATE

SHEET TITLE

### PROJECT INFORMATION

SCALE JOB NUMBER DRAWN BY

### PLANTING LEGEND

SYB	PLANT NAMES	QTY/SIZE
0	Q <i>UERCUS AGRIFOLIA 'NATURAL'</i> COAST LIVE OAK	(6) 36" BOX
	ARBUTUS MARINA 'MULTI' STRAWBERRY TREE	(8) 24" BOX
Fe Ma	FESTUCA MAIREI ATLAS FESCUE	(50) 1 GAL
Mh Ri	<i>MUHLENBERGIA RIGENS</i> DEER GRASS	(40) 5 GAL
Se Au	SESLERIA AUTUMNALIS AUTUMN MOOR GRASS	(48) 1 GAL

SYB	PLANT NAMES	QTY/SIZE
Le Co	LEYMUS CONDENSATUS CANYON PRINCE WILD RYE	(62) 1 GAL
Sa Sp	SALVIA SPATHACEA HUMMINGBIRD SAGE	(30) 1 GAL
Wo Fi	<i>WOODWARDIA FIMBRIATA</i> GIANT CHAIN FERN	(50) 5 GAL
Po Mu	POLYSTICHUM MUNITUM WESTERN SWORD FERN	(50) 1 GAL

### SYMBOL LEGEND

----- PROPERTY LINE

(E) HARDSCAPE TO E REMOVED AND REPLACED WITH PERMEABLE LANDSCAPING



(E) HARDSCAPE TO REMAIN




RESURFACED HARDSCAPE, SLOPE TO DRAIN MIN. 1/4" PER FOOT

### LANDSCAPE NOTES

PLANT LIST BELOW.

- LANDSCAPING AND PLANT SELECTIONS TO FOLLOW BAY-FRIENDLY LANDSCAPE GUIDELINES.
   ALL PLANTS TO BE NON-INVASIVE, LOW WATER PLANTS. NATIVE SPECIES WILL BE PRIORITIZED. SEE
- 3. LOCATION AND QUANTITY OF TREES AS INDICATED ON LANDSCAPE PLAN. SPECIES PLACEMENT TO BE DETERMINED.
- QUANTITY AND PLACEMENT OF SHRUBS AND PERENNIALS WITHIN LANDSCAPE REAS TO BE
- 5. PERMEABLE PAVER ZONES TO BE NDZ EZ ROLL GRAVEL PAVER CELLS OR SIMILAR.

Leco (Mh Ri) (Mh Ri) (Mh Ri) (Mh Ri) (Mh Ri) TENANT 2 973 sf OUTDOOR SEATING TENANT 1A 390 sf W.C. 2/ TENANT 4 500 sf TENANT 5 973 sf ADJACENT 1512 SQFT IMPERVIOUS PAVING: TBD BUILDING (5)  $36"X36"x36"X\frac{1}{4}"$  THICK RAISED STEEL PLANTERS: TBD ADJACENT BUILDING

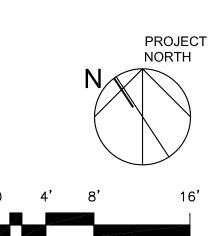

Park Esquina

TERRE<sub>MOTO</sub>

ARCHITECTURE

78 PARK STREET

SAN FRANCISCO, CA 94110

INFO@TERREMOTO.LA

LANDSCAPE

415.205.4049

1926 Park Street Alameda, CA 94501

OWNER

Marcel Sengul Park Esquina, LLC

CURRENT RELEASE DATE October 5, 2015

CURRENT RELEASE SET DESIGN REVIEW

DATE

PREVIOUS RELEASE

SHEET TITLE

LANDSCAPE PLAN

SCALE JOB NUMBER DRAWN BY


1/8" = 1'-0"

PROPOSED LANDSCAPE PLAN

**BLANDING AVENUE** 

### **BLANDING AVENUE**



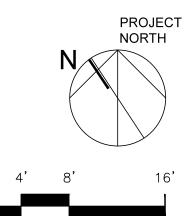



—-—- PROPERTY LINE

FIRE HYDRANT

POWER POLE

TRAFFIC SIGNAL

UNDERGROUND UTILITY ACCESS

WM WATER METER

MAIN ELECTRICAL PANEL

 $\xrightarrow{2\% \text{ SLOPE}}$  SLOPE OF FIN. GRADE

MOTION ACTIVATED SECURITY LIGHTS & CAMERAS

ARCHITECTURAL ACCENT LIGHTING

DECORATIVE SCONCE LIGHTING

### SHEET NOTES

- SIX (6) PARKING SPACES TO BE PROVIDED OFF-SITE WITHIN 1,000 FEET OF SITE.
   LANDSCAPING AND PLANT SELECTIONS TO FOLLOW BAY-FRIENDLY LANDSCAPE GUIDELINES. SEE LANDSCAPE PLAN, SHEET A1.1 FOR MORE INFORMATION.
- 3. PROJECT TO COMPLY WITH CITY OF ALAMEDA STORMWATER REQUIREMENTS CHECKLIST AND SHALL INCORPORATE PERMANENT STORMWATER DESIGN TECHNIQUES, SOURCE CONTROL MEASURES, AND BEST MANAGEMENT PRACTICES AS INDICATED AND IN ACCORDANCE WITH THE ALAMEDA COUNTY CLEAN WATER PROGRAM'S C3 TECHNICAL GUIDANCE MANUAL.
- 4. ADHERE TO THE CITY F ALAMEDA'S URBAN RUNOFF BEST MANAGEMENT PRACTICES STANDARDS TO PROTECT WATER QUALITY DISCHARGES TO THE MUNICIPAL STORM DRAINAGE SYSTEM DURING CONSTRUCTION. 5. ALL DOWNSPOUTS TO DISCHARGE INTO PERMEABLE
- BELOW SURFACE. 6. SLOPE HARDSCAPE TO DRAIN IN DIRECTION INDICATED ON PLAN. DIRECT PATH OF WATER INTO PERMEABLE AREAS

PERMEABLE AREAS BELOW GRADE AND DISCHARGE

AREAS. DOWNSPOUTS AT PAVED AREAS TO CONNECT TO

- WHEN POSSIBLE. 7. FOLLOW BEST MANAGEMENT PRACTICES (BMPs)
- PROVIDE (N) UNDERGROUND UTILITY HOOK-UP TO SITE. 9. LOCATION OF SECURITY LIGHTS AND CAMERAS TO BE VERIFIED ON SITE WITH INPUT FROM REPRESENTATIVES OF THE ALAMEDA POLICE FORCE AND/OR BUILDING DEPARTMENT.
- 10. LOCATION AND DIRECTION OF ARCHITECTURAL ACCENT LIGHTING TO BE VERIFIED ON SITE. PLACEMENT SHALL BE AT CORNER UNIT ONLY, TO HIGHLIGHT CANTILEVER AND ARCHITECTURAL FEATURES. LIGHT SHALL BE EITHER WALL-WASHING OR DIRECTED DOWNWARD TO MINIMIZE
- LIGHT POLLUTION AND GLARE.

  11. ALL SECURITY GATES TO BE CLOSED AND LOCKED AFTER BUSINESS HOURS. SEE EXTERIOR ELEVATIONS AND 5/A10.0 FOR MORE DETAILS.



419 Merritt Ave, Ste. D Oakland, CA 94610 p 415 200 8106



## Park Esquina

ADDRESS

1926 Park Street Alameda, CA 94501

OWNER

Marcel Sengul Park Esquina, LLC

CURRENT RELEASE DATE October 05, 2015

CURRENT RELEASE SET **DESIGN REVIEW** 

PREVIOUS RELEASE


DATE

SHEET TITLE

### SITE PLAN

SCALE 1/8" = 1'-0" JOB NUMBER DRAWN BY

SITE PLAN

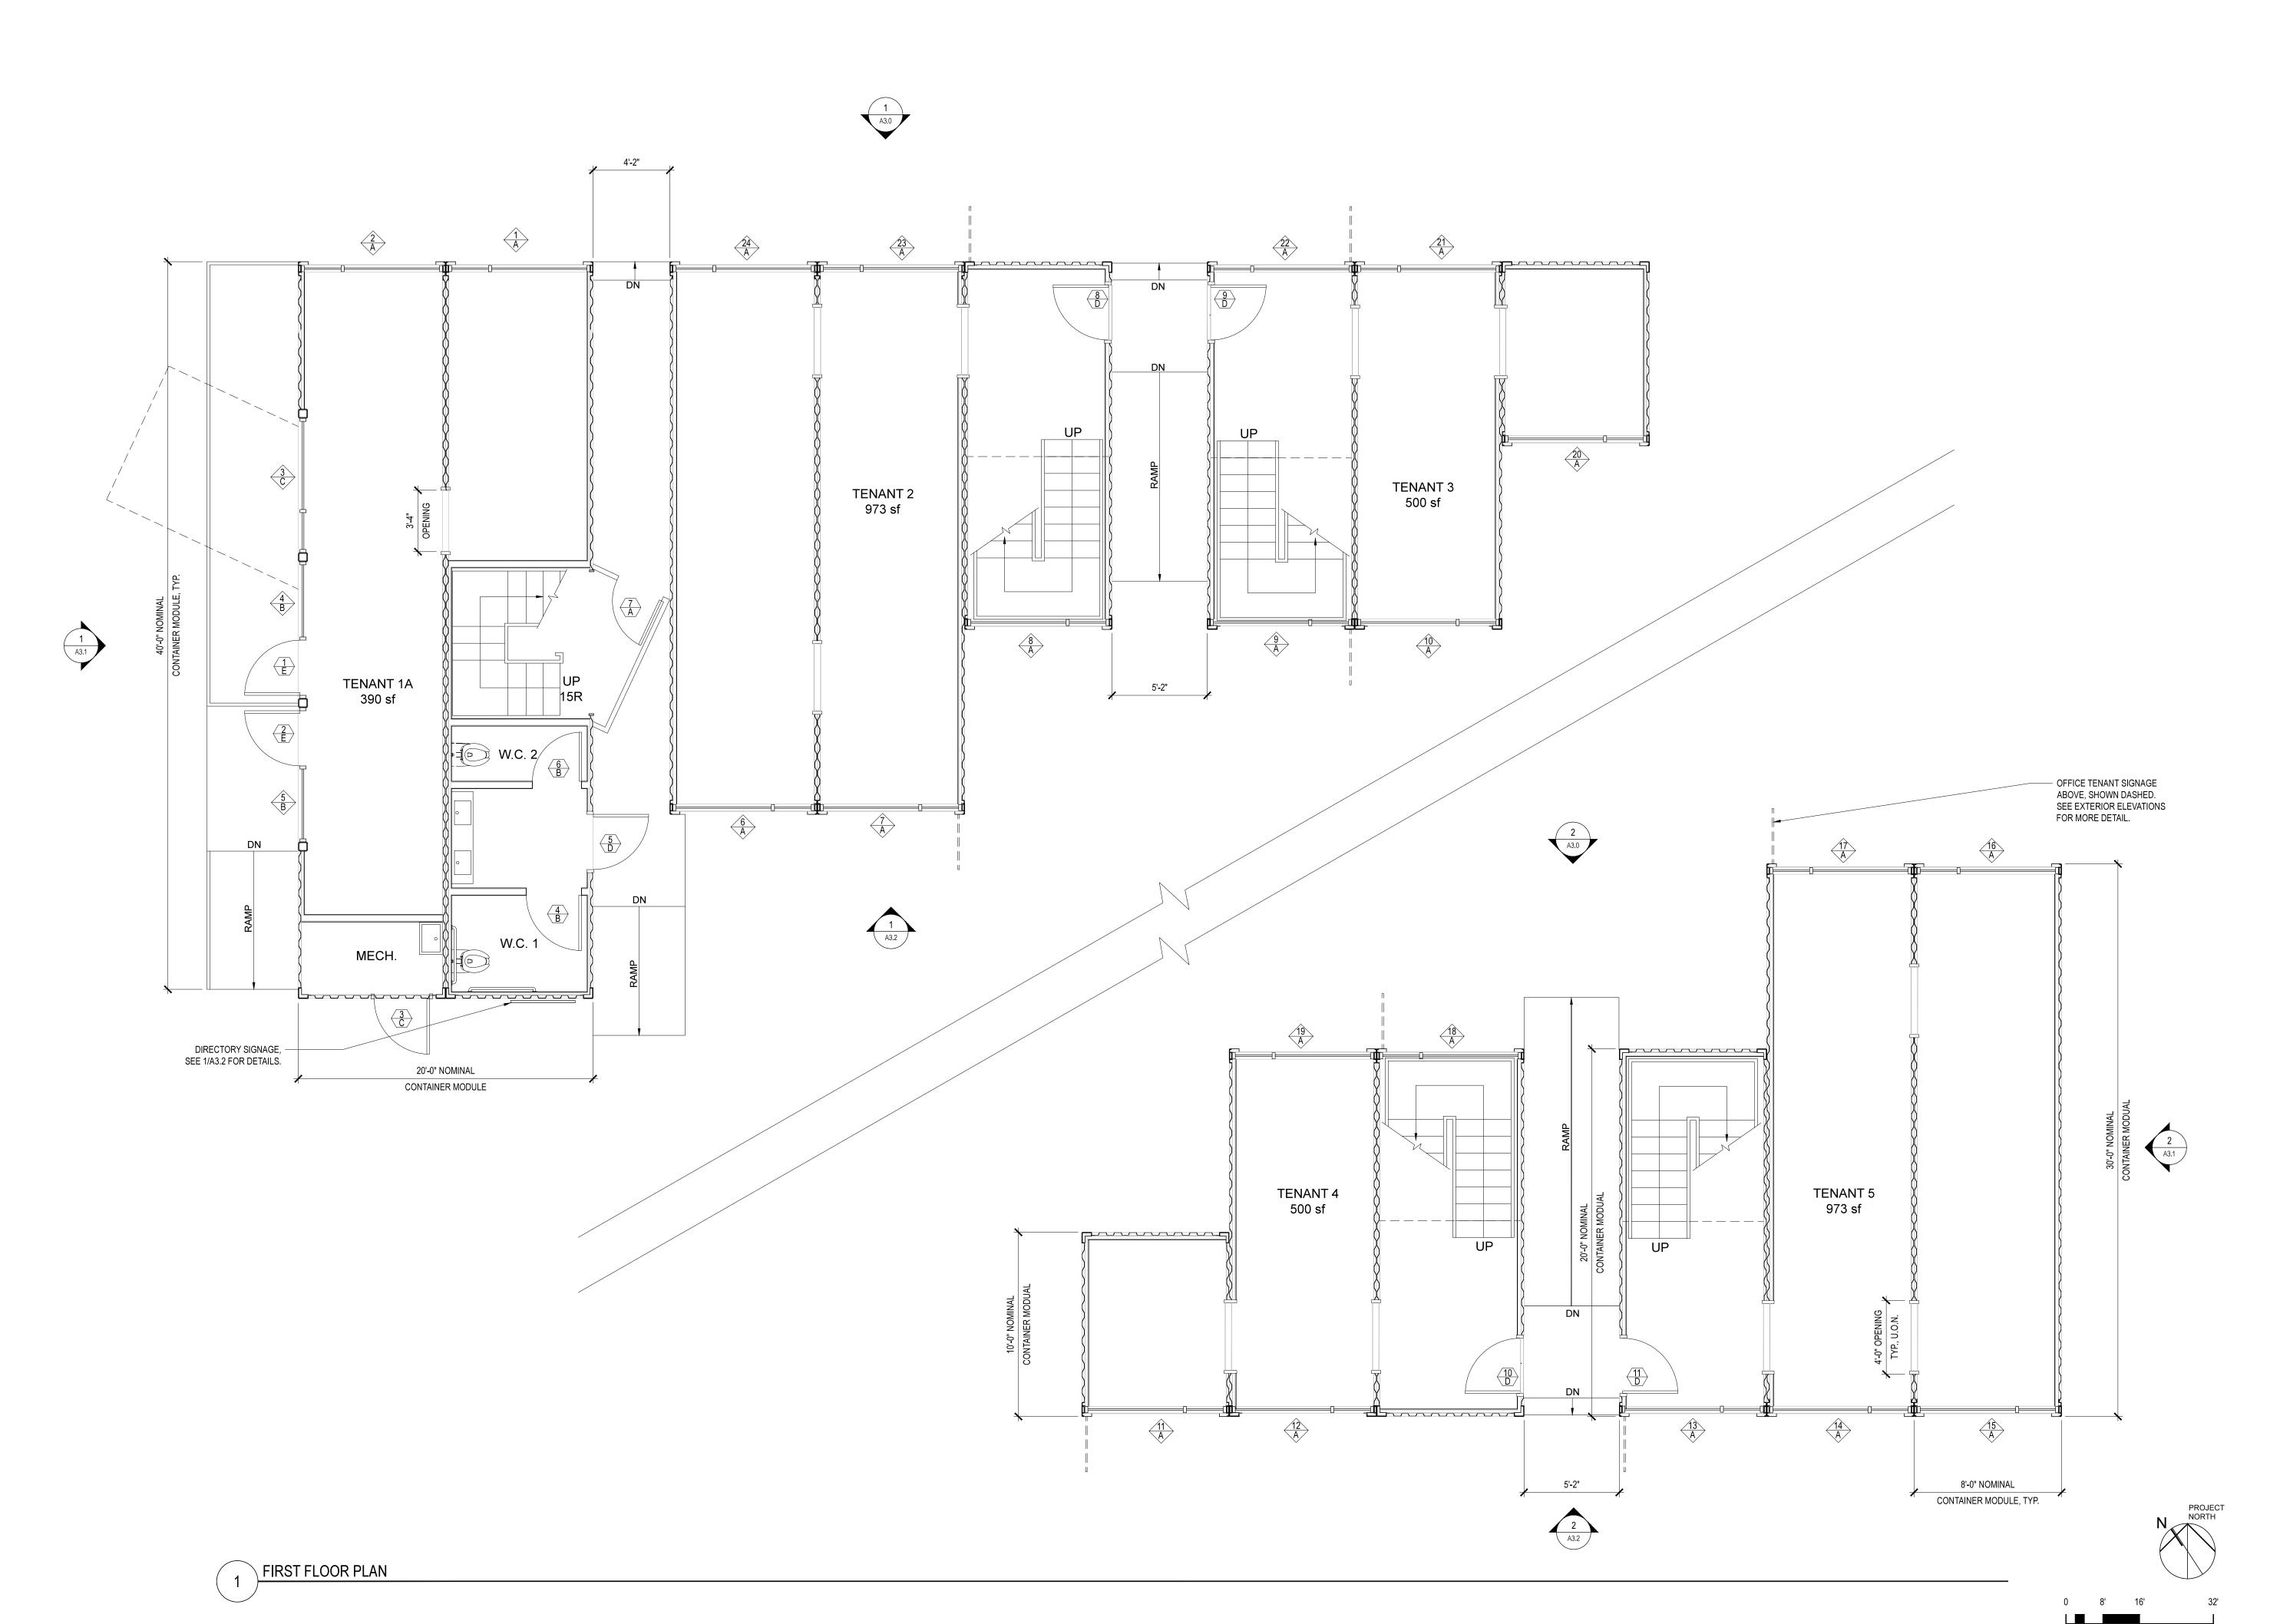





## Park Esquina

ADDRESS 1926 Park Street Alameda, CA 94501

OWNER
Marcel Sengul
Park Esquina, LLC

CURRENT RELEASE DATE
October 05, 2015

## CURRENT RELEASE SET DESIGN REVIEW

PREVIOUS RELEASE
ISSUE

DATE

SHEET TITLE

## FIRST FLOOR PLAN


SCALE
JOB NUMBER
DRAWN BY

14-10 BS

1/4" = 1'-0"

A2.0



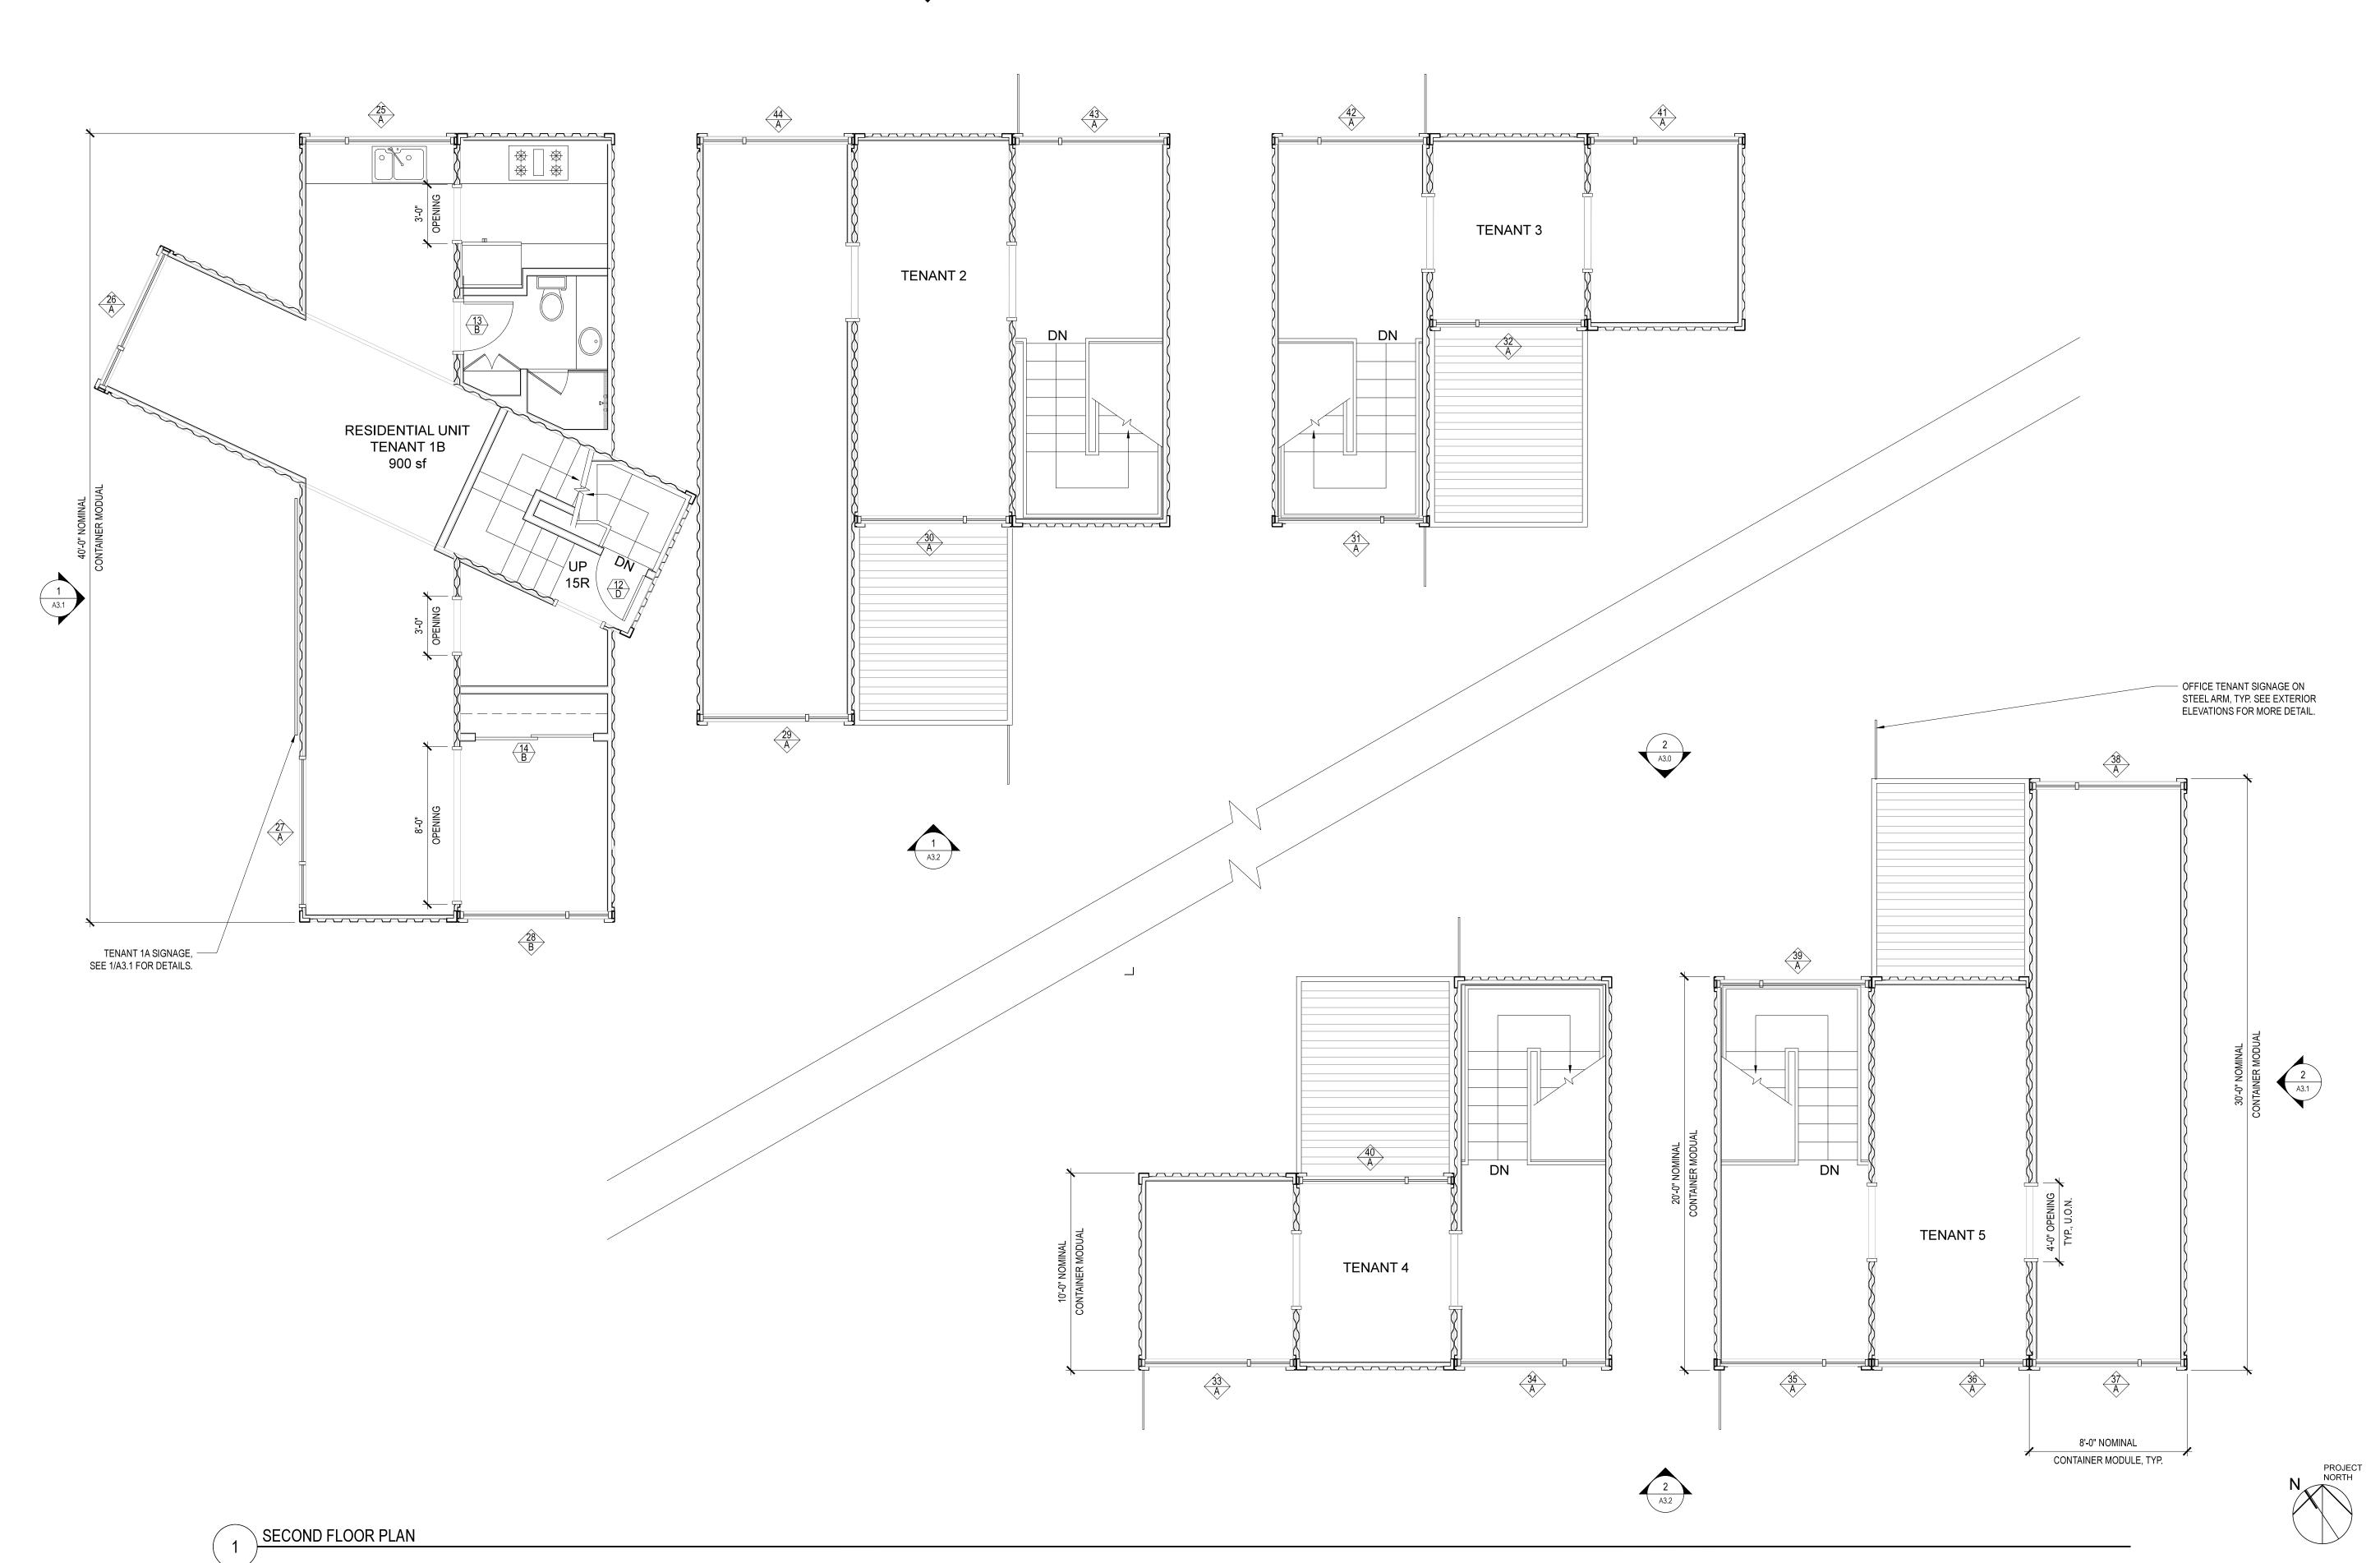





## Park Esquina

ADDRESS 1926 Park Street Alameda, CA 94501

OWNER
Marcel Sengul
Park Esquina, LLC

CURRENT RELEASE DATE
October 05, 2015

## CURRENT RELEASE SET DESIGN REVIEW

PREVIOUS RELEASE

DATE

SHEET TITLE

## SECOND FLOOR PLAN

SCALE


JOB NUMBER

DRAWN BY

BS

1/4" = 1'-0"

A2.1

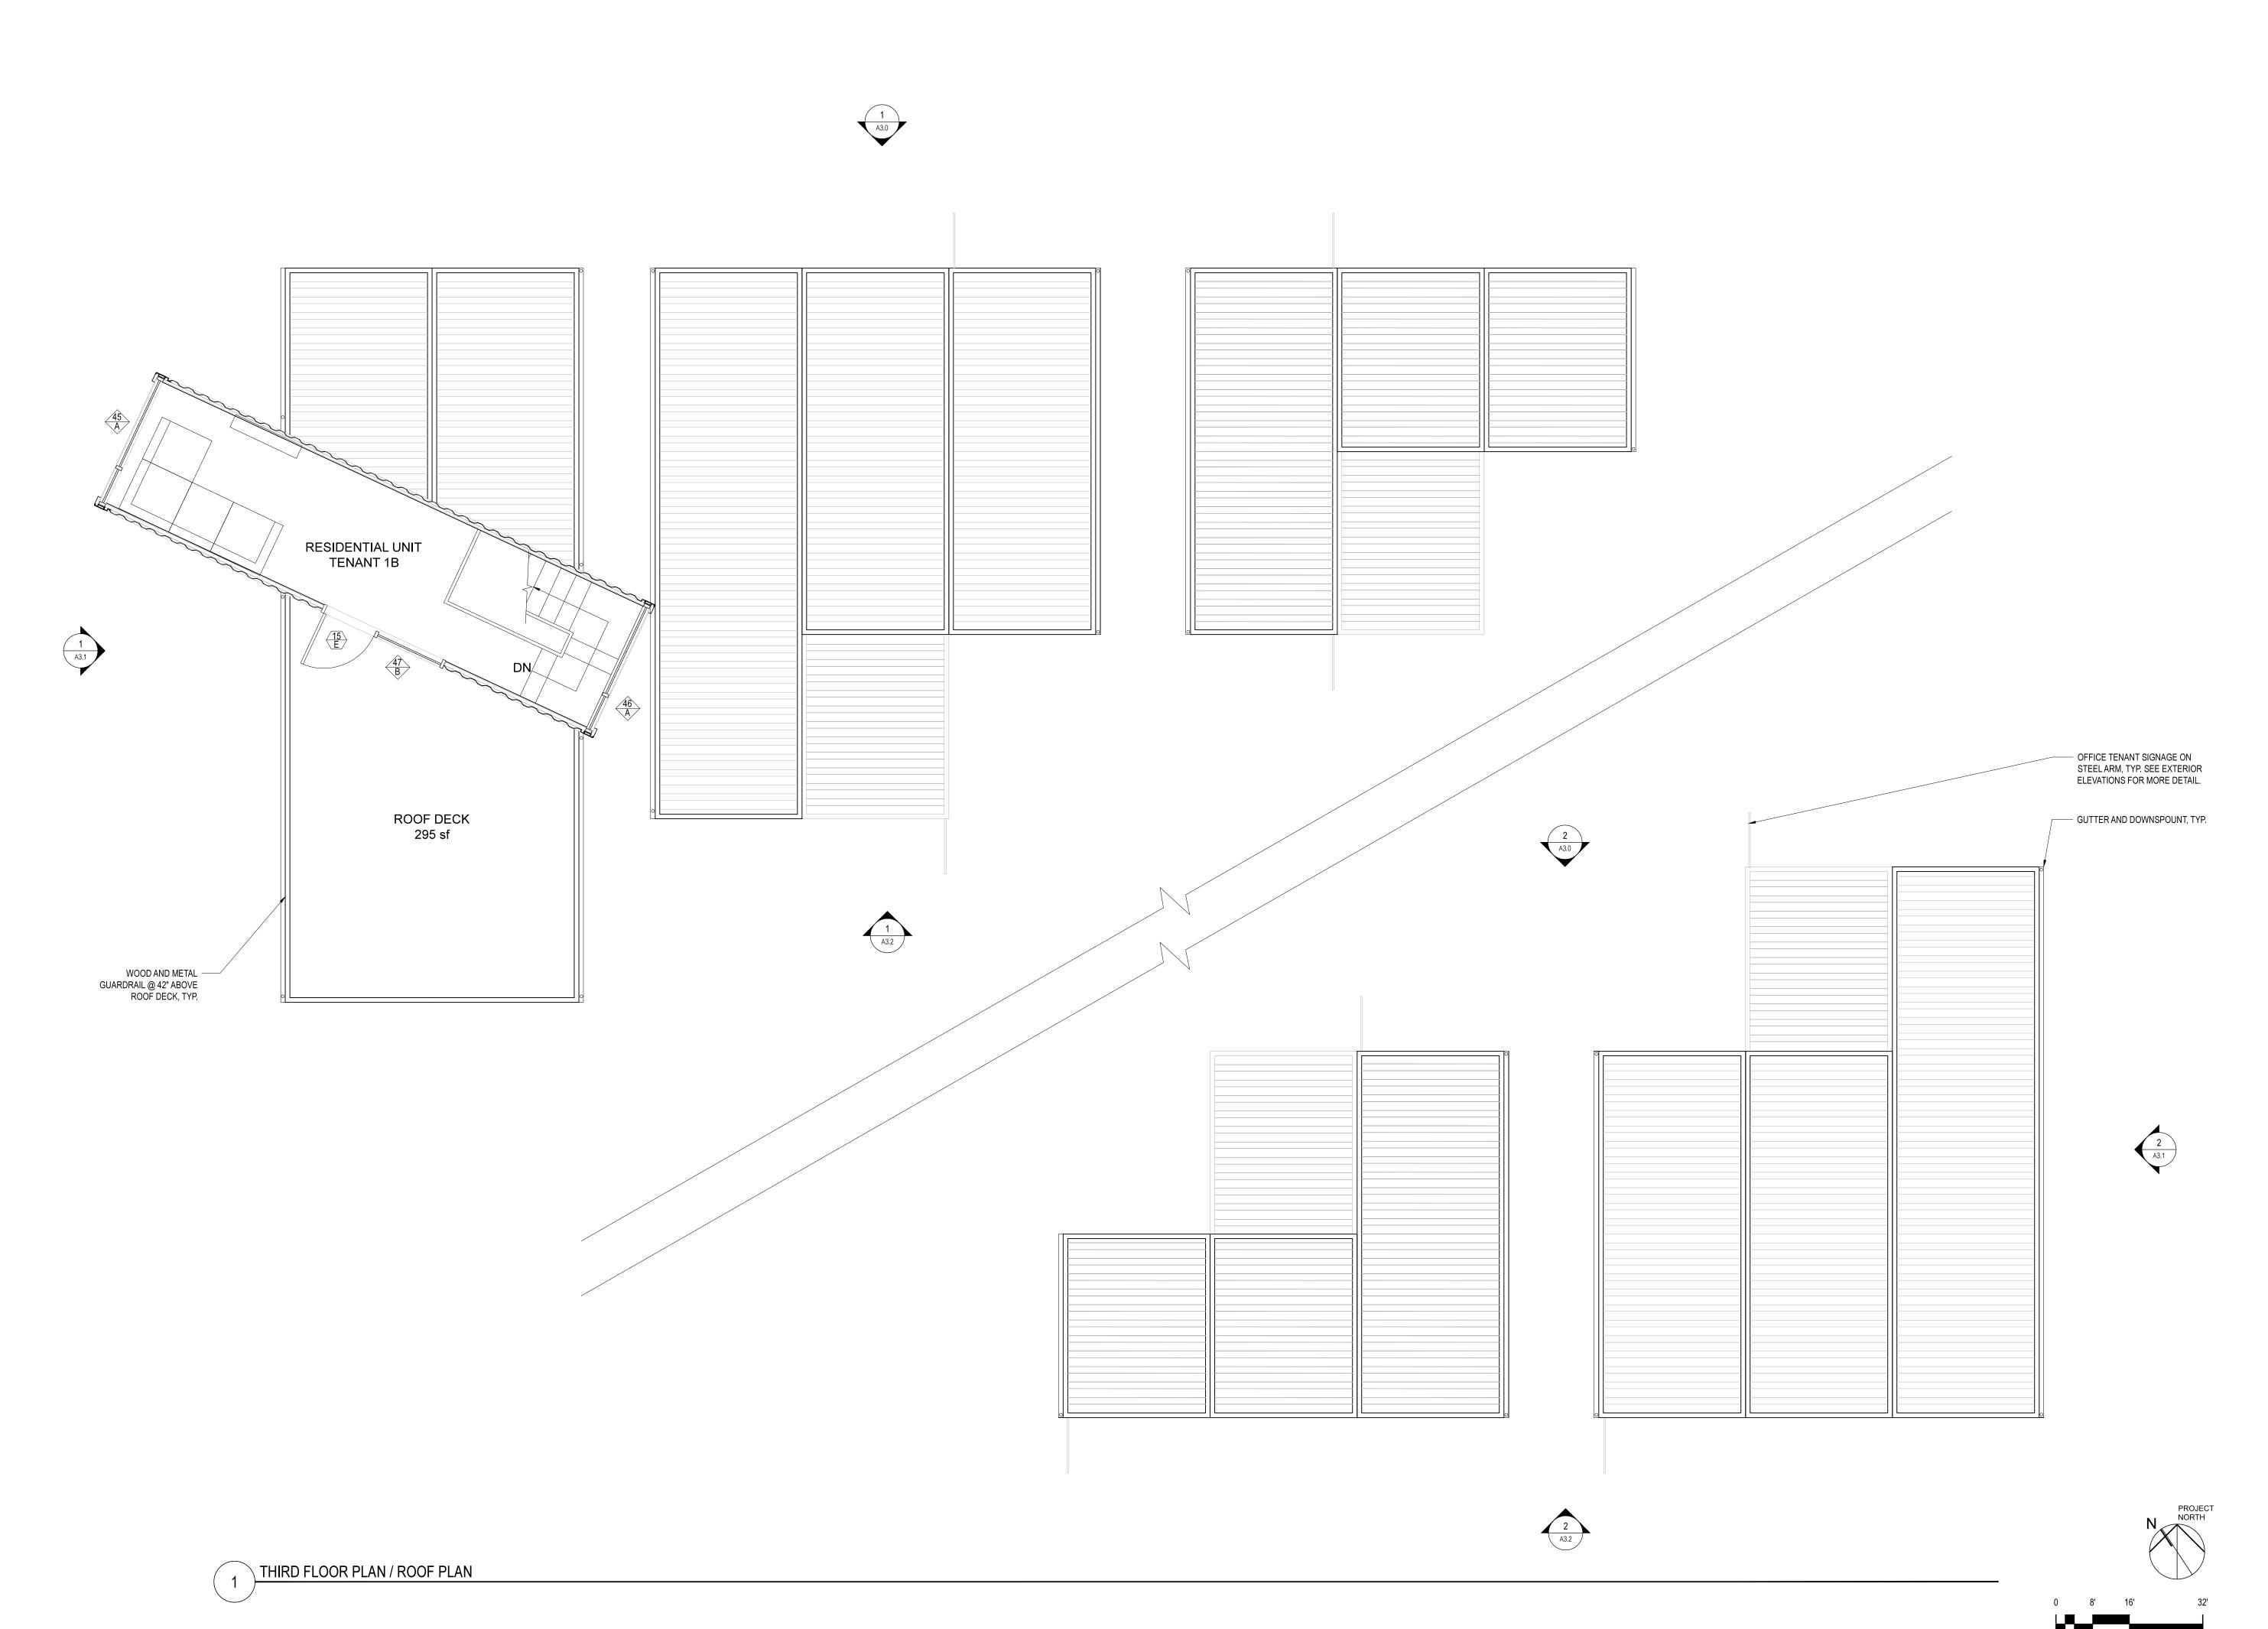





## Park Esquina

ADDRESS 1926 Park Street Alameda, CA 94501

OWNER

Marcel Sengul

Park Esquina, LLC

CURRENT RELEASE DATE
October 05, 2015

CURRENT RELEASE SET

DESIGN REVIEW

PREVIOUS RELEASE
ISSUE DATE

SHEET TITLE

## THIRD FLOOR / ROOF PLAN


SCALE

JOB NUMBER


DRAWN BY

1/4" = 1'-0" 14-10

A2.2

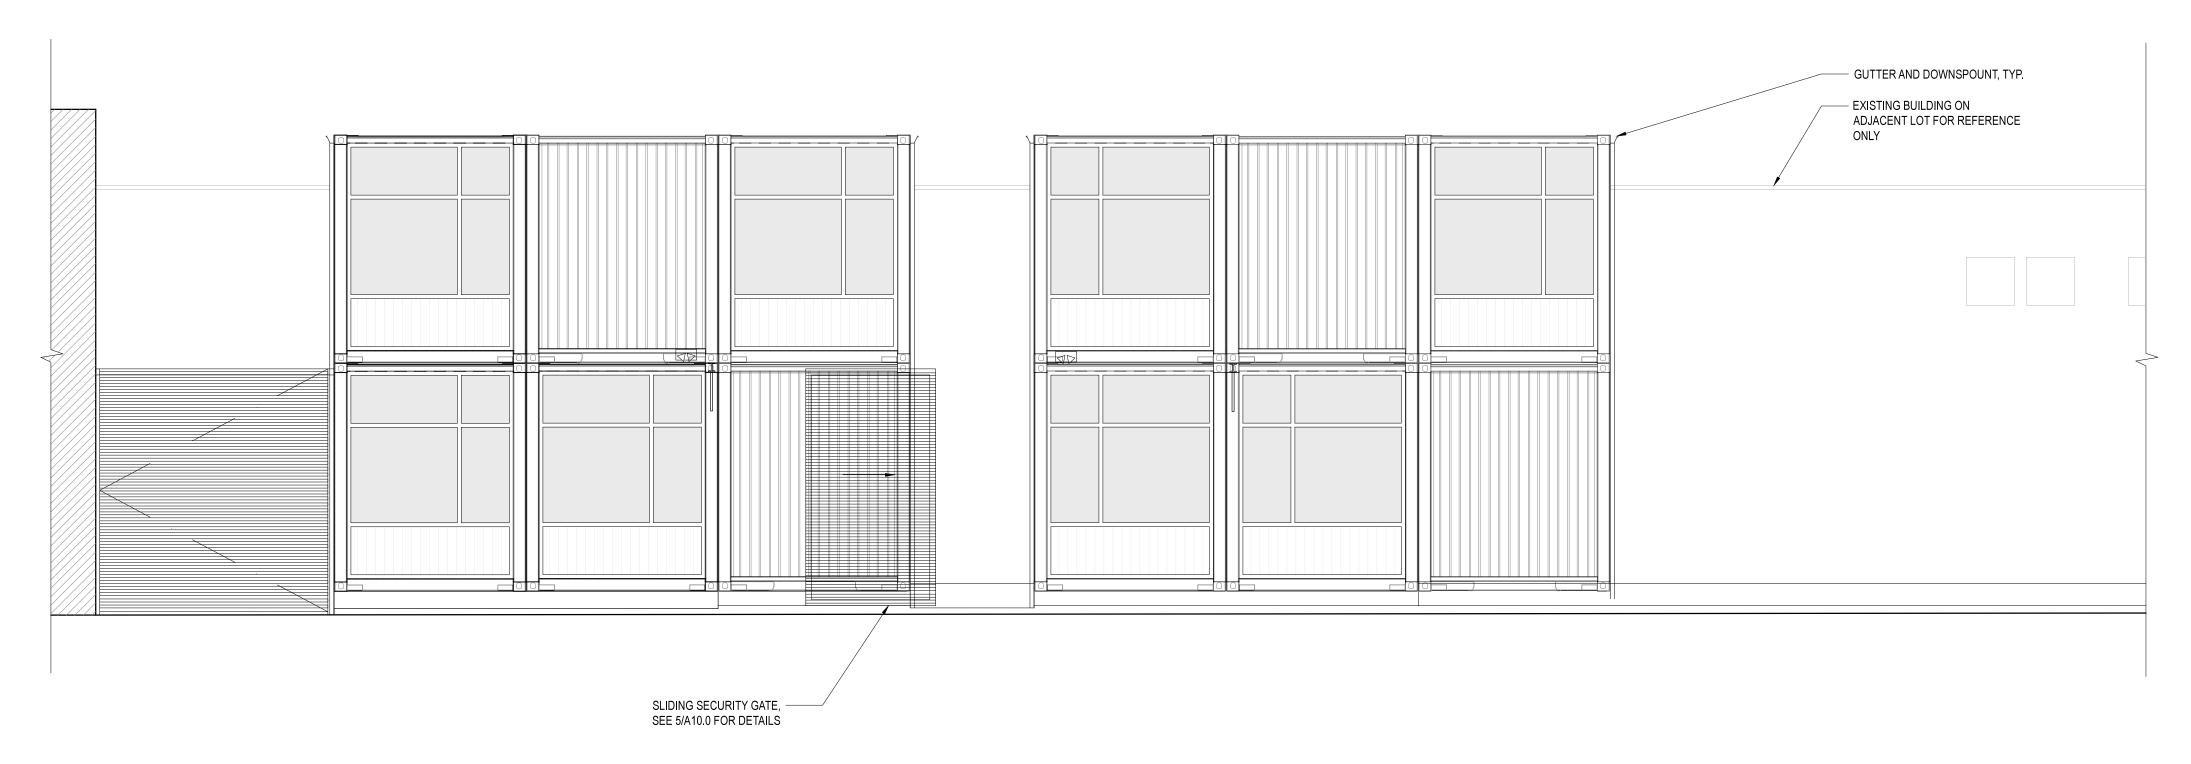

NORTH ELEVATION CONTINUED (SET BACK FROM BLANDING AVENUE)

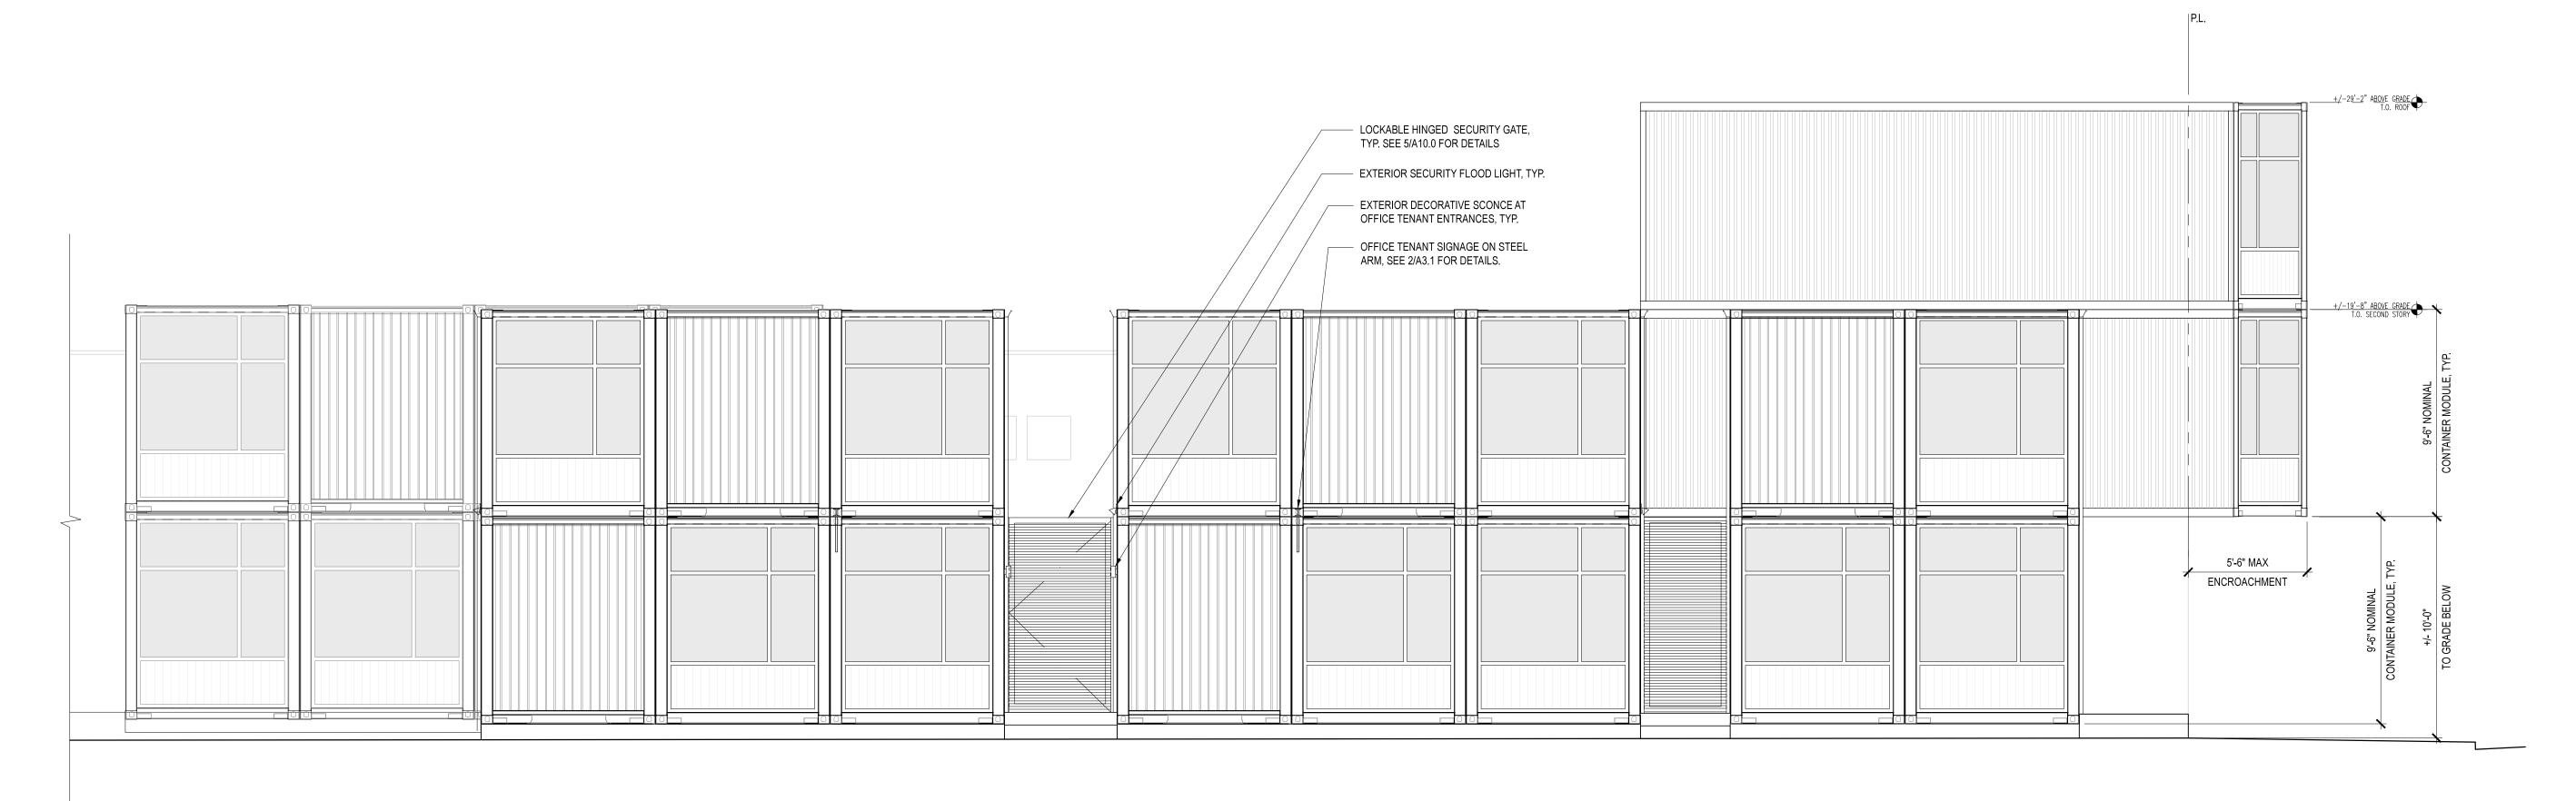

NORTH ELEVATION (FROM BLANDING AVENUE)





## Park Esquina

ADDRESS 1926 Park Street Alameda, CA 94501

OWNER

Marcel Sengul Park Esquina, LLC

October 05, 2015

CURRENT RELEASE SET

DESIGN REVIEW

PREVIOUS RELEASE
ISSUE

DATE

SHEET TITLE


## EXTERIOR ELEVATIONS

SCALE
JOB NUMBER


DRAWN BY

1/4" = 1'-0" 14-10

A3.0

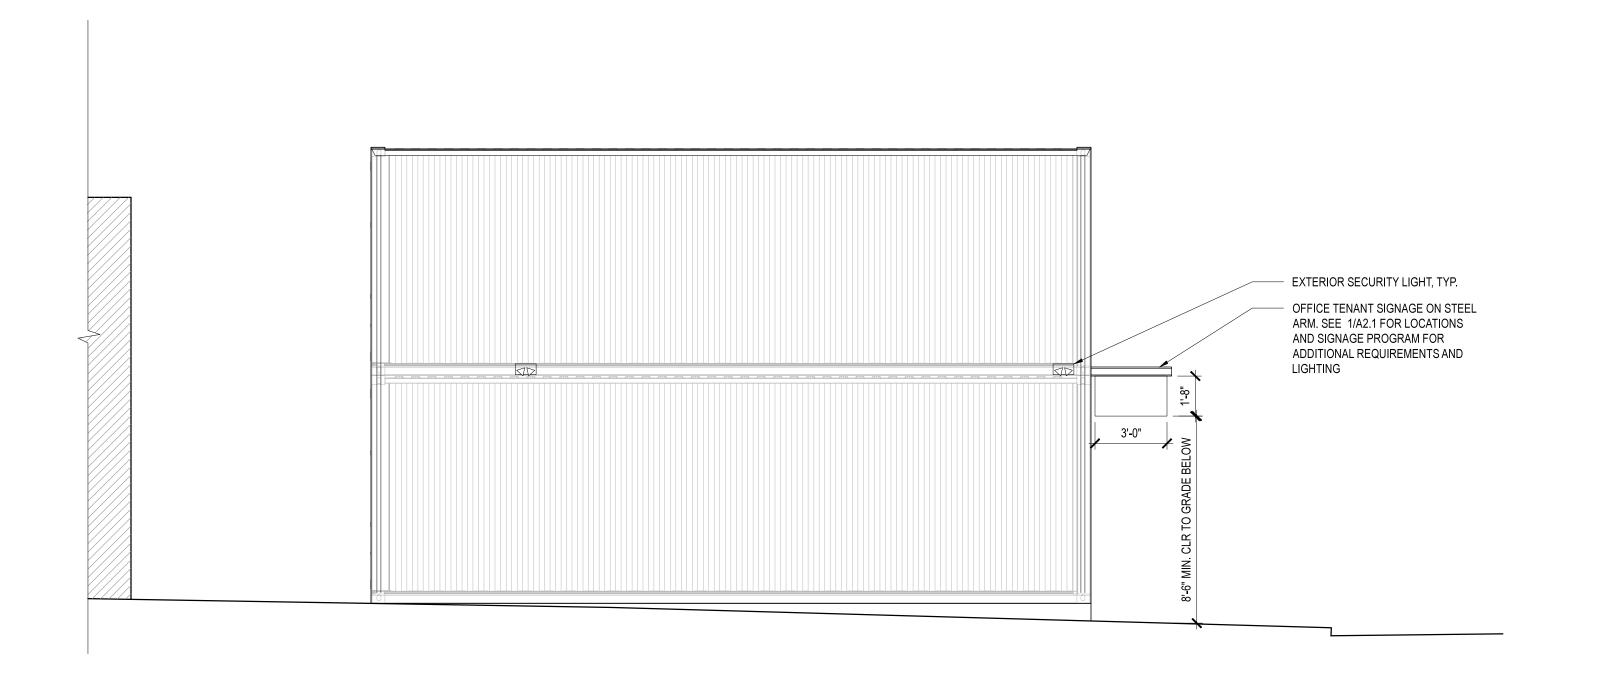

2 EAST ELEVATION

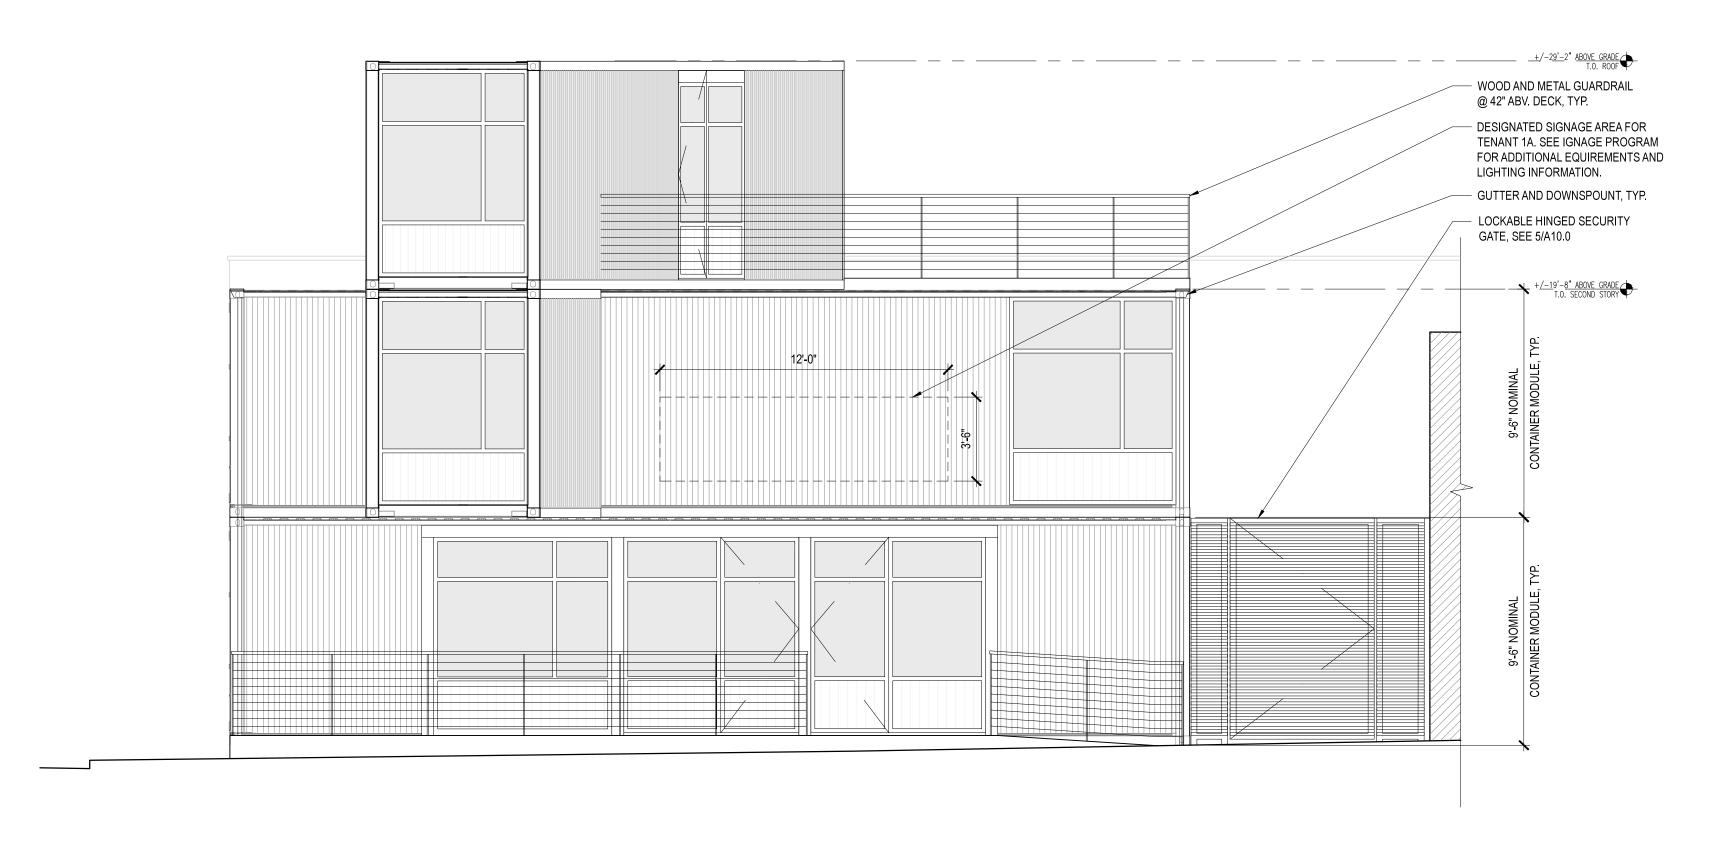

WEST ELEVATION (FROM PARK STREET)





## Park Esquina

ADDRESS 1926 Park Street Alameda, CA 94501

OWNER

Marcel Sengul Park Esquina, LLC

CURRENT RELEASE DATE
October 05, 2015

CURRENT RELEASE SET

DESIGN REVIEW

PREVIOUS RELEASE
ISSUE

DATE

SHEET TITLE

## EXTERIOR ELEVATIONS

SCALE


JOB NUMBER

DRAWN BY


≺ 14-10 BS

1/4" = 1'-0"

A3.1

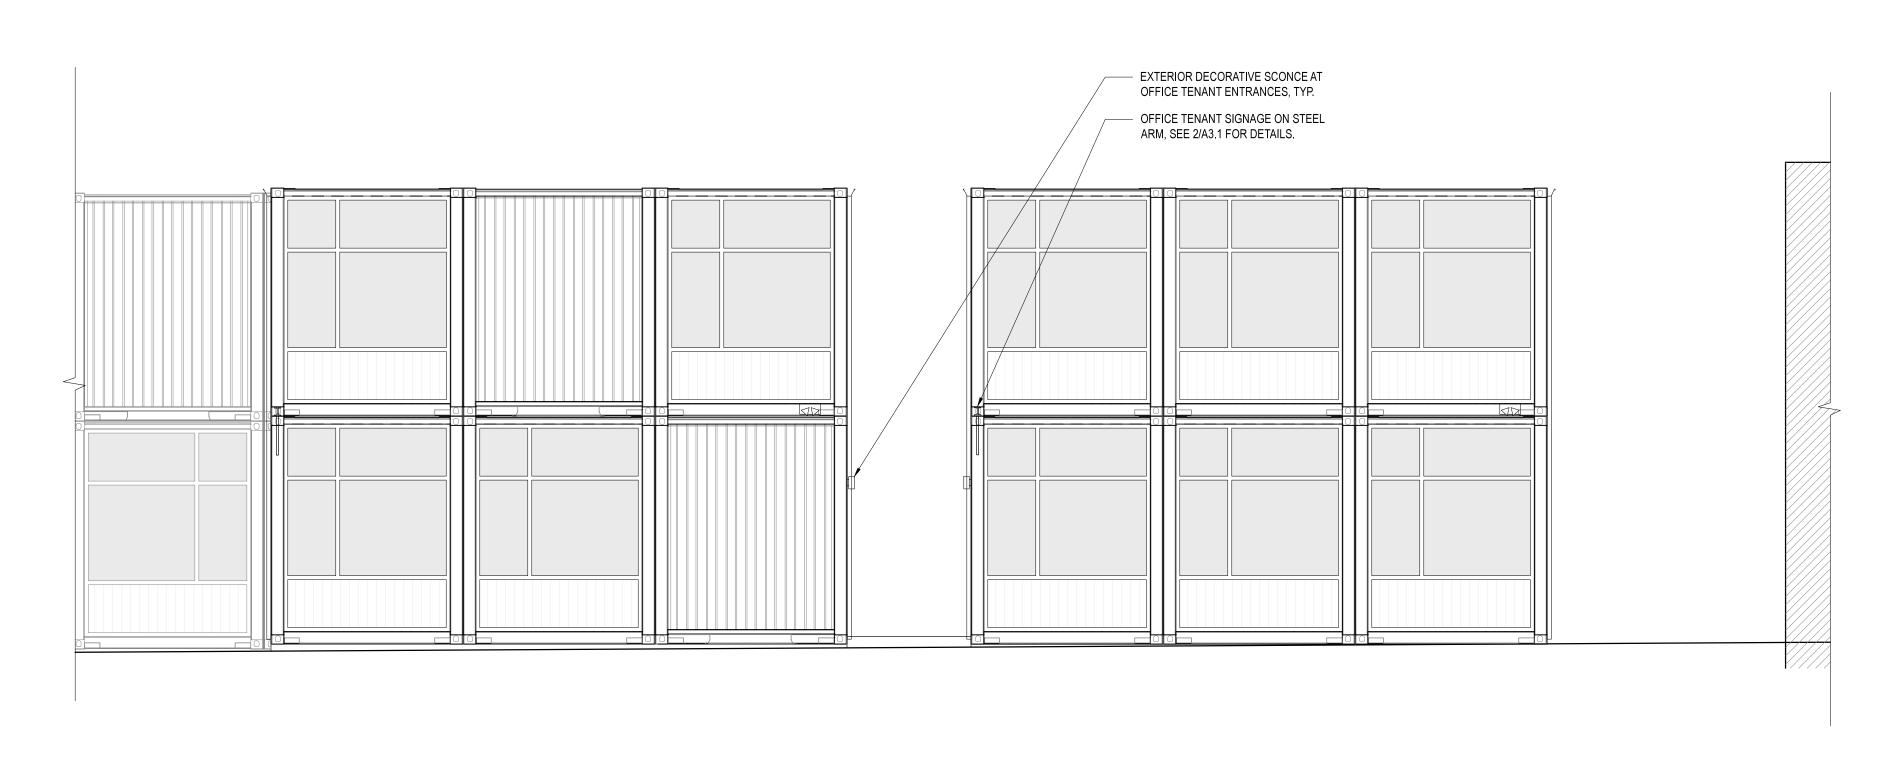

SOUTH ELEVATION CONTINUED

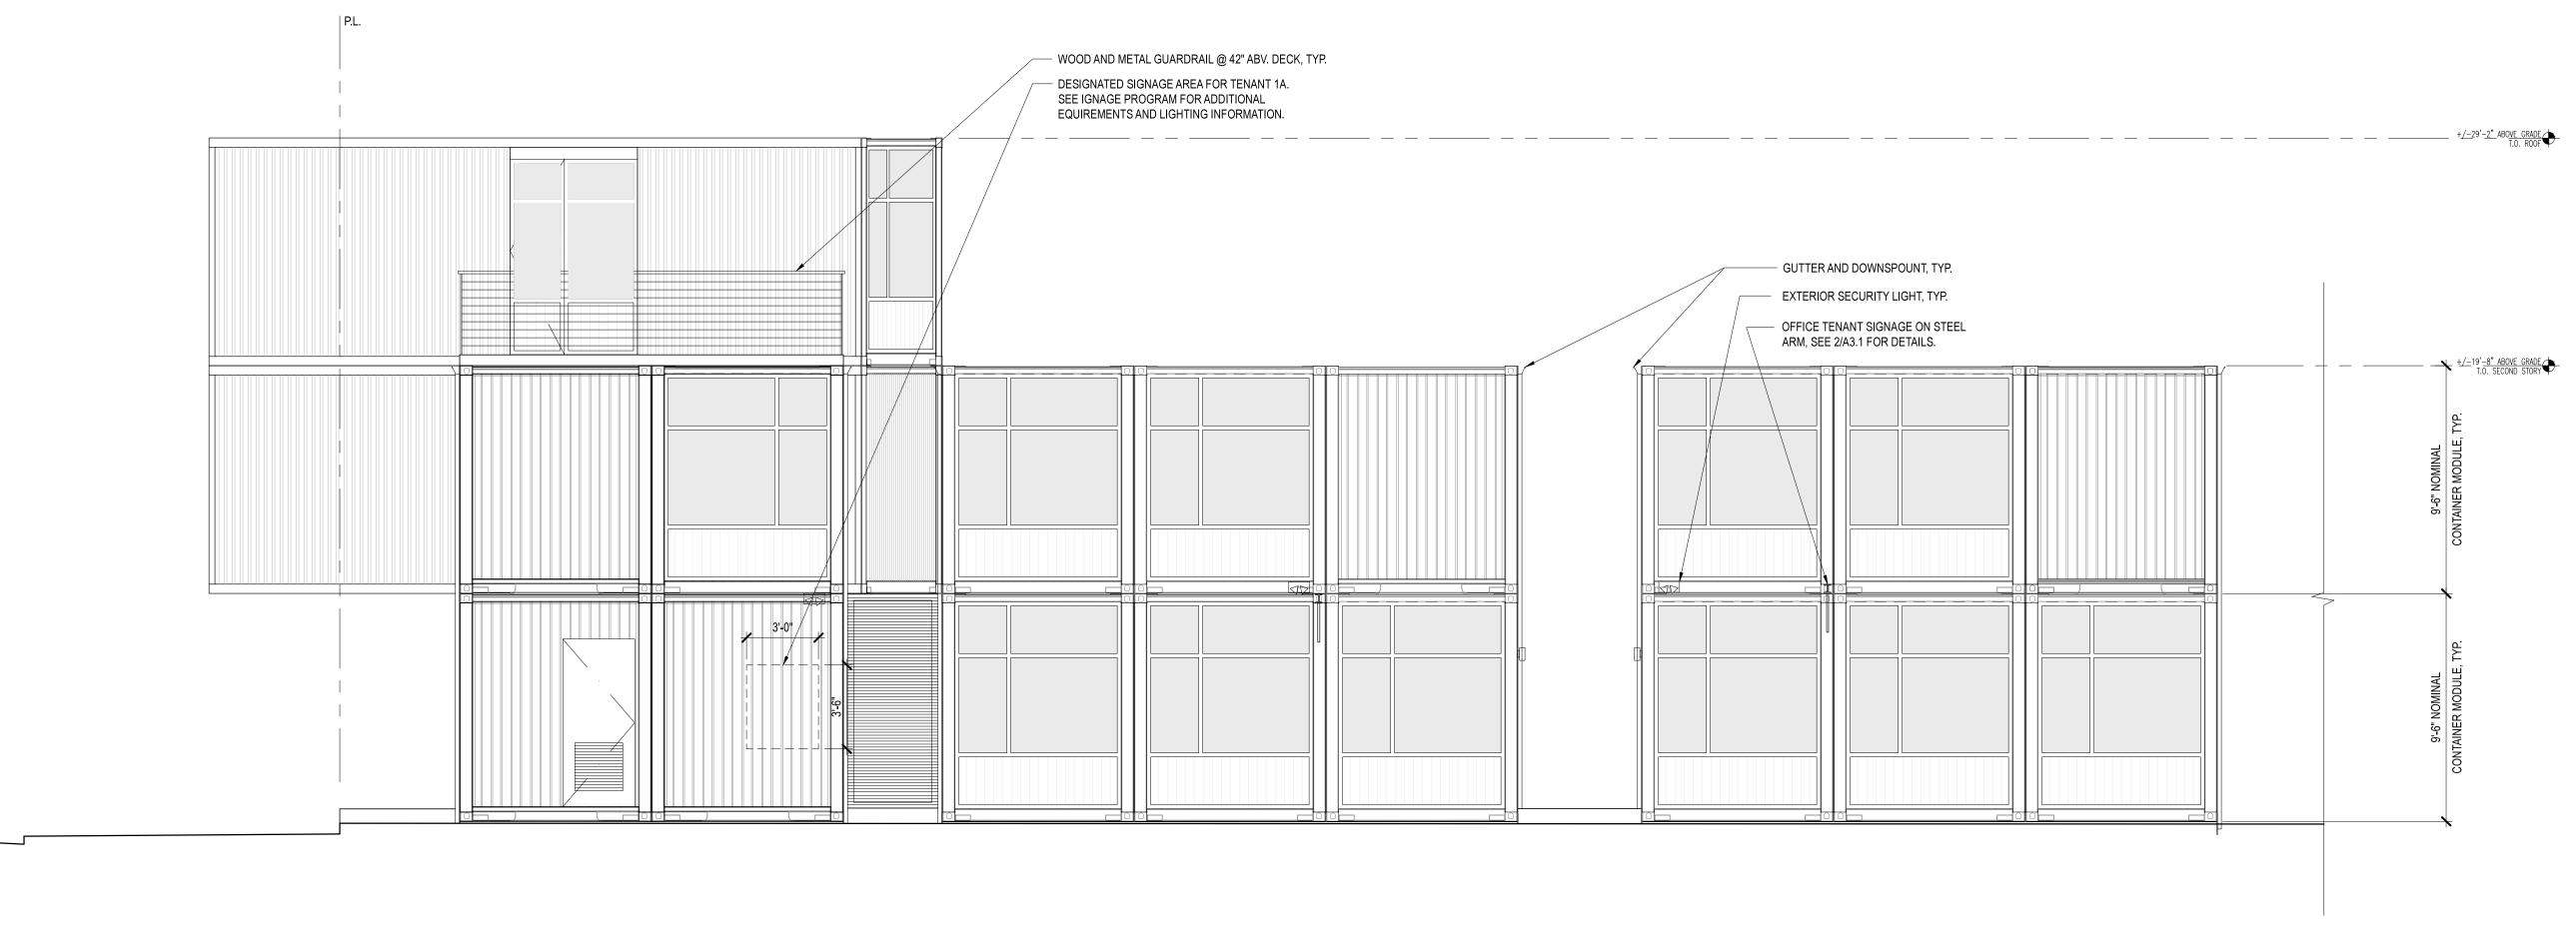

SOUTH ELEVATION (FROM COURTYARD)





## Park Esquina

ADDRESS 1926 Park Street Alameda, CA 94501

OWNE

Marcel Sengul Park Esquina, LLC

October 05, 2015

CURRENT RELEASE SET

DESIGN REVIEW

PREVIOUS RELEASE

SHEET TITLE

## EXTERIOR ELEVATIONS

SCALE


JOB NUMBER

DRAWN BY

1/4" = 1'-0" 14-10


DATE

A3.2

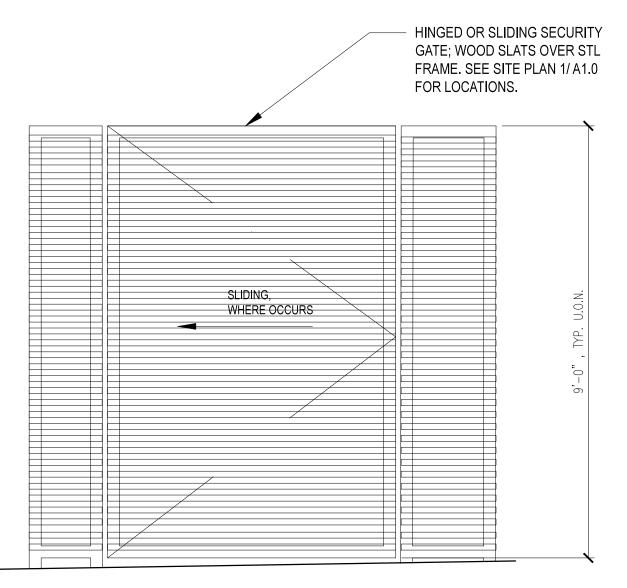

SECURITY GATE ELEVATION DETAIL


1/2" = 1'-0"

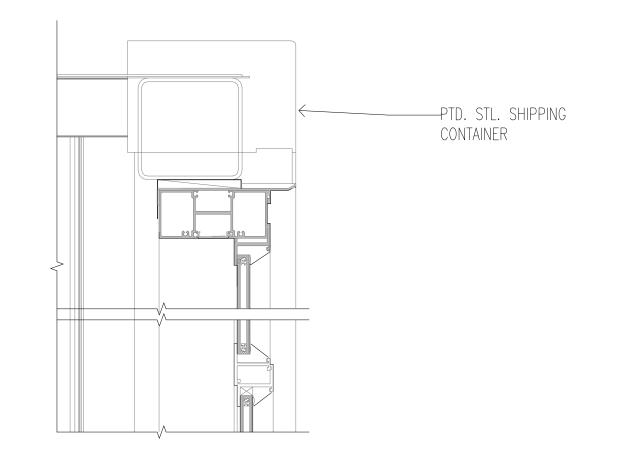

## 4 STOREFRONT WINDOW HEAD DETAIL

3" = 1'-0"

3" = 1'-0"

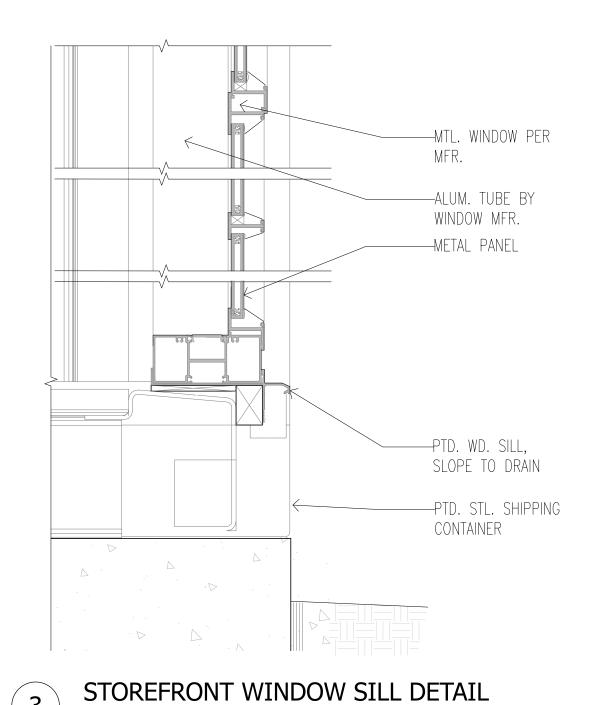

NO.	QTY.	AREA	DOOR OPENING		TYPE	CORE	DOOR HRDWR	REMARKS	
			WIDTH	HEIGHT					
01	1	STOREFRONT	3'-0"	8'-1 3/4"	Е	GL	EX	TEMPERED GLAZING	
02	1	STOREFRONT	3'-0"	8'-1 3/4"	Е	GL	EX	TEMPERED GLAZING	
03	1	MECHANICAL	3'-0"	7'-0"	С	SC	EX		
04	1	BATHROOM 1	3'-0"	7'-0"	В	SC	DB		
05	1	BATHROOM VEST.	3'-0"	7'-0"	D	SC	EX		
06	1	BATHROOM 2	3'-0"	7'-0"	В	SC	DB		
07	1	TENANT 1B - GATE	3'-0"	7'-0"	D	FR	EX		
08	1	UNIT 2	3'-0"	7'-0"	D	GL	EX	TEMPERED GLAZING	
09	1	UNIT 3	3'-0"	7'-0"	D	GL	EX	TEMPERED GLAZING	
10	1	UNIT 4	3'-0"	7'-0"	D	GL	EX	TEMPERED GLAZING	
11	1	UNIT 5	3'-0"	7'-0"	D	GL	EX	TEMPERED GLAZING	
12	1	STAIR - SECOND FL	3'-0"	7'-0"	D	GL	PR		
13	1	BATHROOM	2'-6"	6'-8"	В	SC	PR		
14	1	CLOSET	3'-0"	6'-8"	В	SC	CL	PAIR, SLIDING CLOSET DOORS	
15	1	ROOF DECK	3'-0"	8'-1 3/4"	Е	GL	EX	TEMPERED GLAZING	
	<u>l</u> DR	HARDWARE TYPES:	PR	= PASSAG = PRIVAC` = CLOSET	1			PO = POCKET DOOR HARDWARE w/ LOCK PL = PULL/PUSH PLATE ONLY EX = EXTERIOR: EXTERIOR LOCK w/ DEAD BOLT	


CONTRACTOR TO VERIFY ALL ROUGH OPENINGS AND JAMB THICKNESS BEFORE FINALIZING DOOR ORDER.
 TEMPERED OR SAFETY GLASS IS REQUIRED IN THE FOLLOWING HAZARDOUS LOCATIONS:

 A. GLAZING IN OPERABLE DOORS ADJACENT FIXED LITES.


 ALL FIRE RATED DOORS TO HAVE SELF—CLOSER AND SMOKE GASKET PER NFPA 252 OR UL 10C.
 FINISHED FLOOR ELEVATION DROP OVER DOOR THRESHOLD SHALL NOT EXCEED <sup>1</sup>/<sub>2</sub>".

GL = GLASS FR = MTL FRAME w/WOOD SLATS

DOOR CONSTRUCTION: SC = SOLID CORE SR = STILES & RAILS

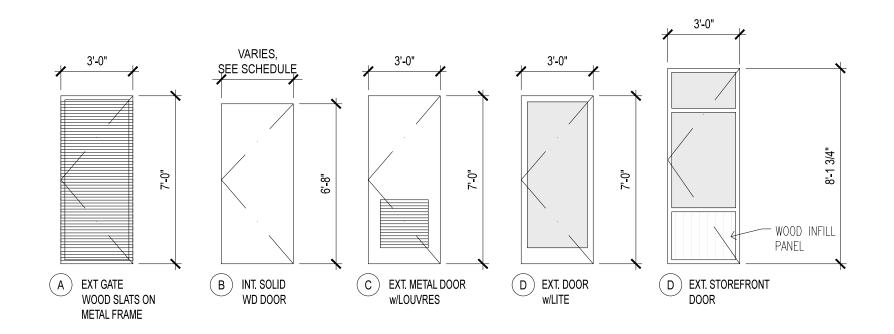

2 DOOR ELEVATIONS

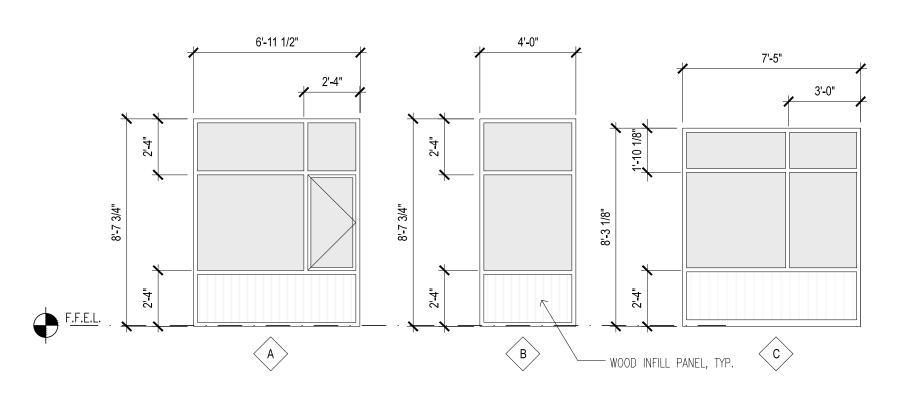

WINDOW ELEVATIONS

MARK	QNTY.	ROUGH OPENING			WINDOW TYPE	GLASS TYPE	REMARKS:
		WIDTH	HEIGHT	SILL HT.	1112	1111 =	
01	1	*	*	*	FX w/ CS		
02	1	*	*	*	FX w/ CS		
03	1	*	*	*	FX w/ CS		
04	1	*	*	*	FX		
05	1	*	*	*	FX		
06	1	*	*	*	FX w/ CS		
07	1	*	*	*	FX w/ CS		
01	1	*	*	*	FX w/ CS		
08	1	*	*	*	FX w/ CS		
09	1	*	*	*	FX w/ CS		
10	1	*	*	*	FX w/ CS		
11	1	*	*	*	FX w/ CS		
12	1	*	*	*	FX w/ CS		
13	1	*	*	*	FX w/ CS		
14	1	*	*	*	FX w/ CS		
15	1	*	*	*	FX w/ CS		
16	1	*	*	*	FX w/ CS		
17	1	*	*	*	FX w/ CS		
18	1	*	*	*	FX w/ CS		
19	1	*	*	*	FX w/ CS		
20	1	*	*	*	FX w/ CS		
21	1	*	*	*	FX w/ CS		
22	1	*	*	*	FX w/ CS		
23	1	*	*	*	FX w/ CS		
24	1	*	*	*	FX w/ CS		
25	1	*	*	*	FX w/ CS		
25 26	1	*	*	*	FX w/ CS		
27	1	*	*	*	FX w/ CS		
	1	*	*	*	FX w/ CS		OPERABLE CASEMENT MEETS EMERGENCY ESCAPE
28	1	*	*	*	FX w/ CS		OPENING, CBC SEC. 1029, w/MIN. DIMENSIONS & CLR
29	1	*	*	*	FX w/ CS		
30	1	*	*	*	FX w/ CS		
31	1	*	*	*	FX w/ CS		
32		*	*	*	FX w/ CS		
33	1	*	*	*	FX w/ CS		
34	1	*	*	*	FX w/ CS		
35	1	*	*	*	FX w/ CS		
36	1	*	*	*	FX w/ CS		
37	1	*	*	*	FX w/ CS		
38	1	*	*	*			
39	1	*	*	*	FX w/ CS		
40	1				FX w/ CS		
41	1	*	*	*	FX w/ CS		
42	1	*	*	*	FX w/ CS		
43	1	*	*	*	FX w/ CS		
44	1	*	*	*	FX w/ CS		
45	1	*	*	*	FX w/ CS		
46	1	*	*	*	FX w/ CS		
47	1	*	*	*	FX		
WIN[			S		7		EMPERED SB =SAND BLASTED DUBLE GLAZED S = SINGLE GLAZED

#### \* SEE ELEVATIONS ON THIS SHEET FOR FRAME DIMENSIONS.

NOTES:

1. ALL WINDOWS TO SHALL CONFORM TO FENESTRATION SPECIFICATION SET FORTH IN TITLE—24 CALCULATIONS.
2. CONTRACTOR TO VERIFY ALL ROUGH OPENINGS AND JAMB THICKNESS BEFORE FINALIZING WINDOW ORDER.
3. ALL WINDOWS TO BE DARK ANODIZED ALUMINUM W/FACTORY FINISH.
4. ALL WINDOWS TO BE LOW—E, DOUBLE GLAZED WITH A MAXIMUM U—VALUE OF 0.4
5. TEMPERED OR SAFETY GLASS IS REQUIRED IN THE FOLLOWING HAZARDOUS LOCATIONS:

A. GLAZING ADJACENT TO DOORS AND GLAZING IN FIXED PANELS ADJACENT TO WALKING SURFACES MUST BE OF SAFETY GLAZING MATERIALS

B. PROVIDE SAFETY GLASS AT WINDOWS IN SHOWER/BATHTUB ENCLOSURE WITHIN 60" OF DRAIN INLET.

TIMBRE
ARCHITECTURE

419 Merritt Ave, Ste. D
Oakland, CA 94610



p 415 200 8106

Park Esquina

ADDRESS 1926 Park Street Alameda, CA 94501

OWNED

OWNER

Marcel Sengul

Park Esquina, LLC

CURRENT RELEASE DATE
October 05, 2015

CURRENT RELEASE SET

DESIGN REVIEW

PREVIOUS RELEASE

DATE

SHEET TITLE

# WINDOW AND DOOR SCHEDULES

SCALE NTS

JOB NUMBER 14-10

DRAWN BY BS

A10.0