LOCATION MAP

ABBREVIATIONS

ASPHALT CONCRETE PAVING EMER

AIR CONDITIONING

ABOVE FINISH FLOOR

ACOUSTICAL

ADJUSTABLE

OF ARCHITECTS

ACCESS PANEL

ASSOCIATION

APPROXIMATE

ARCHITECTURAL

AMERICAN SOCIETY OF

TESTING & MATERIALS

BOTTOM OF CURB

BOTTOM OF SLOPE

COLD AIR RETURN

CONSTRUCTION JOINT

CONCRETE MASONRY UNIT

CHAIN LINK FENCE

CATCH BASIN

BITUMINOUS

BUILDING

BLOCKING

BEAM

BOTTOM

BUBBLER

CABINET

CALIPER

CEMENT

CERAMIC

CUBIC FEET

CAST IRON

CENTER LINE

CEILING

CLOSET

CLFAR

CAULKING

CHAIN LINK

CLEANOUT

COMPOSITION

CONNECTION

CONCRETE

CONDITION

COLUMN

BITUM

BLKG

ВМ

BOT

CAB

CEM

CER

CJ

CLG

CLO

CLR

CNTR

CO

COL

COMP

CONC

COND

CONN

CONST

CLKG

ENGINEERED WOOL

ALUMINUM



EMERGENCY

ENCLOSURE

ENTRANCE

EQUIPMENT

EXISTING

EXPOSED

EXTERIOR

FLAT BAR

FORCED AIR UNIT

FLOOR DRAIN

FIRE EXT. CABINE

FINISHED FLOOR

FIRE HYDRANT. FLAT

FIRE HOSE CABINET

FIBER GLASS

FLUORESCENT

FLUSH HANDLE

FACE OF CONCRETE

FACE OF STRUCTURE

FACE OF FINISH

FACE OF STUDS

FIRE RESISTANT

FOOT OR FEET

GLOSS (PAINT)

FULL SIZE

FOOTING

FURRING

FUTURE

GAUGE

GALLON

GRADE

GLASS

GROUND

GYPSUM

HOSE BIBB

HANDICAP

HARDWARE

HORIZONTAL

HIGH POINT

HOLLOW METAL

AIR CONDITIONING

INSIDE DIAMETER

INVERT ELEVATION

LANDSCAPE ARCHITECT

HEAD

HOUR

HEIGHT

HEATER

INCHES

INSULATION

INTERIOR

JOINT(S)

LAMINATE

GALVANIZED

GENERAL CONTRACTOR

GYPSUM WALL BOARD

HOT & COLD SUPPLY

GENERAL SERVICES AGENCYPNT

HEATING, VENTILATION AND R.A.

GALVANIZED IRON

FLOOR

FOUNDATION

FURNISHED BY OWNER

EXPANSION

EACH WAY EACH FACE

ENCL

EQPT

EXTG

EXP

EXT

FB

FLUOR

FLR

FOD

F.0.S.

FUT

GA

GALV

GND

GWB

GYP

HC

H/C

HDWR

HR

HTR

JT(S)

GC

ENT

GENERAL NOTES

1. ALL WORK SHALL BE PERFORMED TO THE FOLLOWING CODES:

a. CALIFORNIA BUILDING CODE 2013 EDITION b. CALIFORNIA MECHANICAL CODE 2013 EDITION c. CALIFORNIA PLUMBING CODE d. CALIFORNIA ELECTRICAL CODE 2013 EDITION e. CALIFORNIA ENERGY CODE 2013 EDITION f. CALIFORNIA FIRE CODE 2013 EDITION g. CALIFORNIA GREEN BUILDING STANDARDS CODE 2013 EDITION h. CALIFORNIA HISTORIC BUILDING CODE 2013 EDITION i. CALIFORNIA RESIDENTIAL BUILDING CODE

- 2. CONTRACTOR SHALL ADHERE TO ALL CODES, RULES & REGULATIONS GOVERNING CONSTRUCTION, BUILDING ACCESS & THE USE OF FACILITIES AS SET BY FEDERAL, STATE & LOCAL BUILDING CODES.
- 3. IT SHALL BE THE RESPONSIBILITY OF THE CONTRACTOR TO NOTIFY THE ARCHITECT OF ANY DISCREPANCIES OR CONFLICTS IN THE DESIGN DWGS.
- ASSUMPTIONS HAVE BEEN MADE REGARDING THE (E) STRUCTURE & CONDITIONS OF WALLS, FLOORS, CEILING & BUILDING COMPONENTS. CONTRACTOR SHALL VERIFY (E) CONDITIONS AS BUILDING STRUCTURE IS UNCOVERED. CONTRACTOR SHALL NOTIFY OWNER IMMEDIATELY OF CONDITIONS DIFFERENT FROM DWGS. ARCHITECT DOES NOT ASSUME RESPONSIBILITY FOR (E) STRUCTURE OR ITS LOCATION & CONDITION.
- 5. CONTRACTOR SHALL BE RESPONSIBLE FOR PROVIDING ALL MATERIALS & WORKMANSHIP (U.N.O.) IN ACCORDANCE WITH ALL FEDERAL, STATE & LOCAL CODES
- 6. THE CONTRACTOR SHALL VERIFY ALL DIMS & (E) CONDITIONS IN THE FIELD & NOTIFY ARCHITECT, IN WRITING, OF ANY DISCREPANCIES PRIOR TO START OF WORK
- 7. LARGE SCALE DWGS TAKE PRESEDENCE OVER SMALL SCALE DWGS.
- 8. ALL DIMS SHOWN ARE TO FACE OF FINISHED WALLS U.N.O.

SOUTH OR SLOPE

SOLID CORE METAL

SOLID CORE WOOD

SMOOTH FOUR SIDES

SEMI-GLOSS (PAINT)

STORM DRAIN

SEPARATION

SQUARE FEET

SINGLE GLAZE

SUMP PUMP

SPEAKER

SQUARE

STEEL

SPECIFICATION

STAINLESS STEEL

SERVICE SINK

STANDARD

TOWEL BAR

TELEPHONE

TEMPORARY

THICK

TOP OF

STAIN

STRL STRUCTURAL

SUSP SUSPENDED

SYM SYMMETRICAL

STORAGE

SHEET

SIMILAR

SEAT COVER DISPENSER

SEE ELECTRICAL DRAWINGS

SEE MECHANICAL DRAWINGS

SANITARY NAPKIN DISPENSER

SANITARY NAPKIN RECEPTACLI

SEE STRUCTURAL DRAWINGS

TOUNGUE AND GROOVE

TO BE DETERMINED

TOP OF CONCRETE

TOP OF PAVEMENT

TOILET PAPER DISPENSER

UNIFORM BUILDING CODE

UNIFORM MECHANICAL CODE

UNLESS NOTED OTHERWISE

UNDERSIDE OF STRUCTURE

UNIFORM PLUMBING CODE

UPPER WORKING POINT

VINYL COMPOSITION TILE

TOP OF PLATE

TOP OF STEEL

TOP OF RAIL

TELEVISION

TOP OF WALL

UNDERGROUND

UNFINISHED

URINAL

VESTIBULE

WEST

WITH

WOOD

WITHOUT

WEIGHT

VERIFY IN FIELD

WATER CLOSET

WATER HEATER

WATERPROOF

WWF WELDED WIRE FABRIC

WET STAND PIPE

VERT VERTICAL

TRENCH DRAIN

SOLID CORE

SCHEDULE

SECTION

SCD SCHD

SCWD

SD SEC SED SEP

SND

SNR

STL

SSK

SSD

STD

STN

TBD

THK

T.O.

TOC

TOP

TPD

T/R

TOW

UNF

UNO

UOS

UPC

VCT

- 9. SEE STRUCTURAL DWGS FOR FOUNDATION, SLAB & ALL OTHER STRUCTURAL INFORMATION & DETAILS.
- 10. NOTIFY THE OWNER & ARCHITECT IF MODIFICATIONS TO STRUCTURAL COMPONENTS ARE REQUIRED TO COMPLETE THE WORK & ARE NOT DESCRIBED IN THE CONTRACT DOCUMENTS.
- 11. THESE DWGS SHALL NOT BE SCALED.
- 12. PROVIDE NATURAL LIGHT (8% MIN. OF ROOM AREA) & NATURAL VENTILATION (5% MIN OF ROOM AREA) OR MECHANICAL VENTILATION PER CBC.
- 13. PROVIDE ESCAPE/EGRESS WINDOWS IN BEDROOMS. MIN. NET CLEAR OPENING: H=24" OR W=20" & AREA=5.7 SQ.FT. & MAX SILL HT.=44" AFF PER CBC.
- 14. CONTRACTOR IS RESPONSIBLE FOR THE DESIGN & CONSTRUCTION OF ANY TEMPORARY SHORING &/OR BRACING FOR ANY CONSTRUCTION.
- 15. REVIEW ALL EXISTING INTERIOR AND EXTERIOR CONDITIONS INCLUDING EXTERIOR SIDING, TRIM, FASCIAS, STRUCTURAL ELEMENTS, PLUMBING, ELECTRICAL, ETC. IT IS THE CONTRACTOR'S RESPONSIBILITY TO FIELD INSPECT ALL SURFACES AND CONSTRUCTION COMPONENTS PRIOR TO SUBMITTING BIDDING DOCUMENTATION. IF CONDITIONS ARE FOUND WHERE REPLACEMENT OF COMPONENTS OR FINISHES ARE REQUIRED THAT ARE NOT INDICATED IN THE DRAWINGS OR SPECIFICATIONS THEN A LINE ITEM IN THE BIDDING DOCUMENTS MUST BE PROVIDED INDICATING THE EXTENT OF WORK, COST OF THE MATERIALS, FABRICATION, INSTALLATION, ETC. & TIME REQUIRED TO EXECUTE THE LINE ITEM(S).
- 16. IT IS THE OWNER'S & GENERAL CONTRACTOR'S RESPONSIBILITY TO DISTRIBUTE THE ASSOCIATED SPECIFICATION BOOK FOR THIS PROJECT TO ALL SUBCONTRACTORS FOR REVIEW PRIOR TO BIDDING & CONSTRUCTION. THE SPECIFICATIONS ARE INTERGRAL TO THE PROJECT AND ARE A LEGAL & BINDING DOCUMENT PERTAINING TO THE

SHOWN ON THE CONSTRUCTION PLAN.

REMOVAL OF DEBRIS.

MATERIALS & SYSTEMS.

DEMOLITION IS NOT LIMITED TO WHAT IS SHOWN. DWGS INDICATE

GENERAL INTENT OF DEMOLITION AREAS ONLY. PLAN INDICATES THE

CONTRACTOR TO VERIFY LOCATION OF (E) UTILITIES & SAFEGUARD PRIOR

GENERAL SCOPE OF DEMOLITION TO COMPLETE THE PROJECT AS

TO STARTING DEMO. IT IS THE CONTRACTOR'S RESPONSIBILITY TO

LOCATE, CAP, RECONNECT, RELOCATE OR REMOVE ANY &/OR ALL

UTILITIES BEFORE, DURING & AFTER DEMO & (N) CONSTRUCTION.

3. THE CONTRACTOR SHALL COORDINATE WITH BUILDING OWNER THE

4. WHERE (E) CONSTRUCTION IS REMOVED, ALL FIXTURES (OUTLETS,

SWITCHES, THERMOSTATS, ETC.) SHALL ALSO BE REMOVED & CAPPED

BEHIND FINISHED WALL UNLESS FIXTURES ARE TO BE REUSED &/OR

WHERE (E) CONSTRUCTION IS DISTURBED BY DEMOLITON, IT SHALL BE

3. PATCH & REPAIR ROOF WHERE NEW CONSTRUCTION OCCURS. MATCH (E)

REPAIRED &/OR PATCHED TO MATCH (E) FINISH OR AS SPECIFIED IN

RELOCATED. CONCEAL NO SWITCHES, JCT. BOXES, ETC. IN WALLS.

SITE DATA

ROJECT DESCRIPTION AND USE

RENOVATION OF EXISTING SINGLE FAMILY RESIDENCE ADD (N) THIRD FLOOR.

- EXTENDING MAIN FLOOR IN BACK OF RESIDENCE, UPPER FLOOR TO MATCH.
- RELOCATE & ADD (N) BEARING WALLS, NON-BEARING WALLS, PLUMBING AND ELECTRICAL
- RELOCATE EXISTING WINDOWS & INSTALL NEW WINDOWS WITH LIKE IN-KIND. INSTALL NEW INTERIOR DOORS.


RELOCATE (E) INTERIOR STAIRS & ADD (N) INTERIOR STAIRS.

PARCEL NUMBER: 73-374-10 **ZONING:** R-4OCCUPANCY:

CONSTRUCTION TYPE:

TYPE V, NON-RATED

SITE PLAN & PROJECT AREA

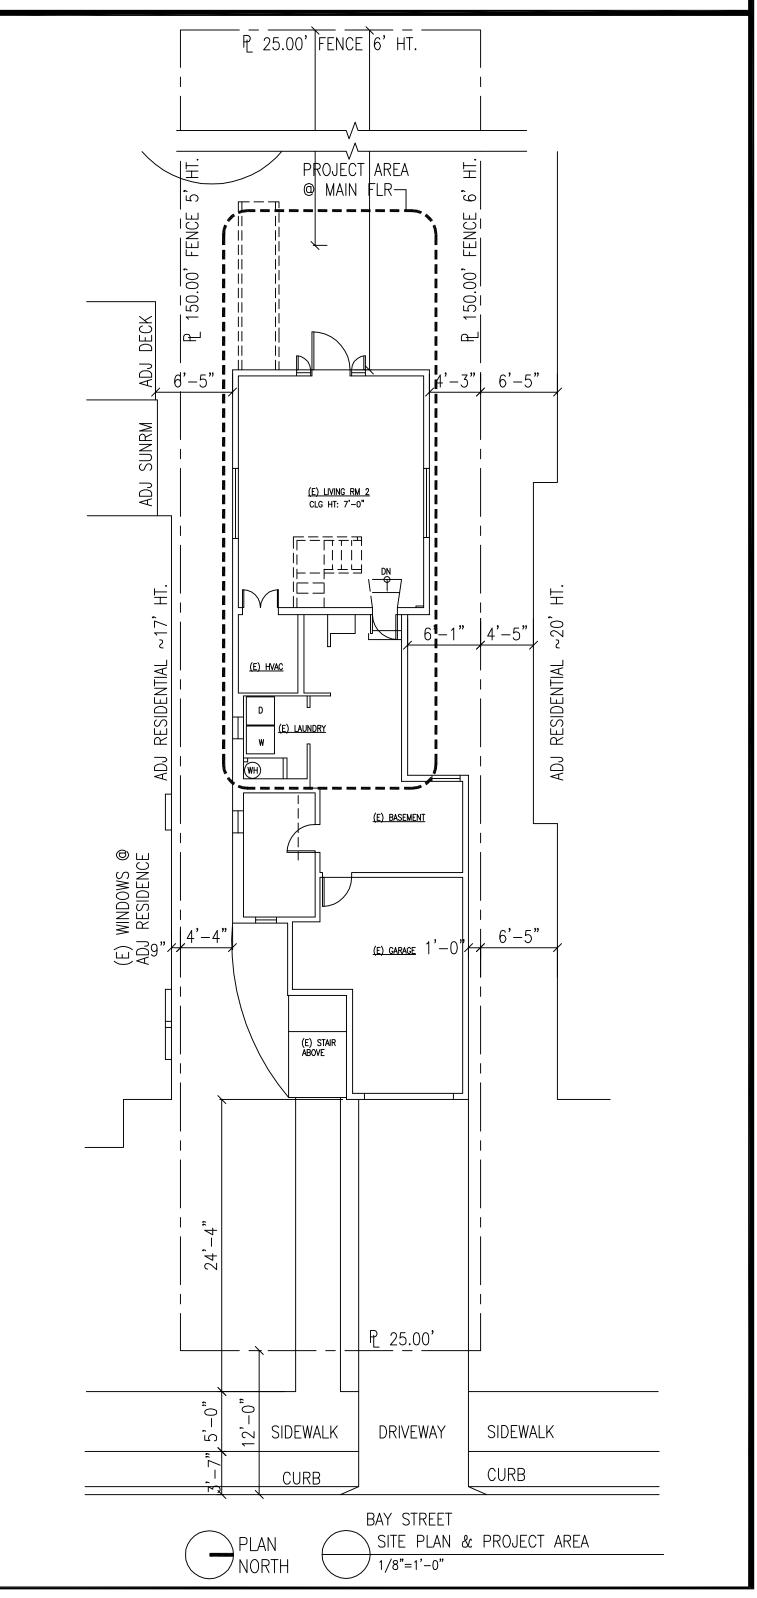

LAVATORY

LOCKER

LIGHT

LTNG

MECH

MEM

MISC

MTD

NTS

OPNG

Part

PLYWD

POC

POT

PR0P

REINF

REQD

RWL

LOW POINT

LIGHTING

MATERIAL

MAXIMUM

MECHANICAL

MEMBRANE

MANHOLE

MINIMUM

MOUNT

MOUNTED

MULLION

NEW

NORTH

MICROWAVE

MISCELLANEOUS

NOT APPLICABLE

NARROW LITE

NOT TO SCALE

POLE & SHELF

PRECAST CONCRETE

POINT OF CONNECTION

PROPERTY
POUNDS PER SQUARE INCH
UG
POINT/PRESSURE TREATED
UMC

PAPER TOWEL DISPENSER

PLASTER PLASTIC LAMINATE

PATH OF TRAVEL

& RECEPTACLE

QUARRY TILE

RETURN AIR

ROOF DRAIN

REFRIGERATOR

ROUGH OPENING

RAIN WATER LEADER

RIGHT OF WAY

RESILIENT TILE

REINFORCED

REQUIRED

RESILIENT

REVISION

ROOM

REFERENCE

RESILIENT BASE

REFLECTED CEILING PLAN

POLYVINYL CHLORIDE

PARTITION

PLATE

PLYWOOD

OUTSIDE DIAMETER

NOMINAL

OVERALL

OPENING

ON CENTER

NOT IN CONTRACT

MASONRY OPENING

METAL

LINEAL FEET

LINOLEUM SHEET

MANUFACTURER

LANDSCAPE CONTRACTOR

CONTACT INFO DEMO NOTES

STRUCTURAL ENGINEER:

NICOLE BLAKE AND RYAN CLAUSNITZER LOU XIAO, S.E. 1427 BAY STREET 723 CAMINO PLAZA #115 ALAMEDA, CA 94501 SAN BRUNO, CA 94066 (510) 523-1130 (415) 601-9686

2013 EDITION

SHEET INDEX

TITLE PAGE, SITE PLAN & PROJECT INFO CITY OF ALAMEDA DESIGN REVIEW APPROVAL NOTICE A1.2 EXISTING & PROPOSED SITE PLANS EXISTING & PROPOSED GROUND FLOOR PLANS & SCHEDULES EXISTING & PROPOSED MAIN FLOOR PLANS & SCHEDULES EXISTING & PROPOSED UPPER FLOOR PLANS & SCHEDULES EXISTING & PROPOSED ROOF PLANS A3.0 EXISTING EXTERIOR ELEVATIONS A3.1 PROPOSED EXTERIOR ELEVATIONS A4.0 PROPOSED INTERIOR ELEVATIONS A4.1 SECTIONS, DETAILS, & CALGREEN NOTES A5.0 ELECTRICAL PLANS & SCHEDULE A5.1 ELECTRICAL NOTES A6.0 PLUMBING PLANS & SCHEDULE A6.1 PLUMBING DIAGRAMS A7.0 PROJECT NOTES 0.8A TITLE 24 A8.1 TITLE 24 NOTES, ABBREVIATIONS, LEGEND & SHEET INDEX UPPER PLAN/LOWER ROOF, GROUND FLOOR & BASEMENT/CRAWL SPACE TYPICAL DETAILS

LOT COVERAGE CALCULATION:

PARCEL SIZE: 3,750 SF

SECTIONS & DETAILS

(E) LOT COVERAGE: 1039 SF (N) LOT COVERAGE: 1275 SF ALLOWED: 50%

AREA CALCULATIONS

CHANGES TO LOT COVERAGE:

PROPOSED: 34%

(E) HABITABLE SPACE TOTAL: 1222 SF (N) HABITABLE SPACE TOTAL: 1972 SF (ADDITION OF 749 SF)

CONT CONTINUOUS CORR CORRIDOR COLD ROLLED CRM CLASSROOM CASEMENT CERAMIC TILI CTR CENTER CTSK COUNTERSUNK CUBIC YARD DBL DOUBLE DEPT DEPARTMENT DET DRINKING FOUNTAIN DG DUAL GLAZED DIA DIAMETER DIMENSION DISP DISPOSAL DO DOOR OPENING DOOR DOUBLE HUNG DS DWG

DOWN SPOUT DRAWING **EXISTING** EACH EXPANSION JOIN

ELEVATION ELEC ELECTRICAL

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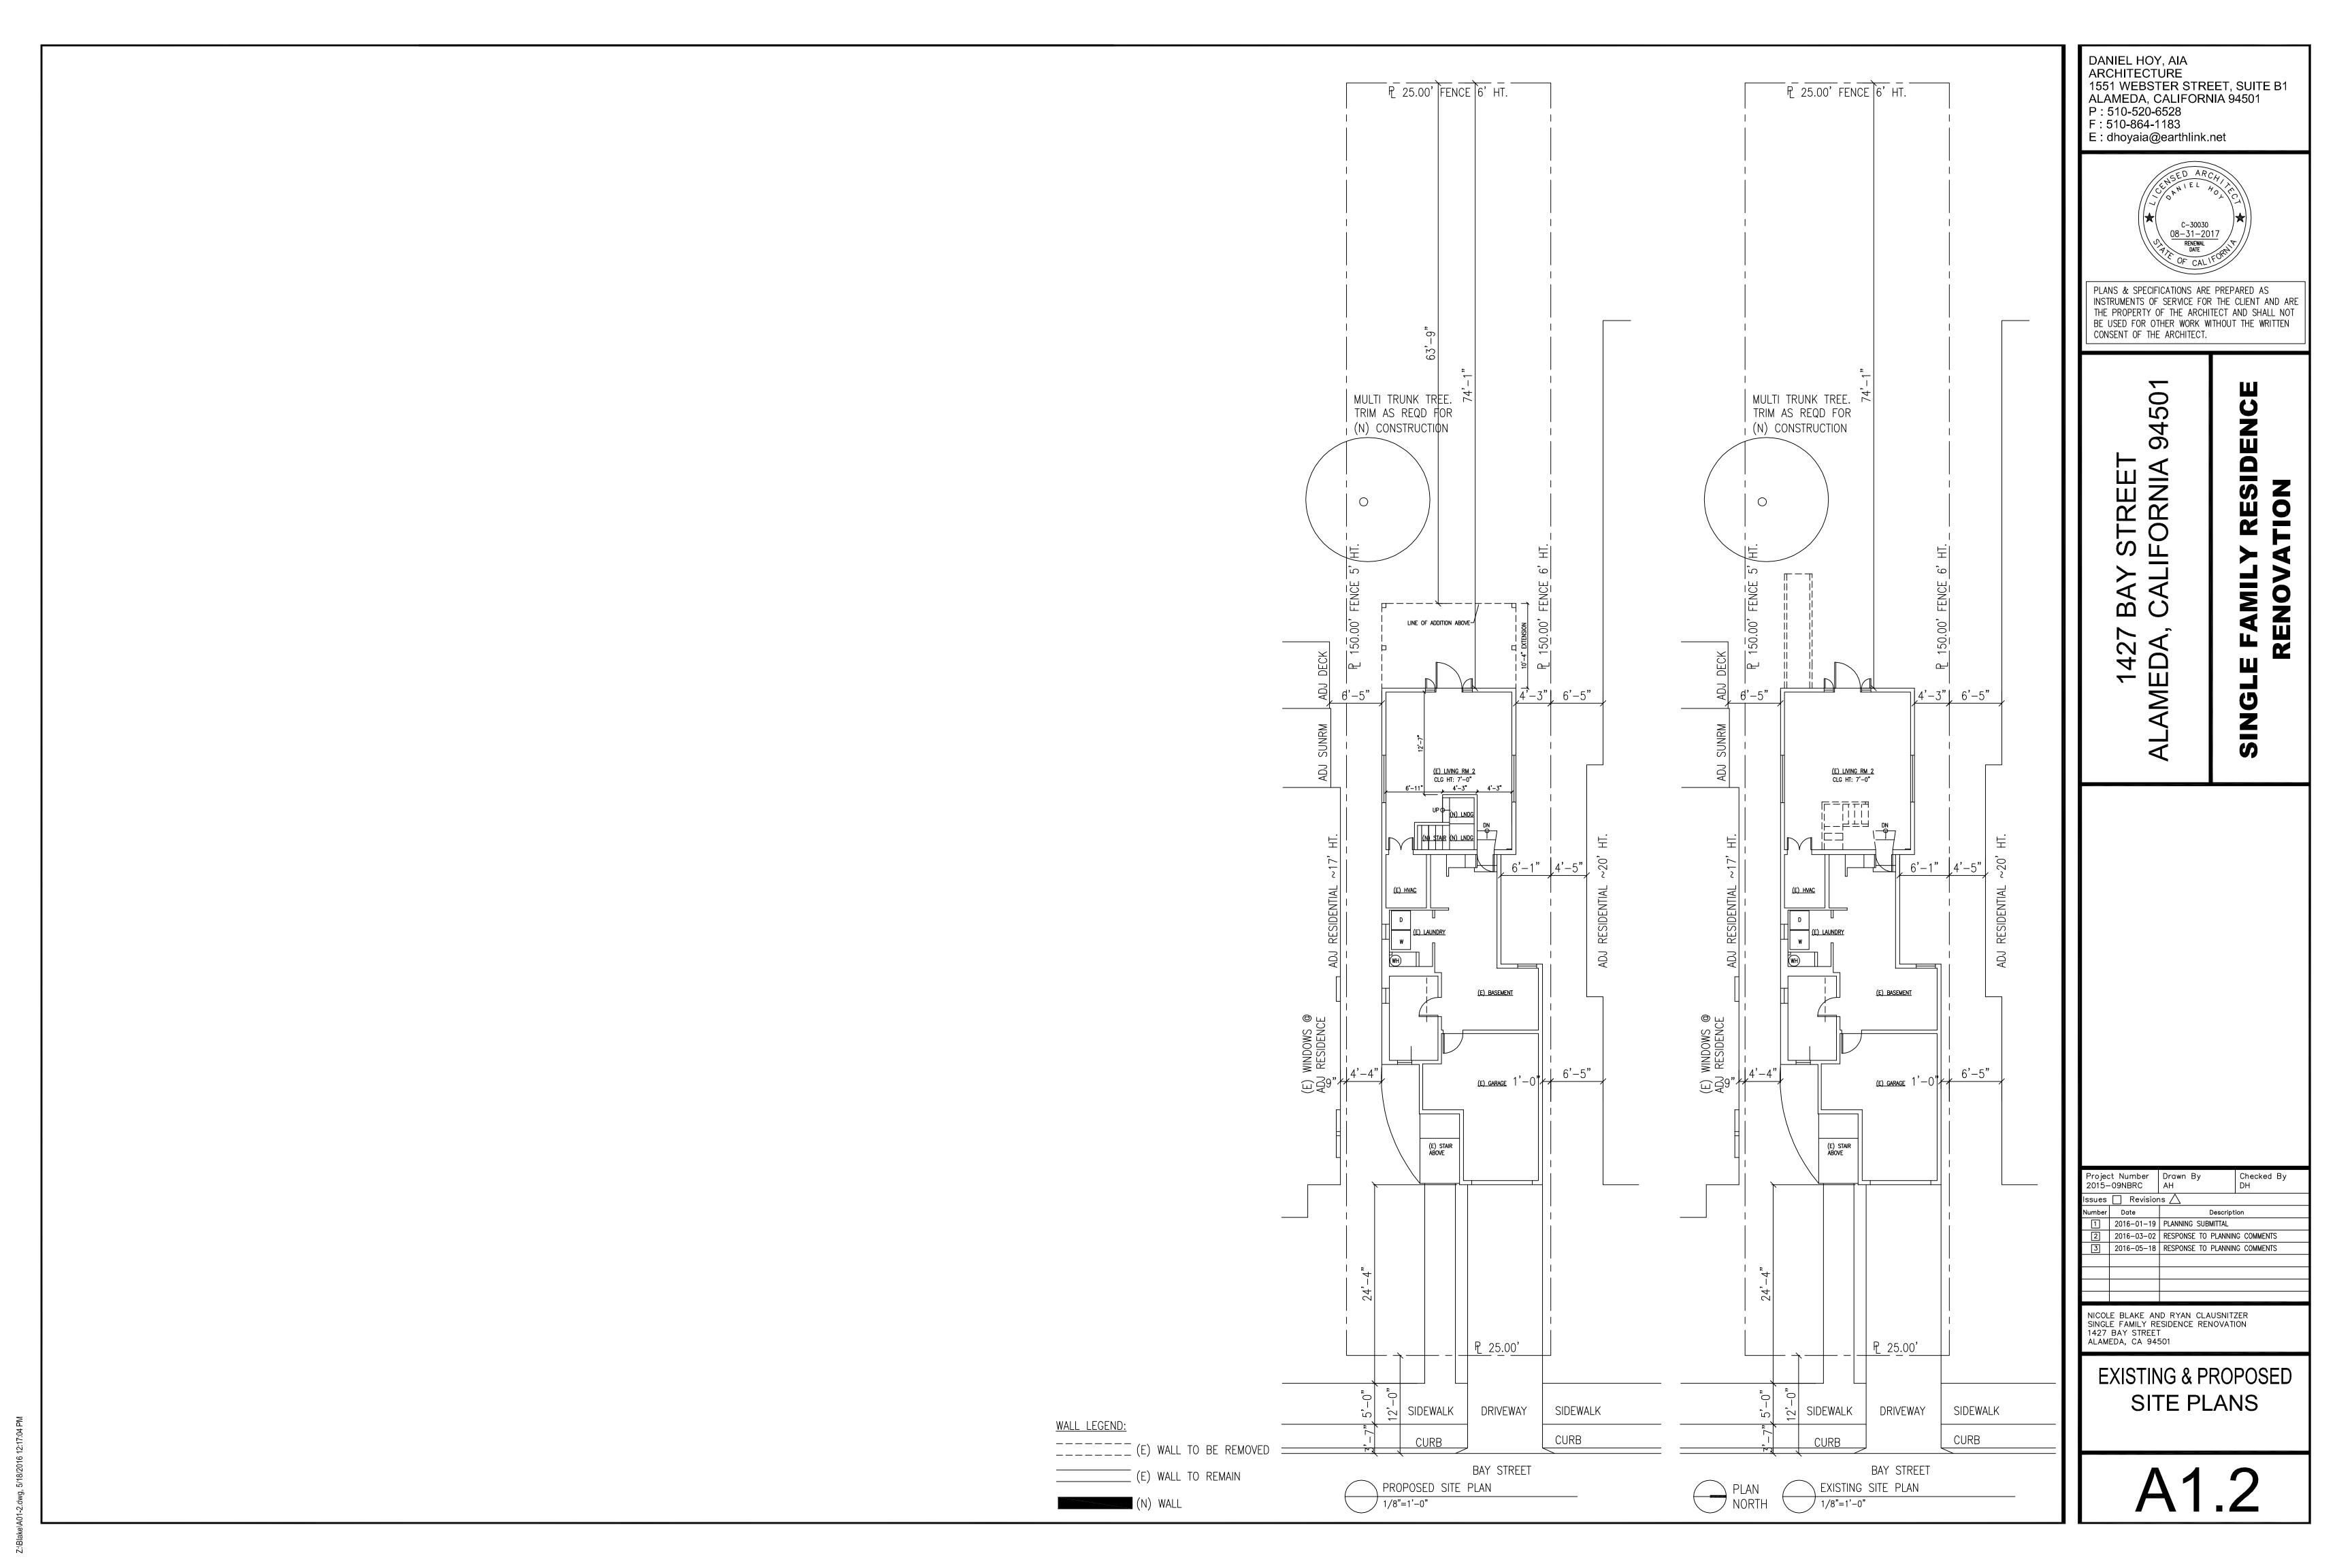
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Project Number | Drawn By Checked By 2015-09NBRC Issues 🦳 Revisions 🖊 Description 2016-01-19 | PLANNING SUBMITTAL 2016-03-02 RESPONSE TO PLANNING COMMENTS 2016-05-18 RESPONSE TO PLANNING COMMENTS

SINGLE FAMILY RESIDENCE RENOVATION 1427 BAY STREET ALAMEDA, CA 94501

TITLE PAGE, SITE PLAN & PROJECT INFO



WINDOW SCHEDULE - GROUND FLOOR									
SYMBOL		TYPE	MATERIAL	RO W	RO HT	CLR W	CLR HT	HT. FROM FIN. FLR.	NOTE
$\left\langle 1\right\rangle$	(E)	SL/DG	V	(E)	(E)	1'-9"	1'-10"	(E)	TO REMAIN
$\langle 2 \rangle$	(E)	SL/DG	V	(E)	(E)	1'-10"	1'-10"	(E)	TO REMAIN
3	(E)	SL/DG	V	(E)	(E)	1'-10"	1'-10"	(E)	TO REMAIN
4	(E)	SL/DG	V	(E)	(E)	5'-10"	2'-9"	(E)	TO REMAIN
5	(E)	CSMT/DG	V	(E)	(E)	1'-2"	6'-8"	(E)	TO REMAIN
6	(E)	CSMT/DG	V	(E)	(E)	1'-2"	6'-8"	(E)	TO REMAIN
$\overline{7}$	(E)	SL/DG	V	(E)	(E)	5'-9"	2'-9"	(E)	TO REMAIN
8	(E)	SL/DG	V	(E)	(E)	2'-4"	2'-10"	(E)	TO REMAIN

- VIF ALL RO MEASUREMENT REQS. W/WINDOW MANUF. PRIOR TO CONSTRUCTION.
- PROVIDE MANUFACTURER & MODEL TO OWNER PRIOR TO ORDERING. ALL REPLACEMENTS TO BE MARVIN OR APPD EQ., LOW E, DUAL GLAZE.
- 3. SEE FINISH NOTES FOR ADDITIONAL INFO.
- 4. VIF, PRIOR TO BID, ANY REQD REPAIRS OR REPLACEMENTS.
- 5. PROVIDE "OGEE" LUGS OR TRUE DIVIDED LITES WHERE WINDOW STYLE IS TO MATCH (E).

DOOR SCHEDULE - GROUND FLOOR


ı	SYMBOL	TYPF	WIDTH	HT.	THICK	HDWR	NOTES			
ı										
	9)	(E) TO REMAIN	GL: 2'-0"X5'-							
ı	E	(E) TO REMAIN	NO CHANGES							


DOOR NOTES:

- 1. VERIFY ALL DIMS W/OWNER PRIOR TO FINAL FRAMING.
- 2. ALL DOOR STYLES TO BE APPD BY OWNER PRIOR TO ORDERING.

FINISH NOTES:.

- . WHERE NEW WORK JOINS (E) WORK CONTRACTOR SHALL PROVIDE & INSTALL MATERIAL TO MATCH (E) PATTERN, COLOR, FINISH, TEXTURE & DESIGN. PATCH & REPAIR ALL MATERIALS & SURFACES THAT ARE AFFECTED BY THE NEW WORK. THERE SHALL BE NO VISUAL DISCREPANCIES BETWEEN NEW & (E) WORK. NOTIFY OWNER & ARCHITECT PRIOR TO COMMENCEMENT OF CONSTRUCTION IF MATCHING MATERIALS, DETAILS OR COLORS ARE NOT AVAILABLE.
- 2. CRIPPLE WALL STUDS. IF REQ'D. TO BE IN COMPLIANCE WITH CODE. MIN. STUD LENGTH OF 14". OR FRAMED OF SOLID
- 3. CEILING HT IN HABITABLE ROOMS SHALL BE MIN. 7'-6".
- 4. CONTRACTOR SHALL VERIFY ALL WINDOW & DOOR DIMS & CONDITIONS PRIOR TO MATERIAL ORDER. COORDINATE WITH
- 5. PAINT THROUGHOUT, EXTERIOR AT AFFECTED WORK & ALL INTERIOR SURFACES.
- 6. WOOD DOORS & FRAMES TO BE PAINT GRADE.
- 7. PROVIDE & INSTALL ALL HARDWARE NOT NOTED (PULLS, STOPS, HINGES, ETC.) AS REQUIRED PER CODE & FOR A COMPLETE OPERATING SYSTEM.
- 8. INSTALL WATER RESISTANT GYPSUM BACKING WHEN GYPSUM IS USED AS A BASE FOR TILE OR WALL PANELS FOR (N) WATER CLOSET COMPARTMENT WALLS, ETC. CEMENT, FIBER-CEMENT OR GLASS MAT GYPSUM BACKERS SHALL BE USED AS A BASE FOR WALL TILE IN TUB & SHOWER AREAS & WALL & CLG PANELS IN SHOWER AREAS.
- 9. SUBMIT GYP. BD. FINISH SAMPLE TO OWNER FOR APPROVAL PRIOR TO INSTALLATION.
- 10. PROVIDE SHOP DWGS OF CABINETS FOR OWNER'S APPROVAL PRIOR TO FABRICATION & INSTALLATION.
- 11. TILE BACK SPLASH @ COUNTERS TO BE SELECTED/APPROVED BY OWNER.
- 12. COUNTER TOP SURFACE TO BE SELECTED BY OWNER.
- 13. ALL TILE SURFACES & GROUT TO BE APPROVED BY OWNER PRIOR TO ORDERING. SAME MATERIAL. SEE DWGS FOR EXTENT. OWNER TO APPROVE SAMPLE PATTERN (CONTRACTOR TO PROVIDE) PRIOR TO INSTALLING.
- 14. FOLLOW ALL MANUFACTURER'S INSTALLATION INSTRUCTIONS FOR MATERIALS, FIXTURES & FINISHES.
- 15. ALL FINISHES: GC TO PROVIDE COLORS & MATERIAL SAMPLES FOR OWNER APPROVAL PRIOR TO ORDERING & INSTALLATION
- 16. OWNER TO APPROVE ALL BATHROOM ACCESSORIES PRIOR TO ORDERING. CONTRACTOR INSTALL.
- 17. PROVIDE BLOCKING WHERE REQUIRED BY MANUFACTURER, AT LOCATIONS REQUIRED BY CODE & AT ALL FIXTURES & EQUIPMENT.
- 18. UNO, WHERE EXISTING MATERIALS OF DIFFERING QUALITY, DIMENSION, FABRICATION, ETC. ARE INSTALLED THE MATERIAL OF HIGHER QUALITY, DIMENSION, FABRICATION, ETC. SHALL BE USED FOR BIDDING PURPOSES WHERE "MATCH EXISTING" IS INDICATED.
- 19. UNO ALL TRIMS, CASINGS, BASEBOARDS, FINISHES, ETC: MATCH EXISTING FOR BIDDING PURPOSES. SEE SPECIFICATIONS FOR FURTHER INFORMATION.
- 20. REVIEW ALL EXISTING INTERIOR AND EXTERIOR CONDITIONS INCLUDING EXTERIOR SIDING, TRIM, FASCIAS, STRUCTURAL COMPONENTS, PLUMBING, ELECTRICAL, ETC. IT IS THE CONTRACTOR'S RESPONSIBILITY TO FIELD INSPECT ALL SURFACES AND CONSTRUCTION COMPONENTS PRIOR TO SUBMITTING BIDDING DOCUMENTATION. IF CONDITIONS ARE FOUND WHERE REPLACEMENT OF COMPONENTS OR FINISHES ARE REQUIRED THAT ARE NOT INDICATED IN THE DRAWINGS OR SPECIFICATIONS THEN A LINE ITEM IN THE BIDDING DOCUMENTS MUST BE PROVIDED INDICATING THE EXTENT OF WORK AND COST OF THE MATERIALS, FABRICATION, INSTALLATION, ETC.
- 21. PROVIDE FIRE BLOCKING & CAULK W/APPROVED SEALANTS AT ALL LOCATIONS AS REQ'D BY CODE.

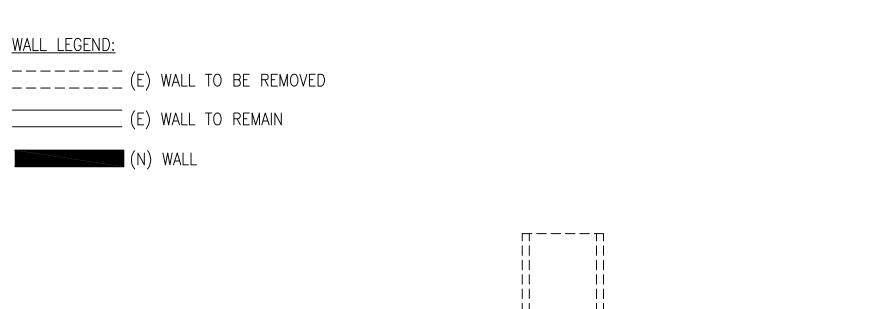

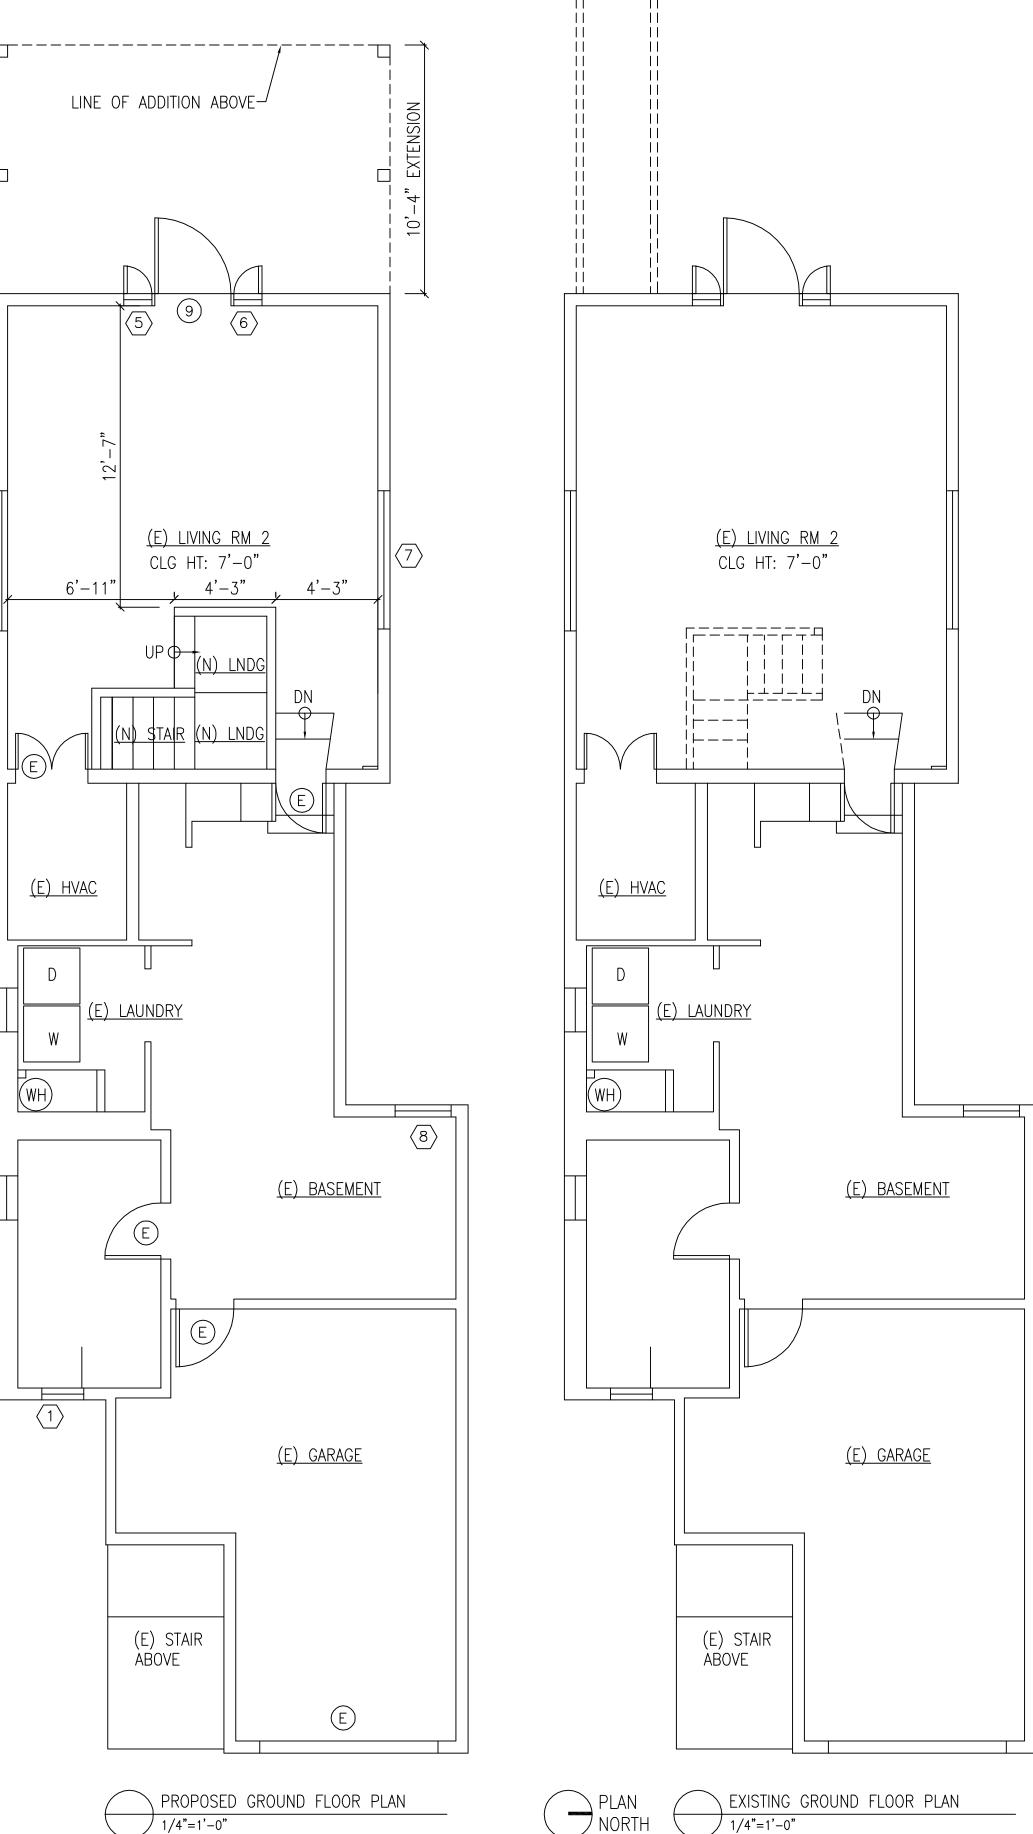

1/4"=1'-0"

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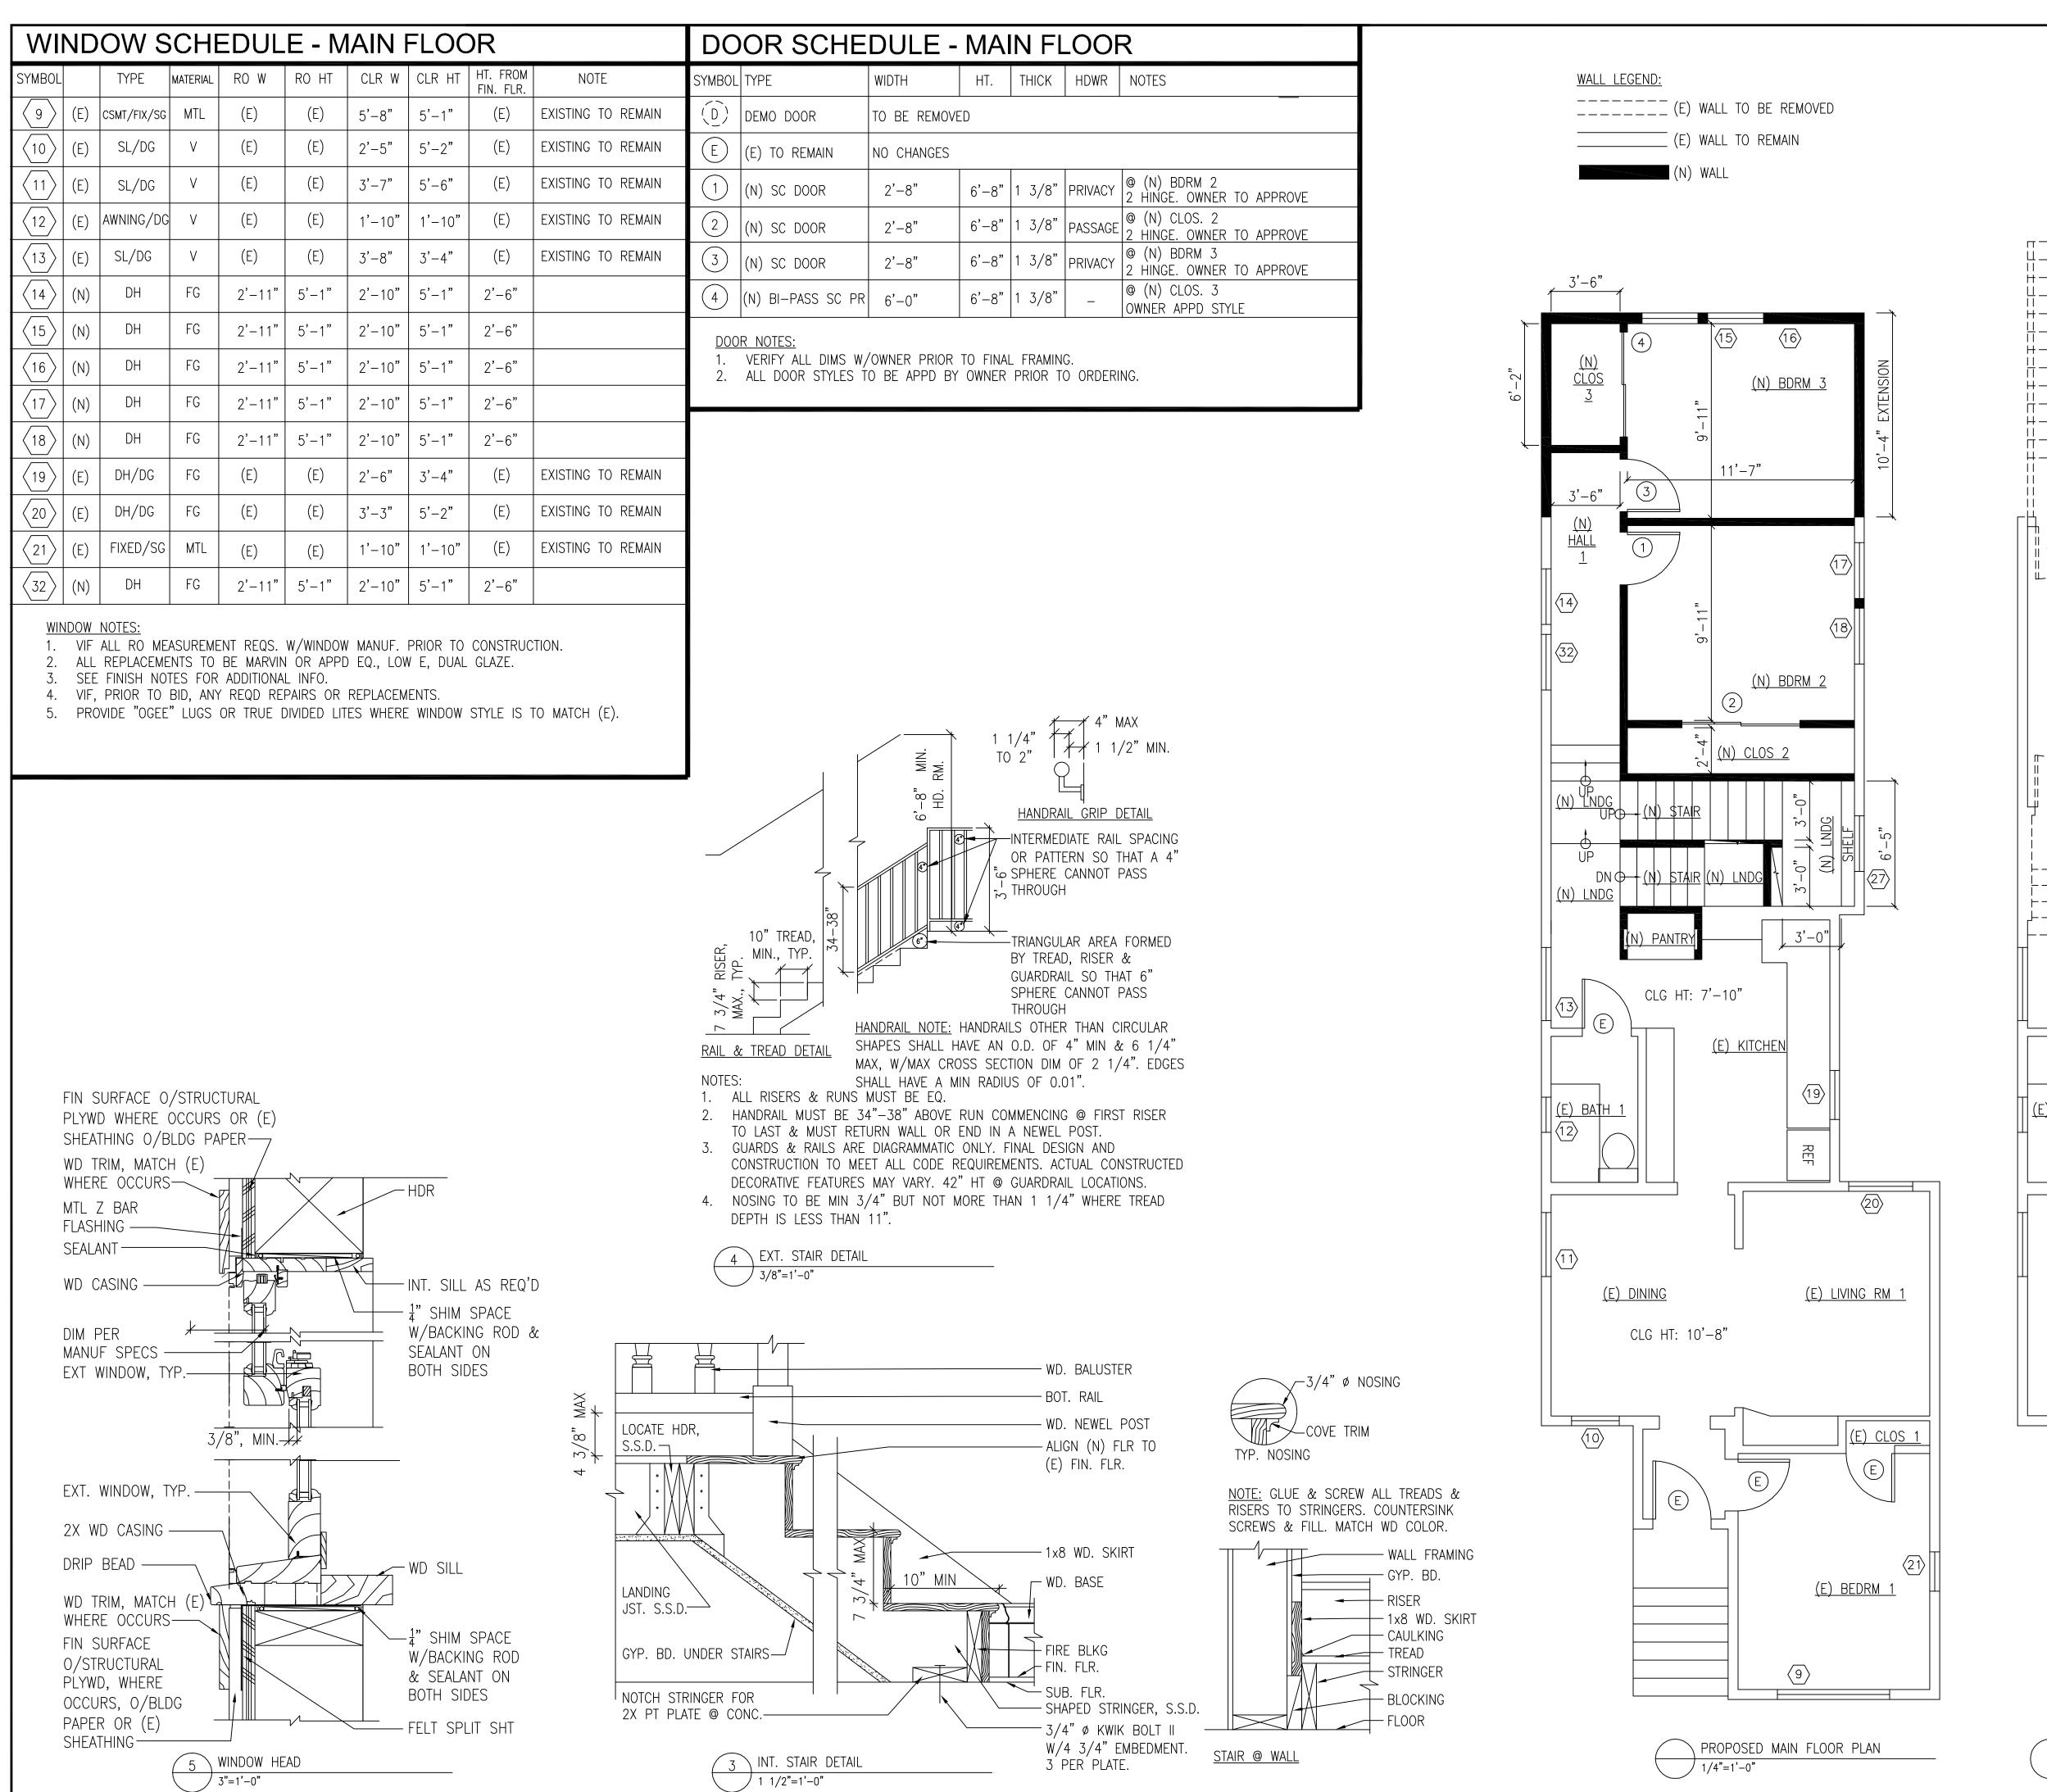
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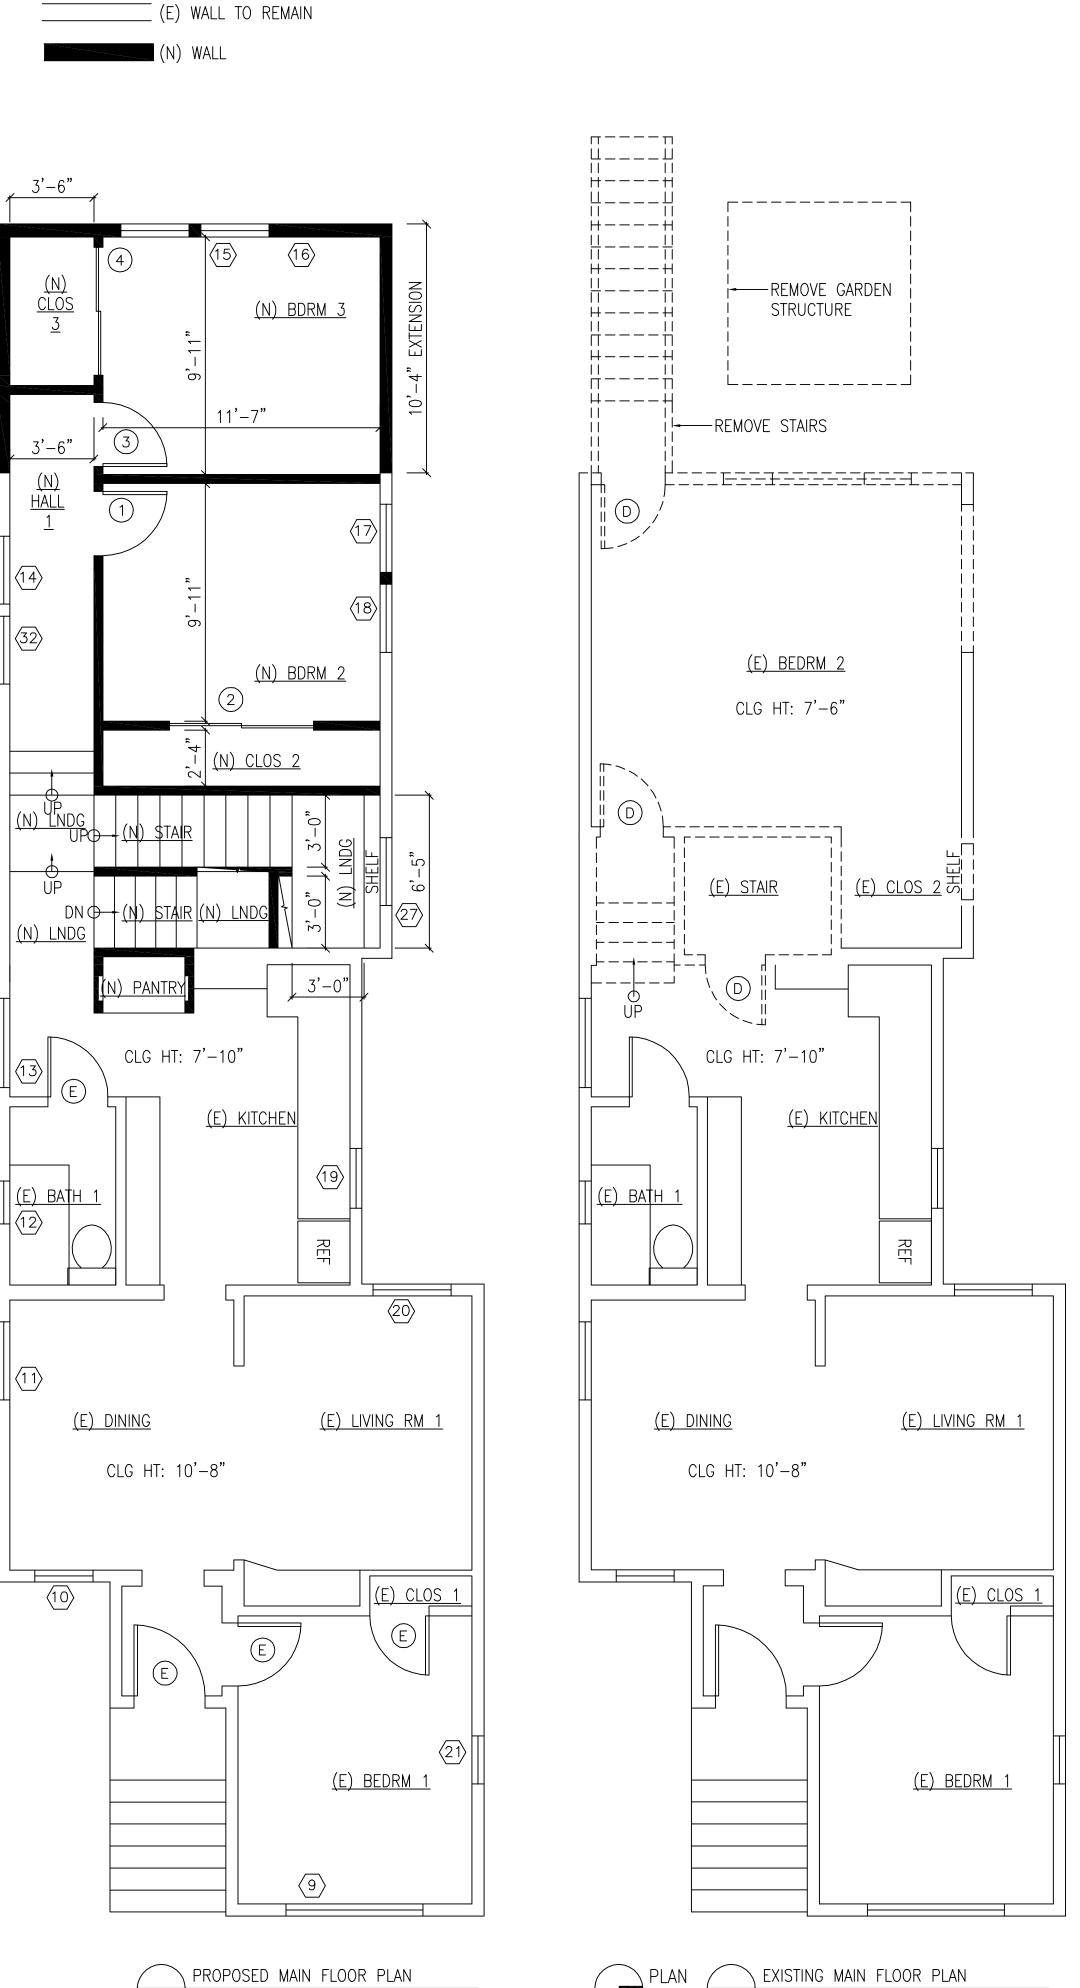
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NICOLE BLAKE AND RYAN CLAUSNITZER SINGLE FAMILY RESIDENCE RENOVATION 1427 BAY STREET ALAMEDA, CA 94501

EXISTING & PROPOSED GROUND FLOOR PLAN & SCHEDULES





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EXISTING & PROPOSED MAIN FLOOR PLAN & SCHEDULES

WII	WINDOW SCHEDULE - UPPER FLOOR								
SYMBOL		TYPE	MATERIAL	RO W	RO HT	CLR W	CLR HT	HT. FROM FIN. FLR.	NOTE
22	(N)	DH	FG	2'-11"	5'-1"	2'-10"	5'-0"	2'-6"	
23	(N)	DH	FG	2'-11"	5'-1"	2'-10"	5'-0"	2'-6"	TEMPERED
24	(N)	DH	FG	2'-11"	5'-1"	2'-10"	5'-0"	2'-6"	TEMPERED
25	(N)	DH	FG	2'-11"	5'-1"	2'-10"	5'-0"	2'-6"	
26	(N)	DH	FG	2'-11"	5'-1"	2'-10"	5'-0"	2'-6"	
27	(N)	DH	FG	2'-11"	5'-1"	2'-10"	5'-0"	3'-0"	AFF @ STAIR LANDING
28	(N)	DH	FG	2'-11"	5'-1"	2'-10"	5'-0"	2'-6"	
29	(N)	DH	FG	2'-11"	5'-1"	2'-10"	5'-0"	2'-6"	
30	(N)	DH	FG	2'-9"	4'-1"	2'-8"	4'-0"	3'-0"	TEMPERED
(31)	(N)	DH	FG	2'-9"	4'-1"	2'-8"	4'-0"	3'-0"	TEMPERED
33	(N)	DH	FG	2'-9"	4'-1"	2'-8"	2'-10"	6'-6"	
34	(N)	DH	FG	2'-9"	4'-1"	2'-8"	2'-10"	6'-6"	

<u>WINDOW NOTES</u>


- 1. VIF ALL RO MEASUREMENT REQS. W/WINDOW MANUF. PRIOR TO CONSTRUCTION. PROVIDE
- MANUFACTURER & MODEL TO OWNER PRIOR TO ORDERING. 2. ALL REPLACEMENTS TO BE MARVIN OR APPD EQ., LOW E, DUAL GLAZE.
- 3. SEE FINISH NOTES FOR ADDITIONAL INFO.
- 4. VIF, PRIOR TO BID, ANY REQD REPAIRS OR REPLACEMENTS.
- 5. PROVIDE "OGEE" LUGS OR TRUE DIVIDED LITES WHERE WINDOW STYLE IS TO MATCH (E).

DOOR SCHEDULE - UPPER FLOOR

SYMBOL	TYPE	WIDTH	HT.	THICK	HDWR	NOTES
E	(E) TO REMAIN	NO CHANGES)			
5	(N) SC DOOR	2'-8"	6'-8"	1 3/8"	PRIVACY	(N) MASTER BATH2 HINGE. OWNER TO APPROVE
6	(N) SC DOOR	2'-8"	6'-8"	1 3/8"	PRIVACY	(N) MASTER TOILET2 HINGE. OWNER TO APPROVE
7	(N) SC DOOR	2'-8"	6'-8"	1 3/8"	PRIVACY	(N) MASTER BDRM2 HINGE. OWNER TO APPROVE
8	(N) SC DOOR	2'-8"	6'-8"	1 3/8"	PASSAGE	(N) MASTER CLOSET2 HINGE. OWNER TO APPROVE

DOOR NOTES:

1. VERIFY ALL DIMS W/OWNER PRIOR TO FINAL FRAMING.
2. ALL DOOR STYLES TO BE APPD BY OWNER PRIOR TO ORDERING.

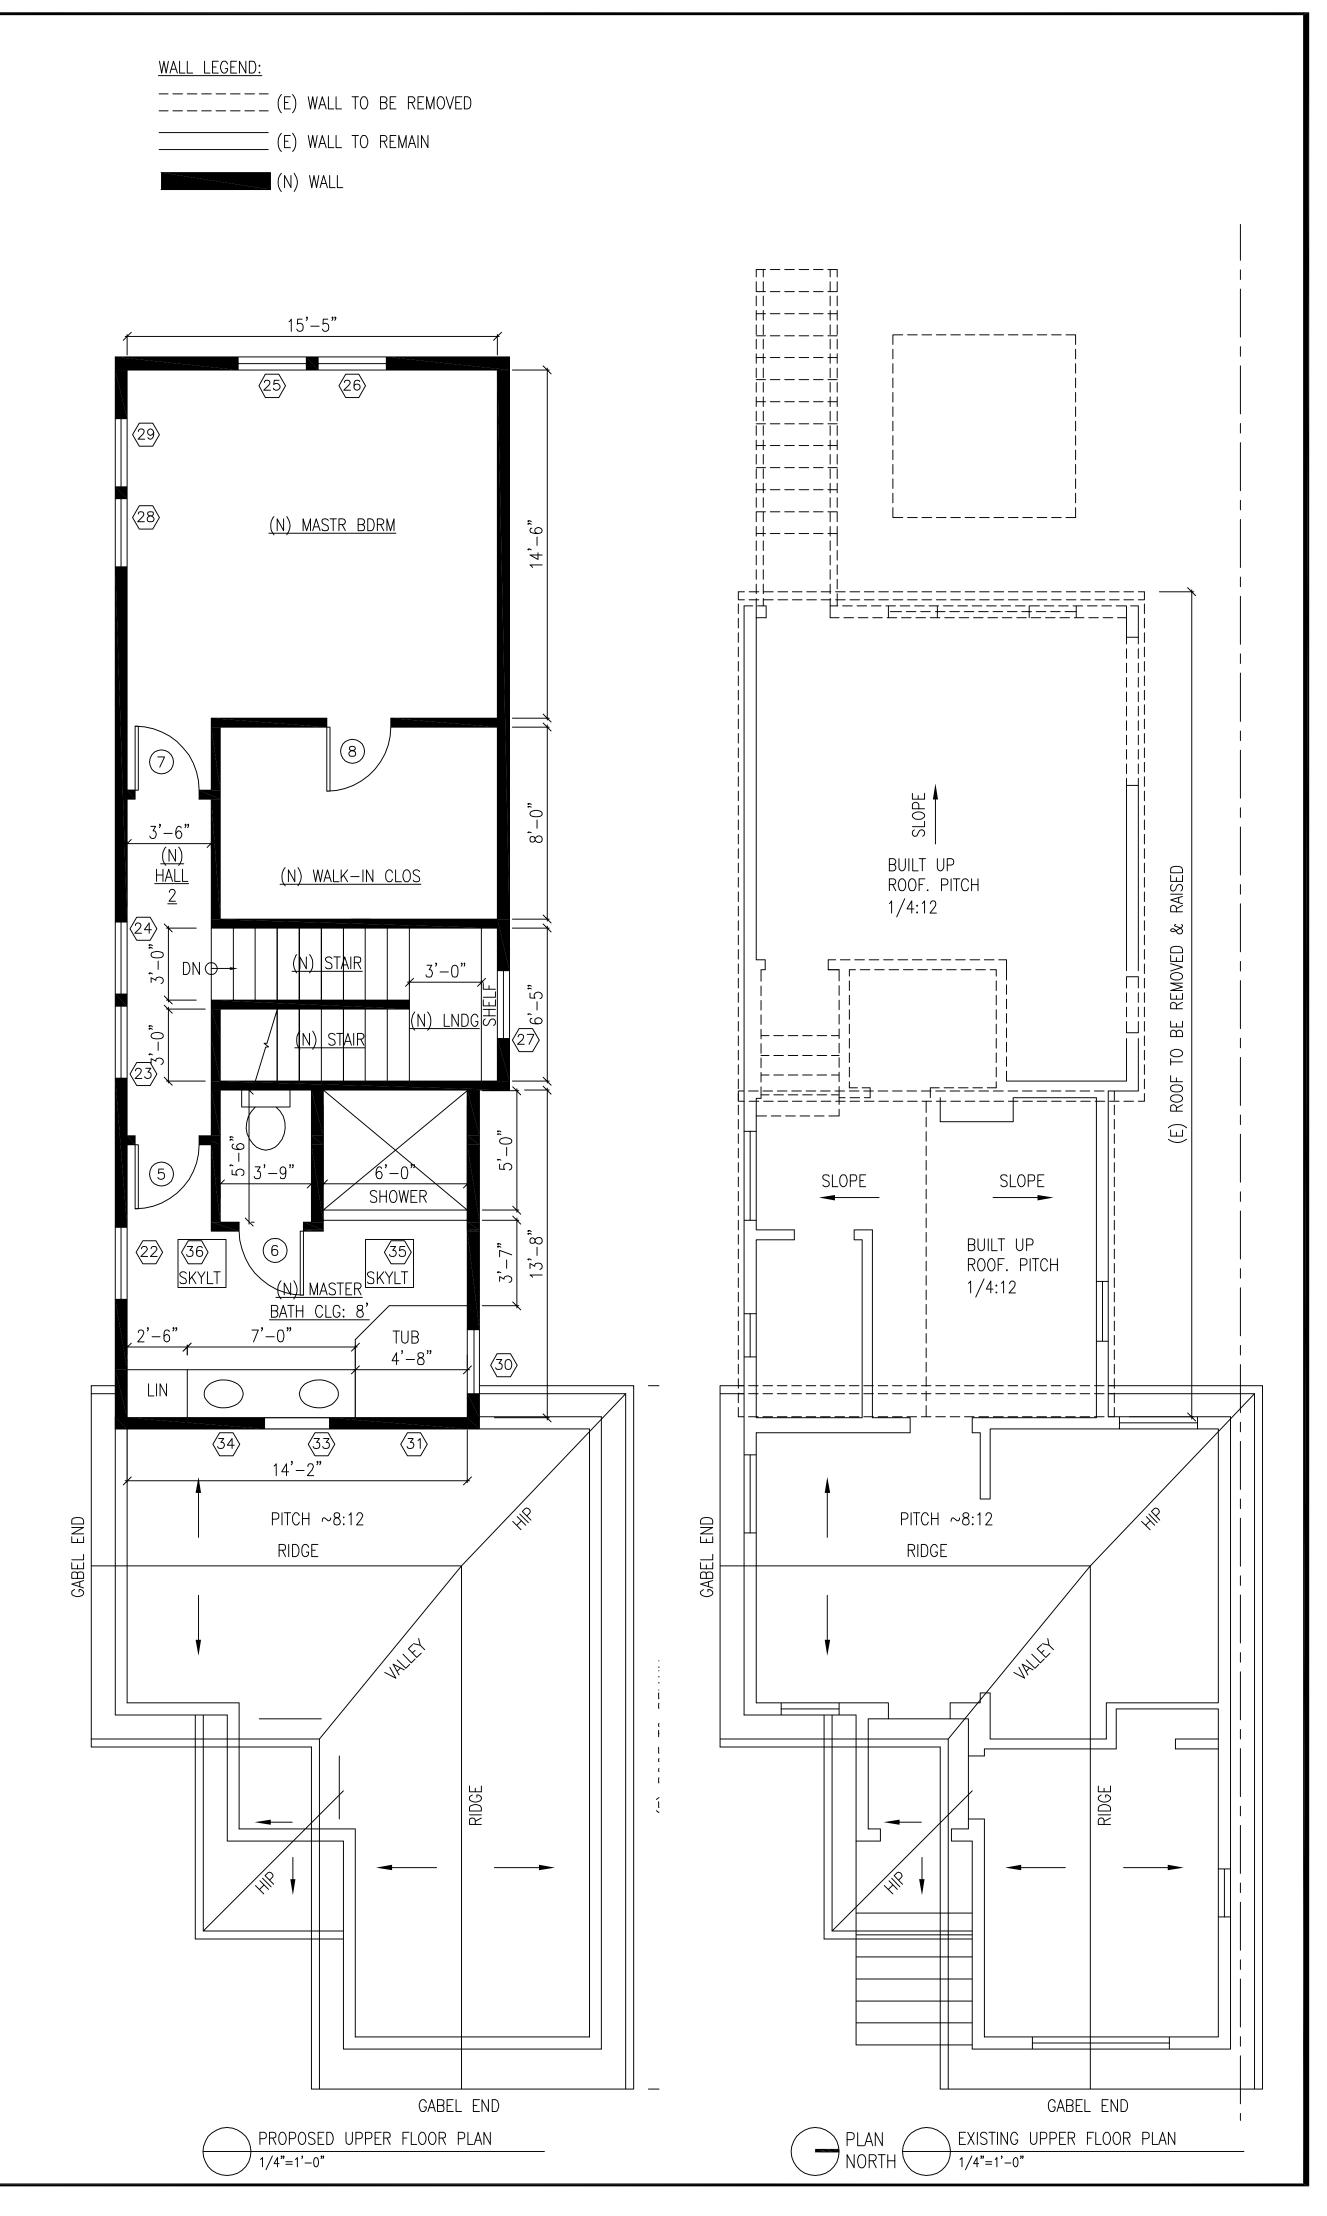

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BAY STREET CALIFORNIA


E FAMILY RESIDENCI

ect Number 5—09NBRC	Drawn By AH	Checked By DH					
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er Date	Description						
2016-01-19 PLANNING SUBMITTAL							
2016-03-02	2016-03-02 RESPONSE TO PLANNING COMMENTS						
2016-05-18 RESPONSE TO PLANNING COMMENTS							
DLE BLAKE AND RYAN CLAUSNITZER GLE FAMILY RESIDENCE RENOVATION 7 BAY STREET MEDA, CA 94501							

EXISTING & PROPOSED
UPPER FLOOR
PLAN & SCHEDULES

A2.2

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94501

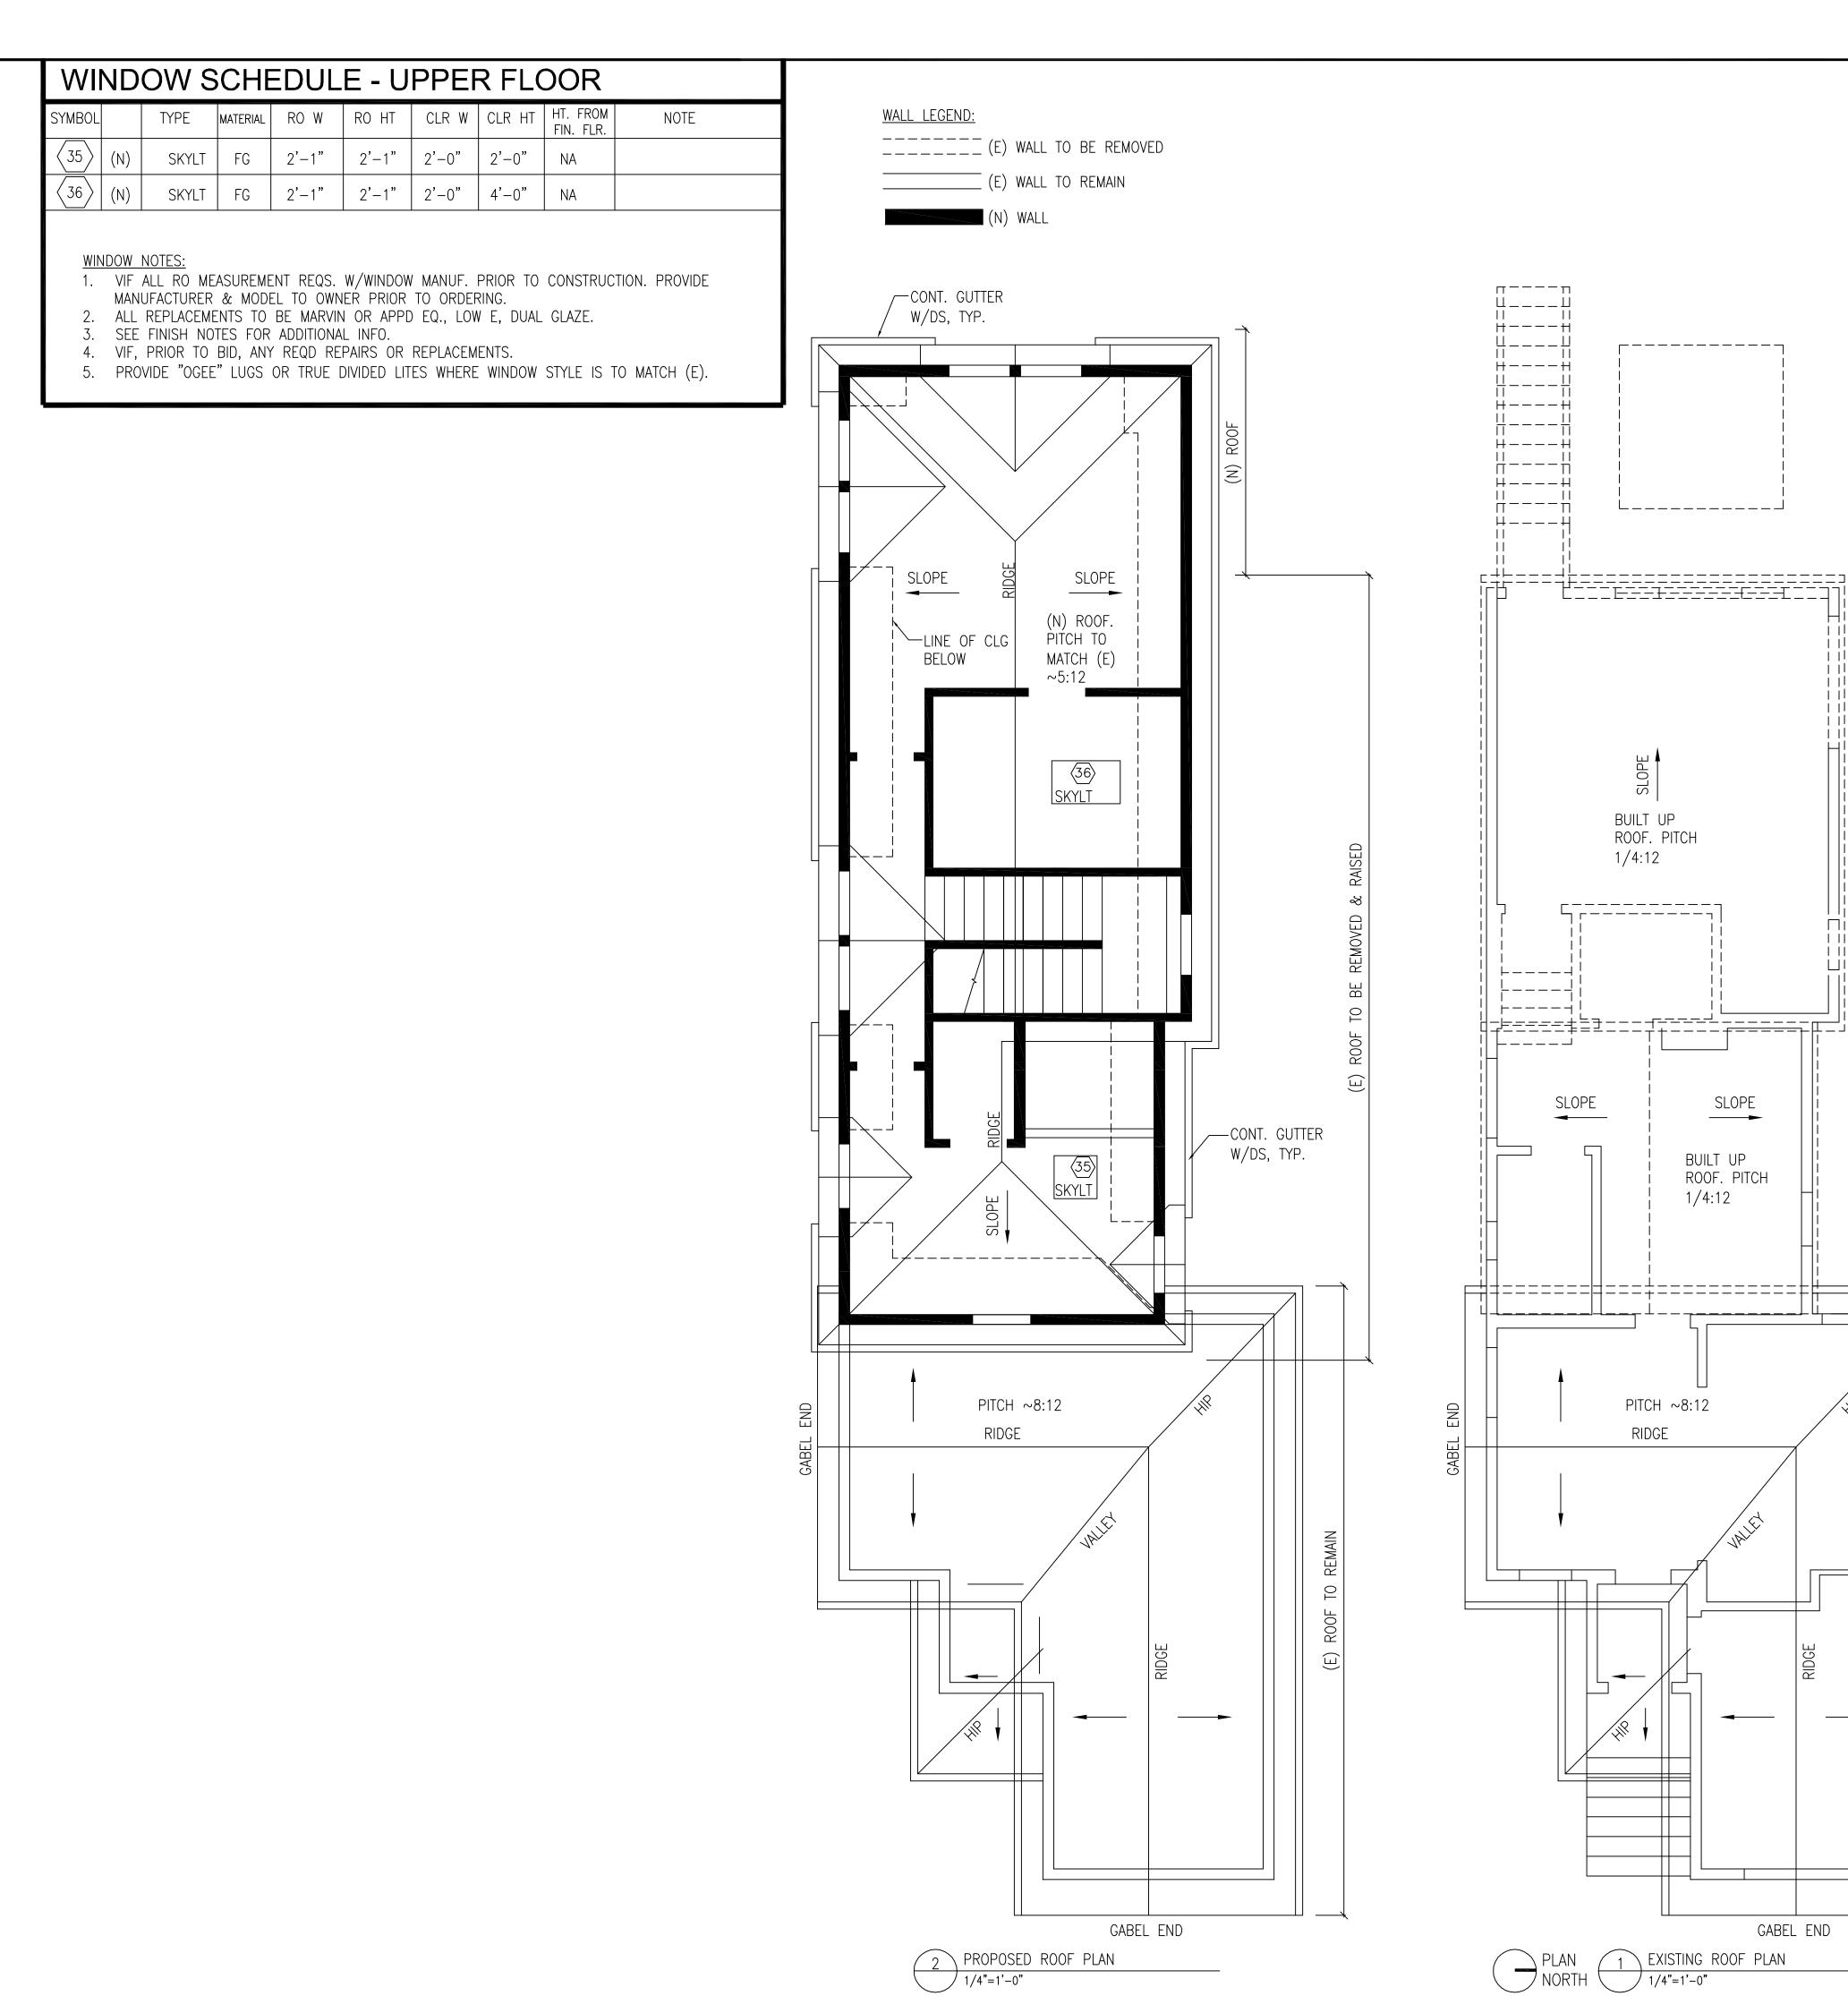SAY STREET


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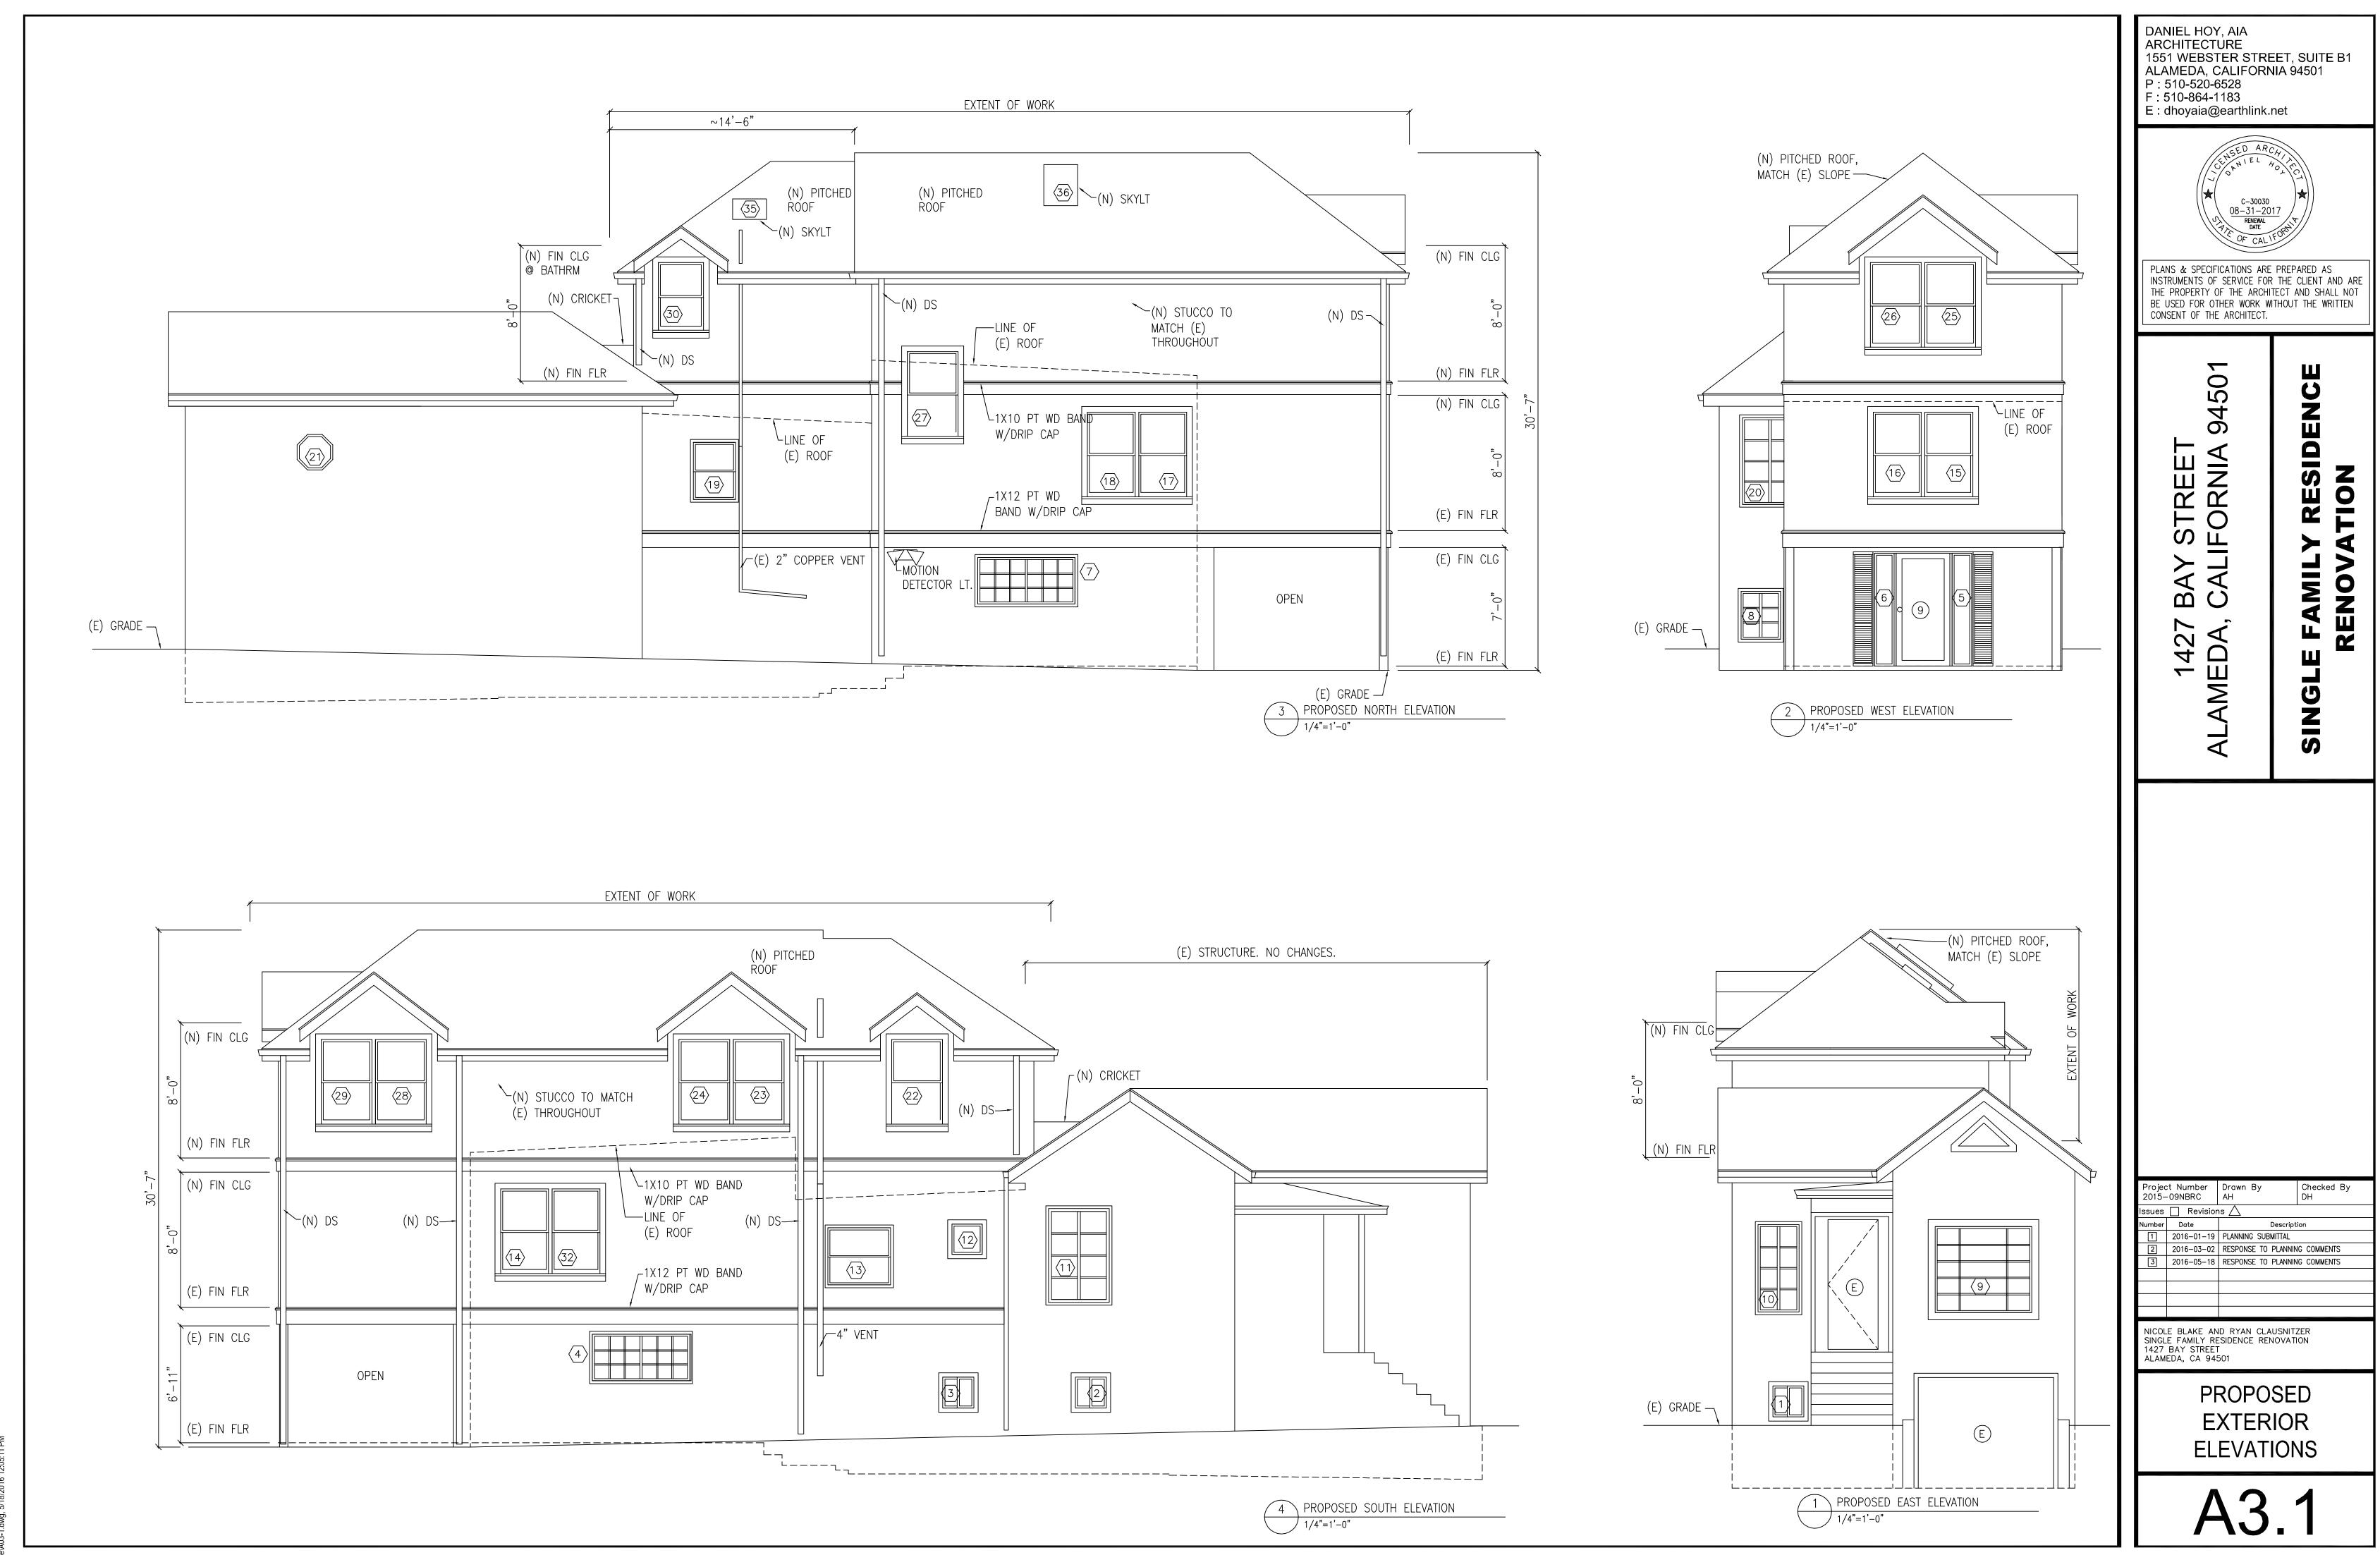
RESIDE HOL E FAMIL RENOV

,	t Number -09NBRC	Drawn By AH	Checked By DH						
Issues	Revision	ıs 🛆							
Number	Date	Description							
1	2016-01-19	PLANNING SUBMITTAL							
2	2016-03-02	RESPONSE TO PLANNING COMMENTS							
3	2016-05-18	RESPONSE TO PLANNING COMMENTS							
NICOLE BLAKE AND RYAN CLAUSNITZER SINGLE FAMILY RESIDENCE RENOVATION 1427 BAY STREET ALAMEDA, CA 94501									

EXISTING & PROPOSED **ROOF PLANS** & DETAILS

GABEL END



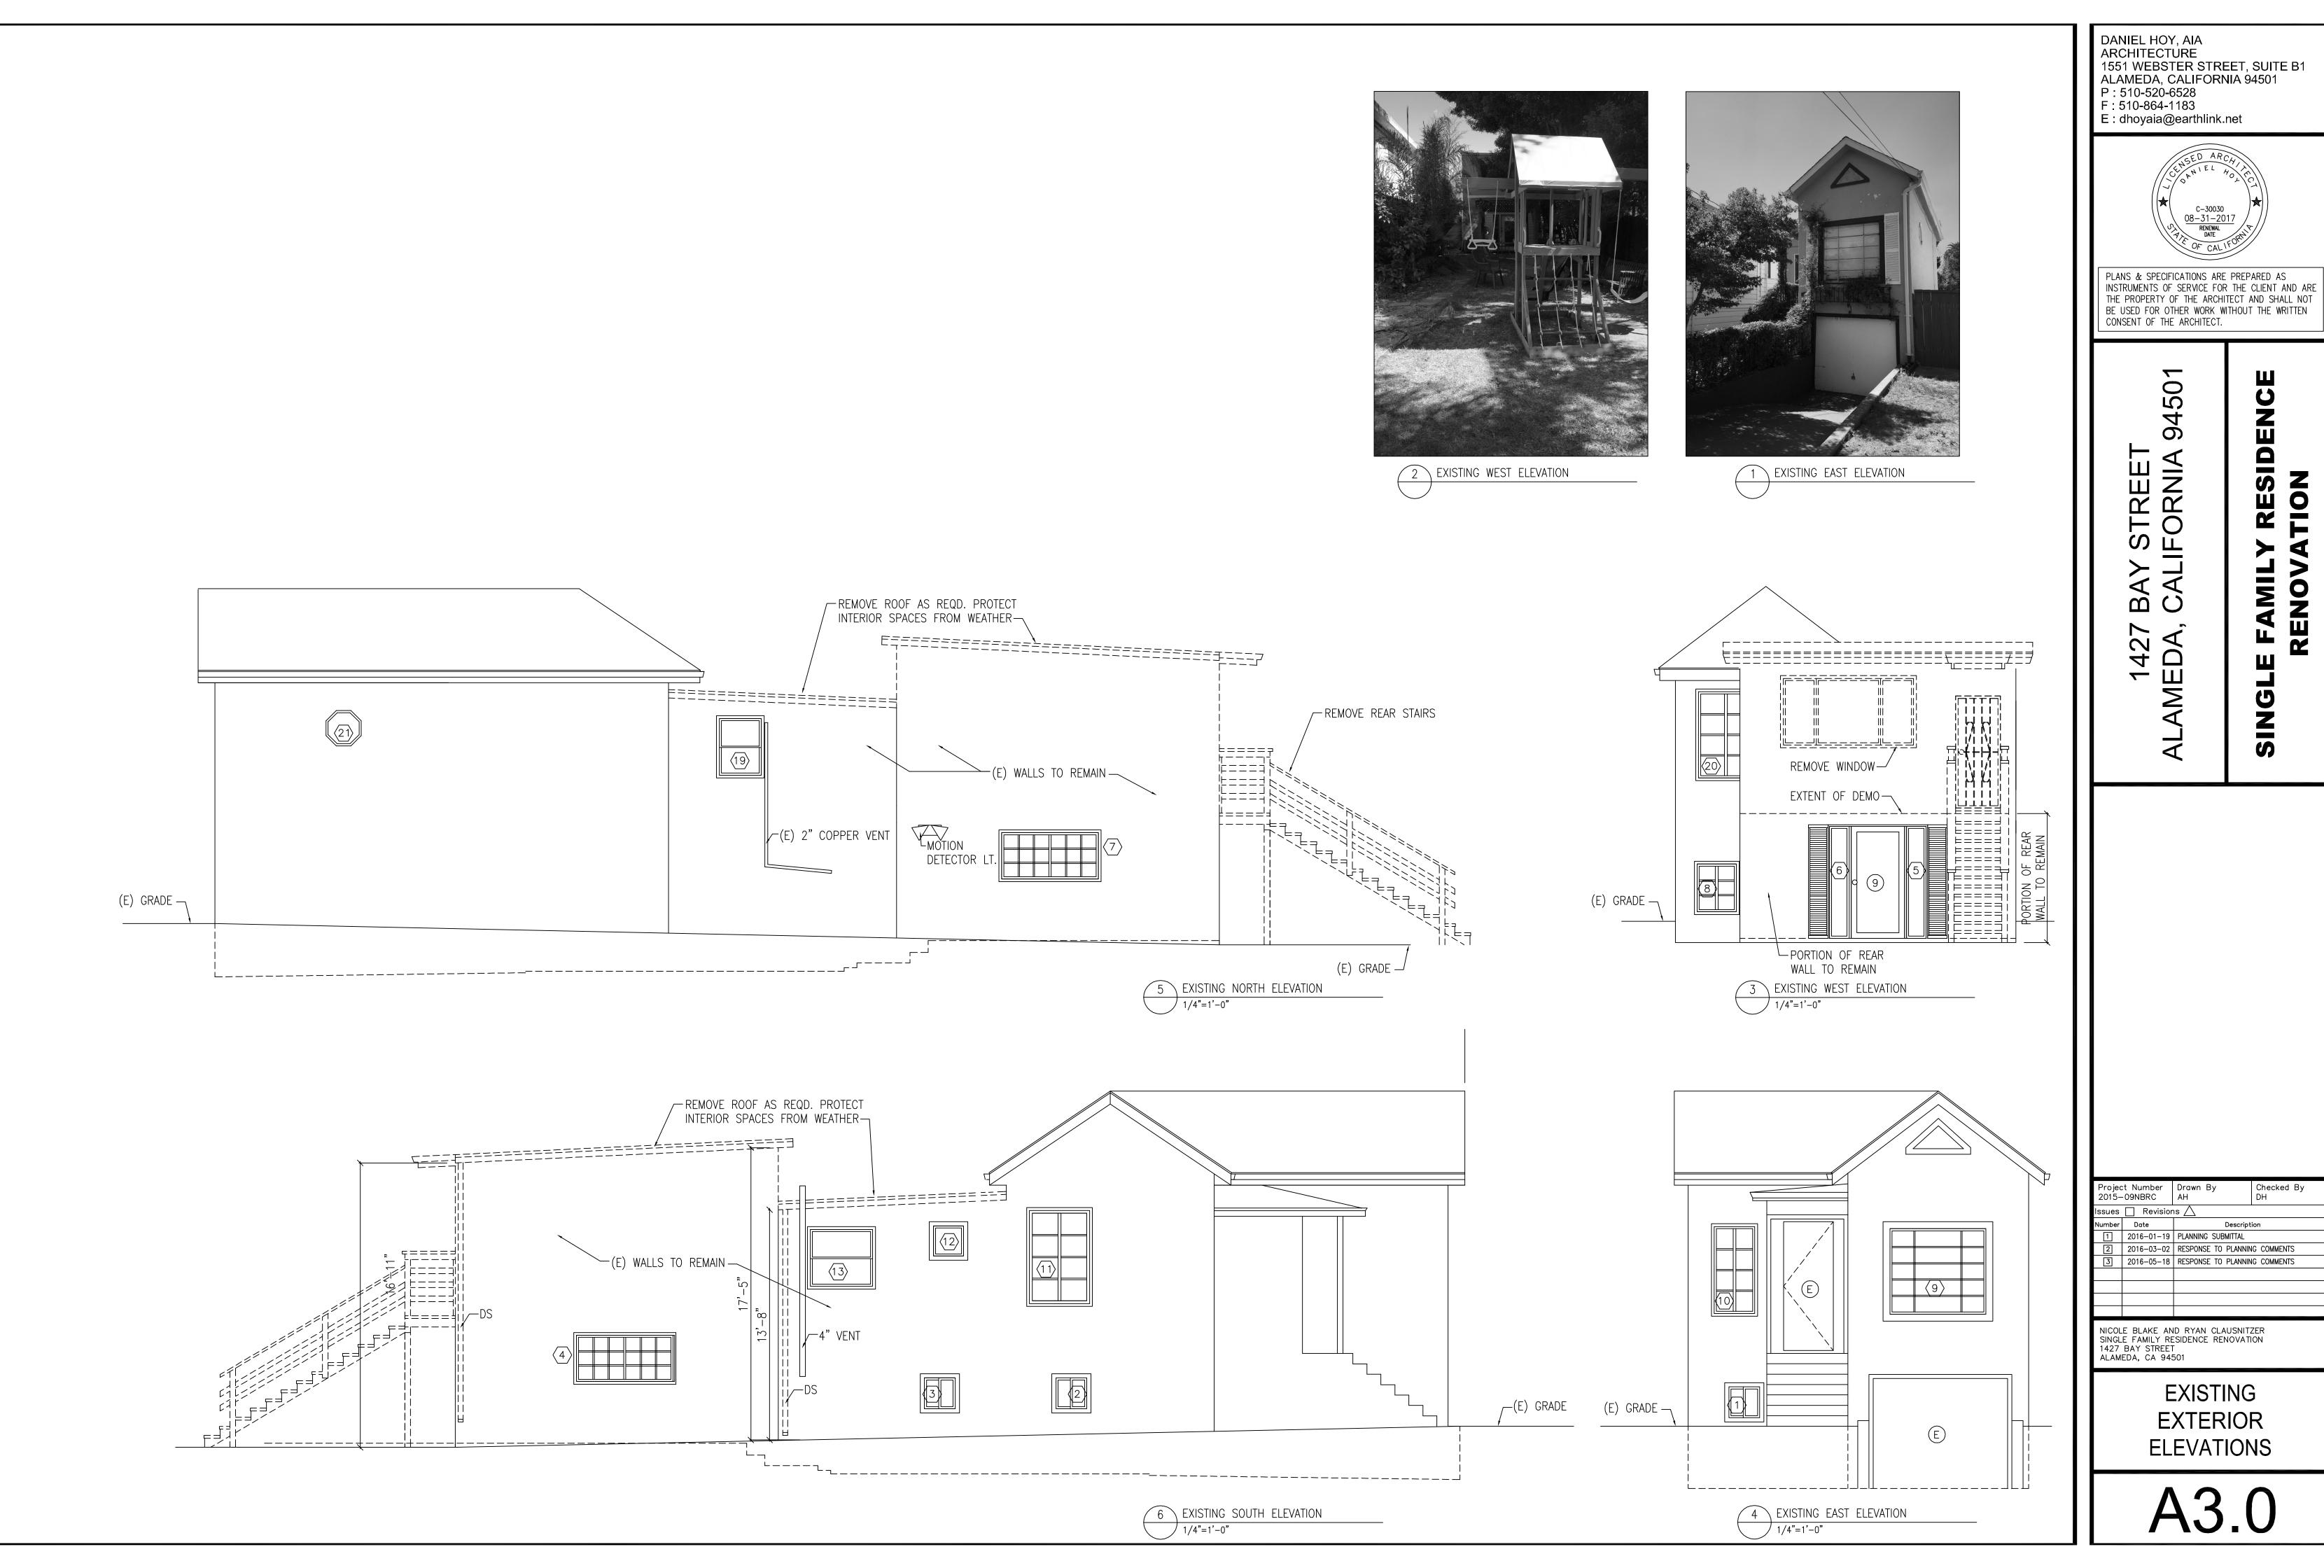

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