NEW COMMERCIAL BUILDING 1920 MINTURN STREET ALAMEDA CA 94501

GENERAL NOTES:

- ALL WORK AND MATERIALS SHALL BE IN ACCORDANCE WITH THE APPLICABLE RULES AND REGULATIONS OF STATE AND/OR LOCAL CODES, LAWS, ORDINANCES, STATUTES AND REGULATIONS. NOTHING IN THE DRAWINGS IS TO BE CONSTRUED AS REQUIRING OR PERMITTING WORK CONTRARY TO THESE APPLICABLE RULES, REGULATIONS AND CODES
- 2. THESE NOTES ARE INTENDED AS A GUIDE TO THE CONSTRUCTION REQUIREMENTS ESTABLISHED FOR THIS PROJECT. NO CONTRACTOR SHOULD ATTEMPT TO DESIGN, BID OR CONSTRUCT ANY PORTION OF THE WORK HEIRIN WITHOUT FULL UNDERSTANDING OF THE DESIGN INTENT AND APPLICABLE CODE REQUIREMENTS. THE CONTRACTOR SHOULD OBTAIN CLARIFICATION FROM THE ARCHITECT IF HE IS UNCERTAIN OF DESIGN INTENT.
- THE DESIGN PRESENTED ON THESE DRAWINGS ESTABLISHES THE GENERAL ARCHITECTURAL REQUIREMENTS FOR THE PROJECT. IT DOES NOT PRESENT ALL DETAILS REQUIRED FOR CONSTRUCTION. THE CONTRACTOR IS EXPECTED TO EXERCISE SOUND JUDGEMENT IN ACCORDANCE WITH CODE REQUIREMENTS.
- 4. THE DRAWINGS INDICATE LOCATION, DIMENSIONS, AND TYPICAL DETAILS OF CONSTRUCTION. FEATURES OF CONSTRUCTION SHOWN ARE TYPICAL AND APPLY GENERALLY FOR SIMILAR CONDITIONS. THE DRAWINGS DO NOT ILLUSTRATE EVERY CONDITION. IN THE EVENT THAT CERTAIN FEATURES ARE NOT FULLY SHOWN ON THE DRAWINGS OR CALLED FOR IN THE SPECIFICATIONS, THEIR CONSTRUCTION SHALL BE (A) OF THE SAME CHARACTER AS SHOWN FOR SIMILAR CONDITIONS; OR (B) IN ACCORD WITH CONVENTIONAL PRACTICES OF THE CBC: OR (C) AS CLARIFIED BY THR ARCHITECT. WHERE DISCREPANCIES OCCUR, THEY SHALL BE REPORTED TO THE ARCHITECT FOR RESOULUTION.
- 5. NO ONE DRAWING OR SPECIFICATION SECTION SHALL "GOVERN". CONTRACTOR SHALL CORRELATE WORK BETWEEN ARCHITECTURAL DRAWINGS AND SPECIFICATIONS AND CONSULTANT DRAWINGS AND SPECIFICATIONS. CONTRACTOR SHALL ALSO CORRELATE WORK BETWEEN DRAWINGS OF DIFFERENT SCALES WITHIN EACH SECTION. IT IS THE EXPICIT AND SPECIFIC RESPONSIBILITY OF THE CONTRACTOR TO EXAMINE THE CONTRACT DOCUMENTS IN THEIR ENTIRETY, REPORT ALL DISCREPANCIES ENCOUNTERED THEREIN TO THE ARCHITECT AND AWAIT RESOLUTION BEFORE PROCEEDING WITH ANY WORK AFFECTED BY SUCH DISCREPANCIES.
- UNLESS SHOWN OTHERWISE, DETAILS SHOWN AS "TYPICAL" APPLY WHEREVER APPROPRIATE. SPECIFIC DETAILS TAKE PRECEDENCE OVER "TYPICAL" DETAILS. SPECIFIC
- DIMENSIONS MARKED "VERIFY" ARE TO BE CHECKED FOR ACCURACY BY THE CONTRACTOR AND ALL DISCREPANCIES ARE TO BE BROUGHT TO THE ATTENTION OF THE ARCHITECT BEFORE PROCEEDING.
- 8. EXISTING SITE AND CONSTRUCTION INFORMATION IS BASED ON ORIGINAL DRAWINGS BY DEPARTMENT OF NAVY DRAWING #7429 FILMED 3/7/88
- 9. THE CONTRACTOR SHALL CAREFULLY STUDY AND COMPARE THE ARCHITECTURAL CONTRACT DOCUMENTS WITH THE STRUCTURAL DRAWINGS AS TO ALL LAYOUTS, DIMENSIONS, AND ELEVATIONS AND SHALL AT ONCE REPORT DISCOVERED ERRORS, INCONSISTENCIES, OR OMISSIONS TO THE ARCHITECT. IF THE CONTRACTOR PERFORMS ANY CONSTRUCTION ACTIVITY KNOWING IT INVOLVES A RECOGNIZED ERROR, INCONSISTENCY OR OMISSION IN TH CONTRACT DOCUMENTS WITHOUT SUCH NOTICE TO THE ARCHITECT, THE CONTRACTOR SHALL ASSUME APPROPRIATE RESPONSIBILITY FOR SUCH PERFORMANCE AND SHALL BEAR AN APPROPRIATE AMOUNT OF THE ATTRIBUTED COSTS FOR CORRECTION.
- 10. DO NOT SCALE THE DRAWINGS. LAY OUT WORK FOLLOWING WRITTEN DIMENSIONS. IF WRITTEN DIMENSIONS ARE LACKING, NOTIFY THE ARCHITECT AT ONCE. WHERE DISCREPANCIES OCCUR. THEY SHALL BE REPORTED TO THE ARCHITECT FOR RESOLUTION
- 11. DIMENSIONS ARE GIVEN TO FACE OF FINISH UNLESS OTHERWISE NOTED ON THE DRAWINGS.
- 12. THE CONTRACTOR SHALL BE DEEMED TO HAVE INSPECTED THE SITE AND VERIFIED ACTUAL GRADES, ELEVATIONS, DIMENSIONS, AND DECLINATIONS AND THE TRUE CONDITIONS UNDER WHICH WORK IS TO BE PERFORMED. ANY DISCREPANCIES SHALL BE CALLED TO THE ATTENTION OF THE ARCHITECT BEFORE PROCEEDING WITH THE WORK.
- 13. ALL CONDITIONS AFFECTING WORK PROGRESS AND CONFORMANCE TO PLANS AND SPECIFICATIONS SHALL BE VERIFIED BY THE CONTRACTOR PRIOR TO START OF WORK.
- 14. ANY SITE AND BUILDING AREAS UNAFFECTED BY THIS WORK SHALL BE PROTECTED FROM ANY DAMAGE CAUSED BY THIS WORK. ANY DAMAGE TO EXISTING STRUCTURES AND BUILDING ELEMENTS SO CALLED SHALL BE THE FINANCIAL RESPONSIBILITY OF THE CONTRACTOR.
- 15. THE CONTRACTOR SHALL PATCH ALL AREAS OF EXISTING BUILDING WHICH ARE IN NEED OF SUCH WORK AS A RESULT OF DEMOLITION, INSTALLATION OF NEW ITEMS, OR NEW CONSTRUCTION.
- 16. ANY WASTE AND REFUSE CAUSED BY THIS WORK SHALL BE REMOVED FROM THE PREMISES AND DISPOSED OF BY THE CONTRACTOR IN A LEGAL MANNER.
- 17. INFORMATION SHOWN IN DRAWINGS REGARDING EXISTING CONSTRUCTION IS APPROXIMATE. CONTRACTOR SHALL SURVEY EXISTING CONDITIONS AND VERIFY DETAILED CHARACTERISTICS AFFECTING THE WORK OF THIS CONCTRACT. ANY DISCREPANCIES SHALL BE CALLED TO THE ATTENTION OF THE ARCHITECT BEFORE PROCEEDING WITH THE WORK.
- 18. EXIT DOOR HARDWARE SHALL BE OPENABLE FROM THE INSIDE WITHOUT THE USE OF A KEY OR ANY SPECIAL KNOWLEDGE OR EFFORT.
- 19. BROOM CLEAN CONSTRUCTION PREMISES AT THE END OF EACH DAY AND FINAL CLEANING TO INCLUDE EXISTING WINDOWS AND MINIBLINDS AT THE END OF THE JOB.
- 20. MATERIALS, ASSEMBLIES AND SYSTEMS SHOWN ARE NEW UNLESS NOTES AS EXISTING OR (E).

ABBREVIATIONS:

NOTE: ALL ABBREVIATIONS MAY NOT BE USED.

AREA DRAIN ADJACENT/ADJUSTABLE ABOVE FINISHED FLOOR BLDG. BUILDING CAB. CABINET CALIFORNIA BUILDING CODE (TITLE 24) CENTERLINE CLEAN OUT CLR. CLEAR CONC. CONCRETE DIA. DIAMETER DOUGLAS FIR DN. DOWN DWG. DRAWING DRAWER EA. EACH EL. **ELEVATION** EXISTING ÈΧT. **EXTERIOR** F.D. FLOOR DRAIN GALV. GALVANIZED

PLASTER

F.T.

GSM

LAV

GYP. BD. GYPSUM WALL BOARD

FINISHED OPENING

FIRE TREATED

HANDICAPPED

INSIDE DIAMETER

HEIGHT

MANUF. MANUFACTURER

SYMBOLS:

ELEVATION

DETAIL

<1>DOOR TAG

NEW DOOR

WINDOW TAG

REVISION

ALIGN SURFACES

GRID LINE REFERENCE

- DRAWING NUMBER

- DRAWING NUMBER

DOOR NOTE NUMBER

REUSE EXISTING DOOR

EXISTING DOOR TO REMAIN

-SHEET WHERE DRAWN

-SHEET WHERE DRAWN

LAVATORY

GYPSUM FIBER REINFORCED ELECTRIC OR ELECTRICAL GALVANIZED SHEET METAL

M.B.

MET.

M.R.

MTD.

O.C.

PAINTED PRESSURE TREATED RADIUS ROOF DRAIN REFRIGERATOR REQUIRED ROUGH OPENING SEE ARCHITECTURAL DRAWINGS SEE ELECTRICAL DRAWINGS SQUARE FEET SHEET SIMILAR SEE MECHANICAL DRAWINGS SHEET METAL SCREW SEE PLUMBING DRAWINGS STAINLESS STEEL SEE STRUCTURAL DRAWINGS STEEL TYPICAL UNIFORM BUILDING CODE UNLESS OTHERWISE NOTED VERIFY IN FIELD WATER CLOSET WATER PROOF WATER RESISTANT BARRIER

MACHINE BOLT

NOT TO SCALE

OUTSIDE DIAMETER

ON CENTER

OPENING

PLYWOOD

MOISTURE RESISTANT

METAL

NEW

MOUNTED

MOUNTING

SCOPE OF WORK:

REMOVE EXISTING BUILDING OF 4847 SF. CONSTRUCT NEW COMMERCIAL BUILDING

PROJECT DATA:

APPLICABLE CODES & REGULATIONS: ALL WORK SHALL BE PERFORMED TO THE FOLLOWING CODES:

2016 EDITION CALIFORNIA BUILDING CODE CALIFORNIA FIRE CODE 2016 EDITION CALIFORNIA ADMINISTRATIVE CODE (T-24)2016 EDITION CALIFORNIA MECHANICAL CODE 2016 EDITION CALIFORNIA PLUMBING CODE 2016 EDITION CALIFORNIA ELECTRICAL CODE 2016 EDITION CALIFORNIA ENERGY CODE 2016 EDITION CITY OF ALAMEDA MUNICIPAL CODES CURRENT EDITION

10780 SF

Alameda

SITE

CONSTRUCTION TYPE:

TYPE V SPRINKLERED

OCCUPANCY CLASSIFICATION:

B OFFICE BUILDING

1 W/MEZZANINE

NUMBER OF STORIES

FLOOR AREA: NEW GROUND FLOOR: 8260 SF MEZZANINE AREA:

PARKING:

Harbor

Eagle Ave

Littlejohn 6

Paik

Lincoln Ave

Santa Clara Ave

OPEN PARKING: EXISTING COVERED PARKING: PROPOSED COVERED PARKING:

BICYCLE PARKING (SEE SHT A2 FOR LOCATION) PARKING TYPE REQUIRED # PROPOSED # SHORT-TERM LONG-TERM

DRAWING INDEX:

ARCHITECTURAL:

COVER SHEET A-1SITE PLAN LANDSCAPE PLAN A-2

A-2.BICYCLE LOCKER & RACK SPECIFICATIONS BUILDING PLANS & SCHEDULES A-3A-4REFLECTED CEILING PLANS & DETAILS

A - 5PROPOSED ELEVATIONS

A - 5.1SECTIONS STREET VIEW ELEVATIONS

DEFERRED SUBMITTALS

1. AUTOMATIC FIRE SPRINKLER SYSTEM AND FIRE ALARM MONITORING SYSTEM.

LOCATION MAP:

PROJECT ROSTER:

Dennison St

States Naval


ALAMEDA CA 94501

ARCHITECT:

220 COLUMBIA AVENUE KENSINGTON, CA 94708 MOBILE: (510) 851-2387 FAX: (510) 525-3140

STRUCTURAL ENGINEER: BASELINE DESIGNS, INC. 1700 OAK STREET


VOICE: (510) 865-4623 FAX: (510) 865-4704

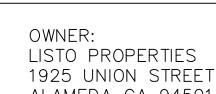

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REVISIONS: DESIGN REVIEW 2019-05-13 DESIGN REVIEW 2019-09-12 DESIGN REVIEW 2019-10-14


NEW COMMERCIAL STRUCTURE

1920 MINTURN STREET ALAMEDA, CA 94501

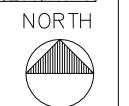DRAWING TITLE COVER SHEET

PROJECT No. :	201704LP
DRAWN BY:	DH
CHECKED BY:	IAC
DATE:	
SCALE:	AS NOTED


SHEET NO .:

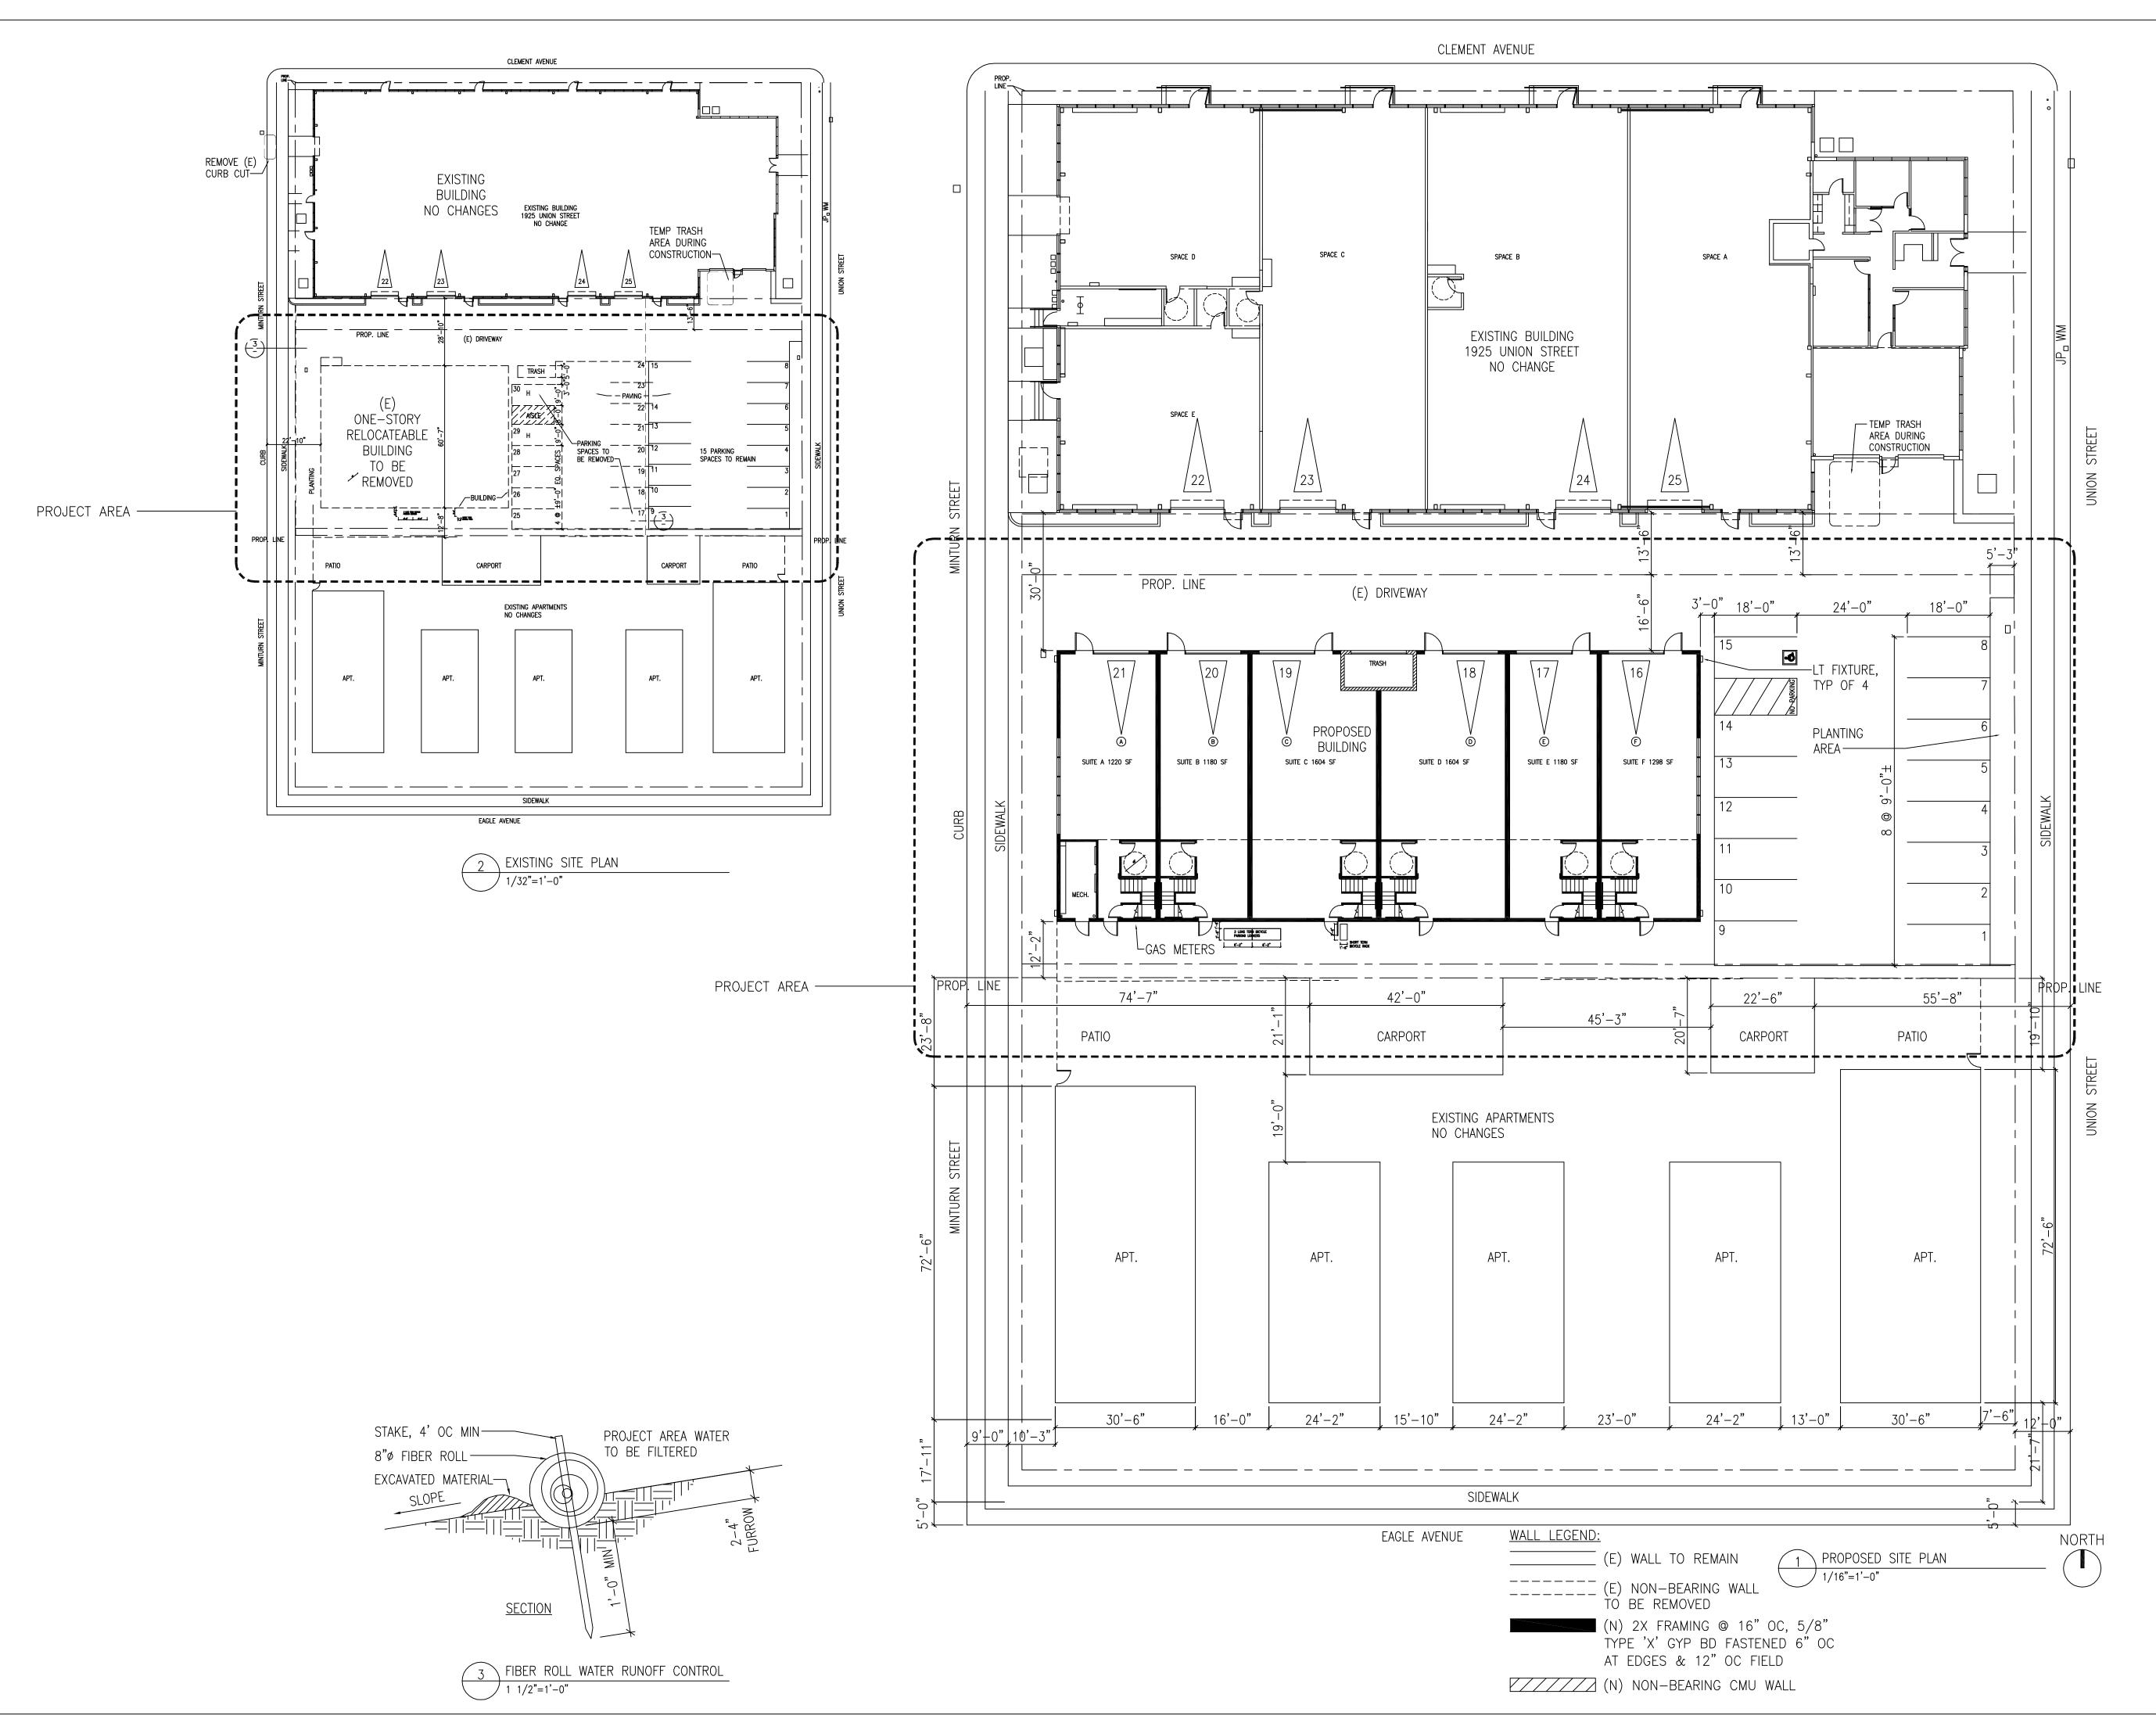

ITALO A. CALPESTRI III

& ASSOCIATE

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OWNER

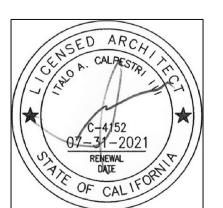
CTAME

REVISIONS:		
No.	DESCRIPTION	DATE
1	DESIGN REVIEW	2019-05-13
2	DESIGN REVIEW	2019-09-12
$\overline{\Lambda}$	DESIGN REVIEW	2019-10-14

PROJECT
NEW COMMERCIAL STRUCTURE
1920 MINTURN STREET
ALAMEDA, CA 94501


drawing title SITE PLAN

PROJECT No. :	201704LP
DRAWN BY:	DH
CHECKED BY:	IAC
DATE:	
SCALE:	AS NOTED
SHEET NO.:	A — 1

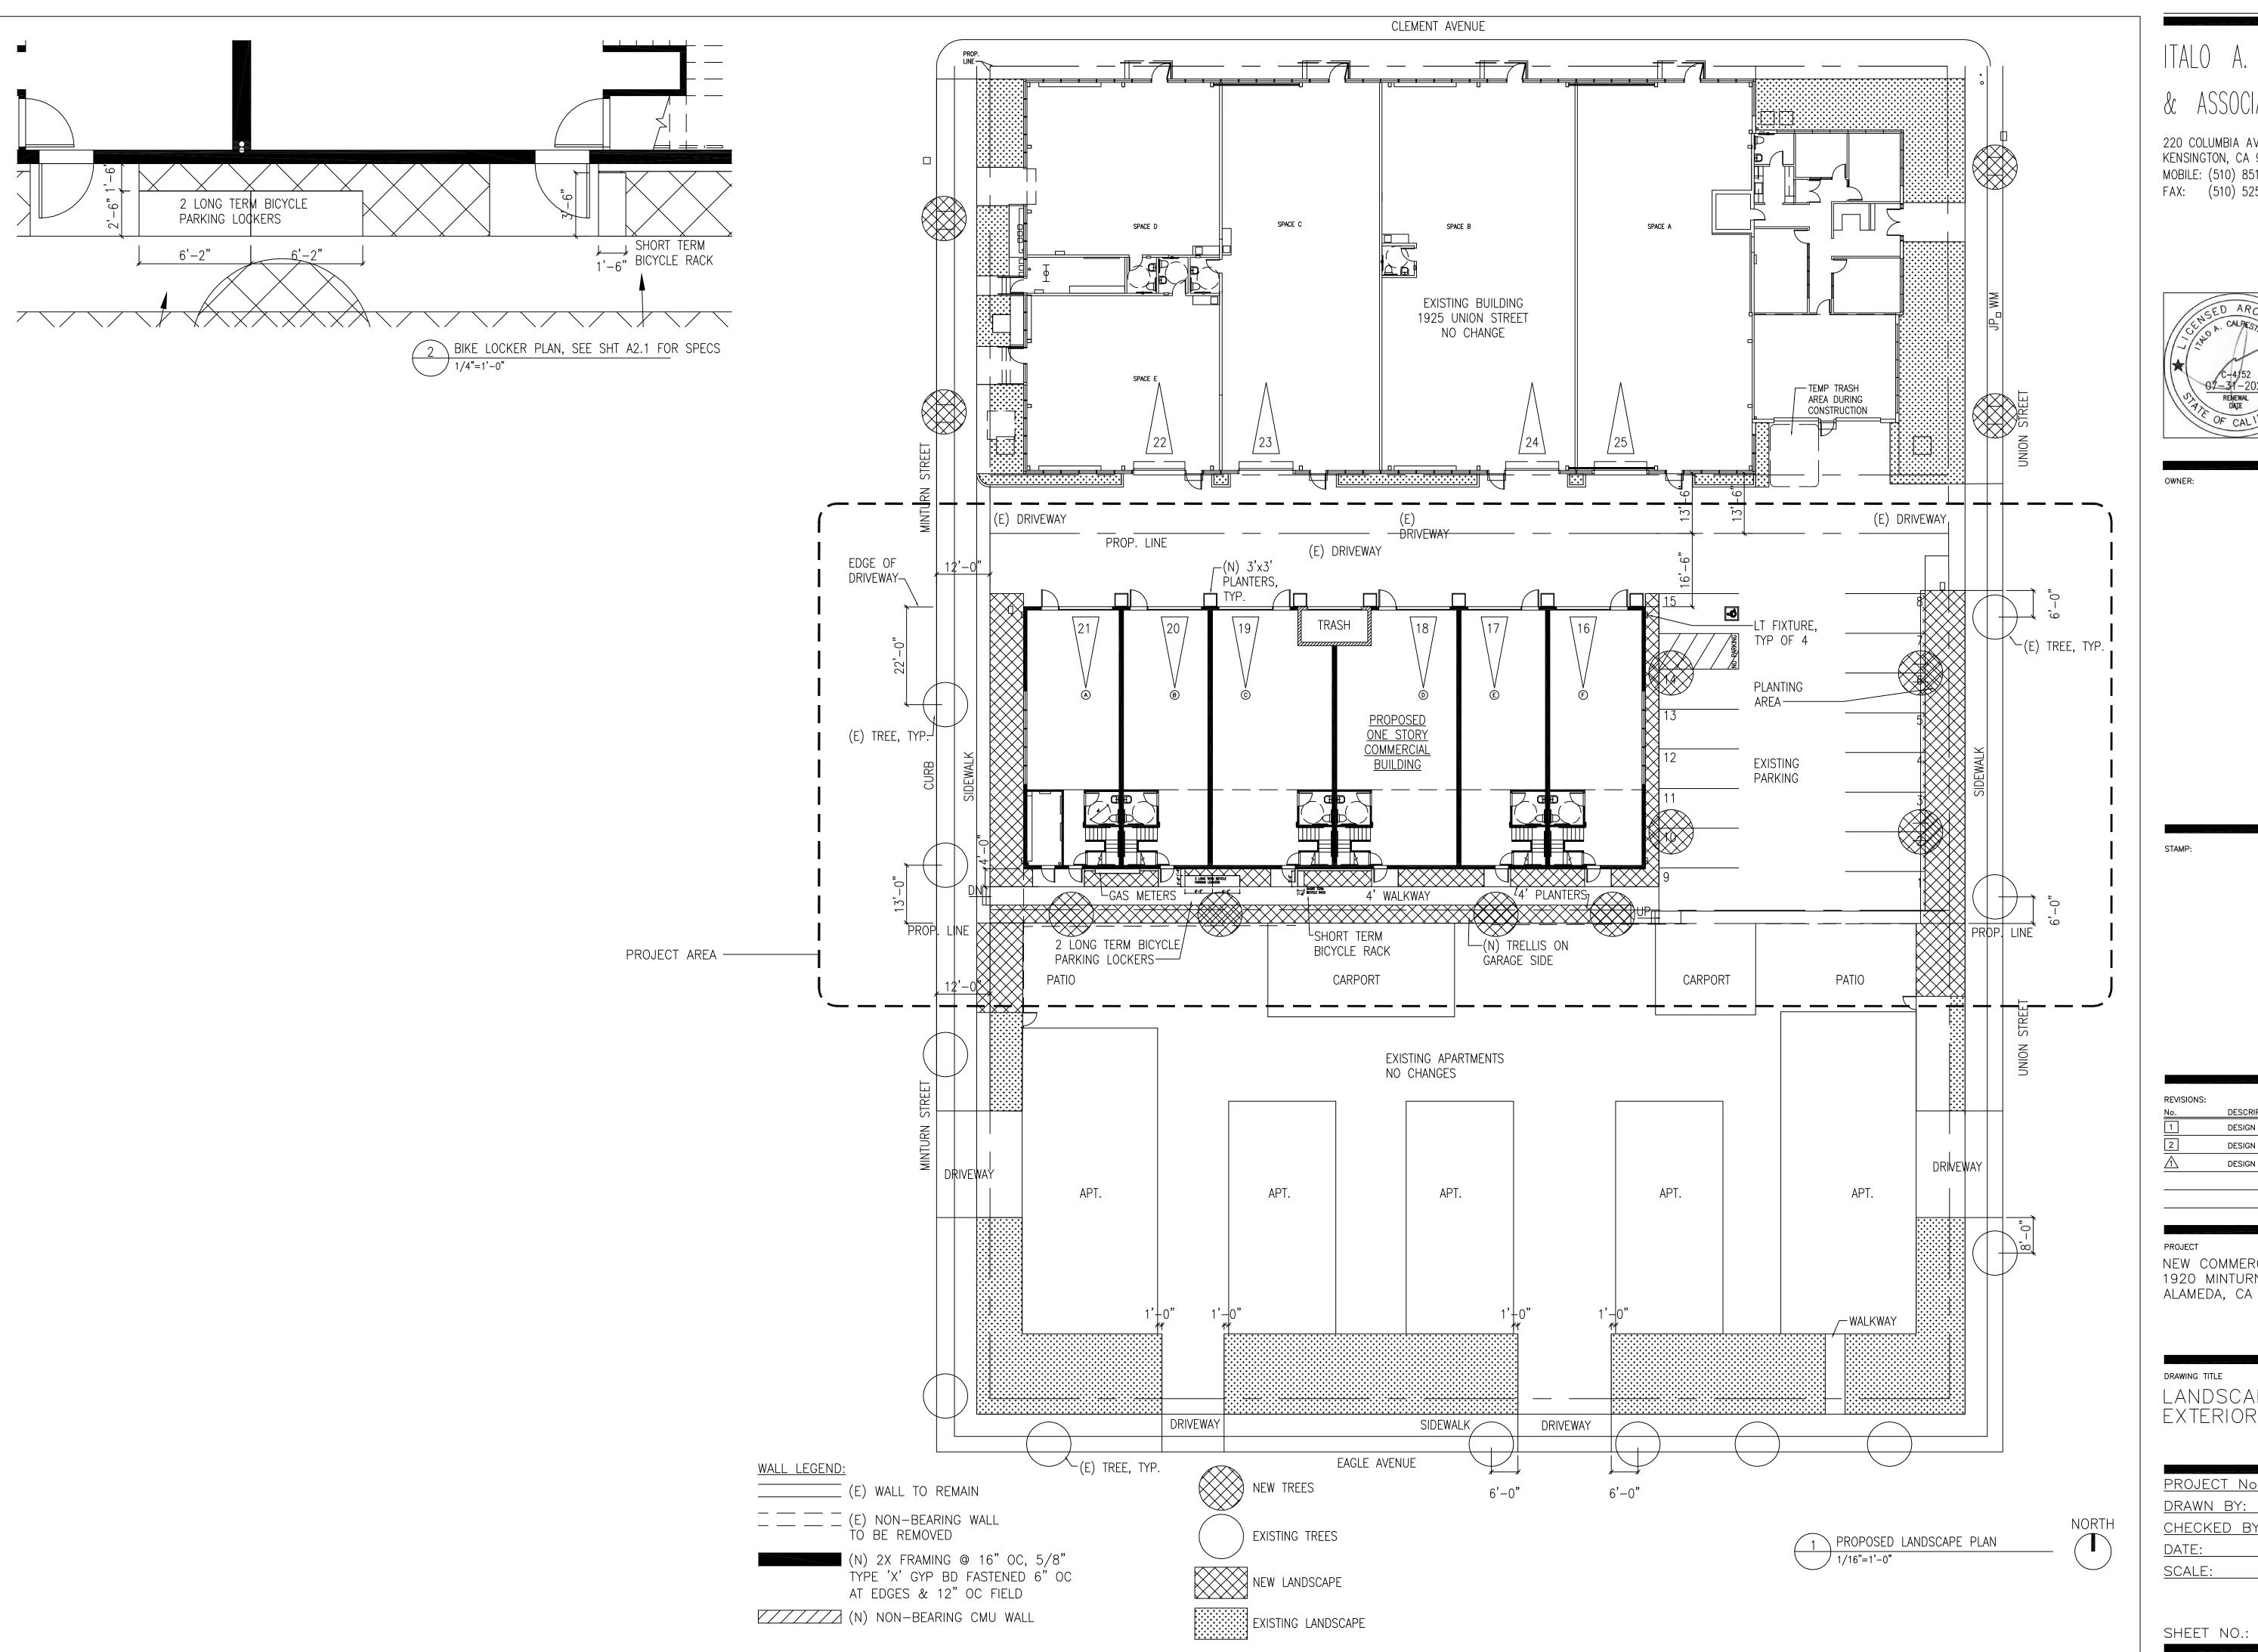

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No.	DESCRIPTION	DATE
1	DESIGN REVIEW	2019-05-13
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$\overline{\Lambda}$	DESIGN REVIEW	2019-10-14

NEW COMMERCIAL STRUCTURE 1920 MINTURN STREET ALAMEDA, CA 94501

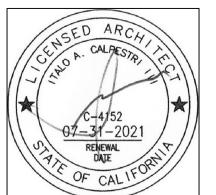DRAWING TITLE LANDSCAPE PLAN EXTERIOR LIGHTING

PROJECT No.:	201704LP
DRAWN BY:	DH
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DATE:	
SCALE:	AS NOTED
	\wedge

Cycle Stall Basic Installation - Racks



*Tools Needed for Installation

- 9/16" socket set
- (2) 4"x4"x28" (or larger) blocks (4) bolts, nuts & washers for each rack. If using tamper resistant nuts, install two tamper-resistant & two standard nuts with each rack.


Installation steps:

- 1. Lay out the two channel beams where the rack will be placed. Place both beams on top of the two blocks of wood so that the open part of the channel faces the ground.
- 2. Place racks on beams so holes in rack flanges line up with beam slots.
- 3. Put bolts through Hoop Rack flange holes & beams so bolt head faces up. HAND tighten the nuts using new flange nuts.
- 4. Once nuts are on, tip assembled rack over & use a 9/16" socket to tighten nuts. Before tightening nuts, make sure the racks are straight on beams. If using tamper resistant nuts, use access tool to tighten nuts. Do not over tighten the tamper resistant nuts. Tip rack upright.


Anchoring Rails:


To anchor the rails to concrete, place 3.75" wedge anchor through holes in the rail into the concrete. Secure with nut.


If anchoring to asphalt surface, use Titen asphalt screws. Place screws through rail holes and turn into the asphalt.

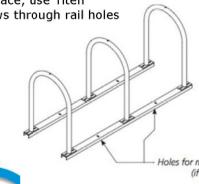

Page 2 of 3

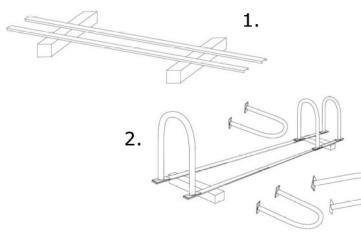

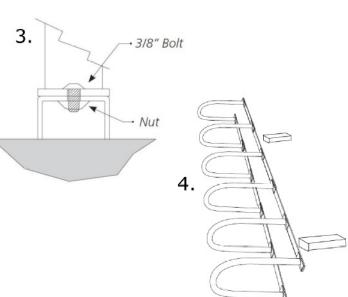

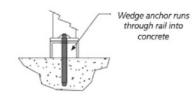


Holes for mounting to surface American Bicycle Security Company P.O. Box 7359 Ventura, CA 93006

> Ph: (800) 245-3723 or (805) 933-3688 Fax: (805) 933-1865 www.ameribike.com Email: turtle@ameribike.com

Cycle Stall Basic



One car or ten bikes? Maximize parking for customers at your business with on-street bike parking. The Cycle Stall Basic kit covers the needs of cities and businesses that want to provide an on-street bike corral at a low cost and minimal changes to nfrastructure. Designed to fit within a standard size car parking space, the Cycle Stall Basic comes in standard single or double length kits, or can be customized to suit your needs. The bike racks may also be mounted to the rails at 45 degree angles.

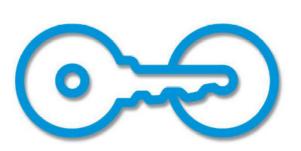

American Bicycle Security Company P.O. Box 7359 Ventura, CA 93006 (800) 245-3723 or (805) 933-3688 Fax: (805) 933-1865 <u>www.ameribike.com</u> Email: <u>turtle@ameribike.com</u>

Cycle Stall Basic Wheel Stops & Delineators





Cycle Stall Basic



*Tools Needed for Installation

Hammer Drill with 3/8" masonry bit

Socket Wrench 3/8" Hammer (if installing into concrete with wedge anchors)

Page **3** of **3**

*Site Safety: Before installation, ensure work site is safe. If necessary, block off the area to prevent vehicle and pedestrian access. Use appropriate signage and work barricades to delineate the work area. Ensure electric power leads and hand tools are safe, in good working condition and only used as per manufacturer's specifications. Remove any potential trip hazards and use appropriate personal safety equipment (safety gloves, safety glasses, safety boots, etc.).

Wheel Stop Installation:

- 1. Place wheel stop in desired location using setbacks diagram on page 2 as a guide. Mark holes onto surface and remove wheel stop.
- 2. Drill 3/8" holes though asphalt surface.
- 3. Line up holes in wheel stops with holes in road surface and use 3/8" socket wrench to secure the provided anchors.



Two 48" tall traffic delineators are included to protect your installation from damage by vehicles. Three delineators are included with the double-sized kit.

The delineators are secured to the ground with an epoxy cement and include two bands of reflective tape for greater visibility in low light.

American Bicycle Security Company

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Ventura, CA 93006

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Email: turtle@ameribike.com


Cycle Stall Basic Single: 10 Bikes Double: 22 Bikes Hoop Racks: 1.5" schedule 40 pipe (1.9" OD) Wheel Stops: Recycled plastic Standard options: Galvanized Rails, Galvanized Racks Powder Coated Racks RAL 9003 RAL 1023 Flat Black RAL 6005 RAL 5005 Racks also available in PVC, Thermoplastic, or Stainless steel (depending on rack) Installation Rail mount - Hoop Racks are mounted to galvanized rails Methods which should be anchored to the ground. Space Use Curb Setbacks:

& Setbacks Minimum: 44" **Traffic Lane Setbacks:**


Page 1 of 3


Minimum: 44"

Wheel Stop Setbacks:

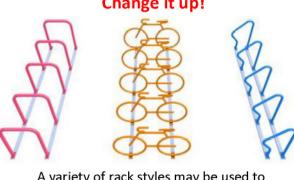

A variety of rack styles may be used to build your bike corral.

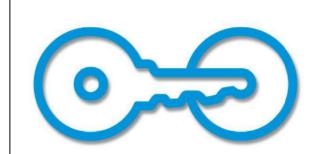

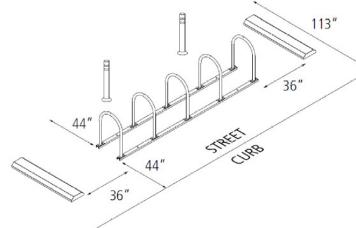


Allow minimum of 36" between wheel stops and racks.

American Bicycle Security Company P.O. Box 7359

Ventura, CA 93006 Ph: (800) 245-3723 or (805) 933-3688 Fax: (805) 933-1865 www.ameribike.com Email: turtle@ameribike.com



Bike-Shell™ Model 351

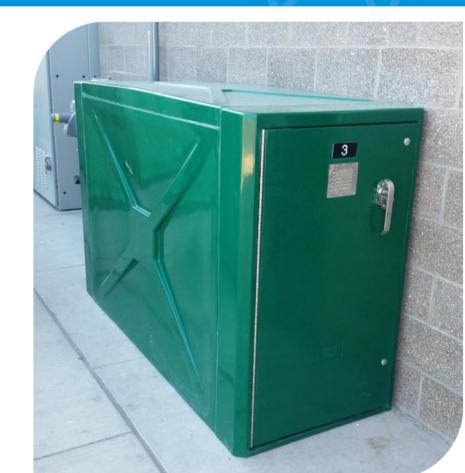

High security due to built-in door locks with concealed hinges. Locking bar from top to bottom of door.



MADE IN THE

Models 351, & 352 are our op of the line bike lockers, more durable, more attractive and lower maintenance than all others.

Preferred choice by transit agencies across the country.

iberglass reinforced plastic onstruction is highly esistant to impact and scratching.

The finish never needs painting, will not rust or corrode and is extremely esistant to most stains.

The standard key-lock mechanism is completely internal and resists ampering.

Reduced costs due to low naintenance and long life.

nerican Bicycle Security Company P.O. Box 7359 Ventura, CA 93006

Bike-Shell™ Model 351

1 door/1 Bike

(800) 245-3723 or (805) 933-3688 Fax: (805) 933-1865 www.ameribike.com Email: turtle@ameribike.com

Molded composite lockers shall be manufactured with

fiberglass reinforced plastic with a smooth "X" and "Y"

frame and stippled door. Finish allows easy removal of graffiti and is resistant to impact, scratches and U.V.

damage. Lockers shall not use an external or internal

frame. Walls and top shall be double wall construction

for high strength and insolation from the elements resists impact plus chemicals and stains. Materials will

weather/environmental conditions. The locker body

Number plates recessed in face of door. Stainless steel louvered vents. Gear hooks for riding accessories.

Internal heavy duty locking hardware consists of a sliding locking bar, 4feet, 2 inches in length which is

secured to the door with ½ inch stainless steel bolts

is controlled by stainless steel cams attached to the

fasteners and assembly hardware is zinc plated or

Adjustable anchor brackets with stainless steel 3/8"

removable plug-type cylinder. Lock is recessed in the

 Heavy duty stainless steel Padlock/U-Lock handle will accommodate high security Padlocks and U-Locks. For

anchors allow leveling of lockers.

2 Standard Lock Options (No charge)

•High-security, T-Handle Abloy cylinder lock,

shaft of the lock. High quality heavy duty gauge

and rides on Teflon washers. Movement of locking bar

stainless steel continuous door hinge with not rust. All

components shall be joined by internal fasteners.


withstand extremes in temperature and other


Please allow 5ft clearance for both doors


pattern on stippled walls and top, with smooth door

Bike-Shell™ Model 351



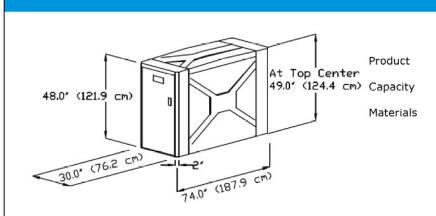

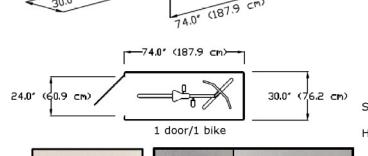


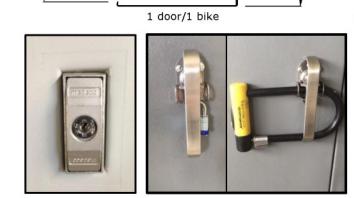

T-Handle Padlock/U-Lock Handle *Please specify Door



grouping of units.

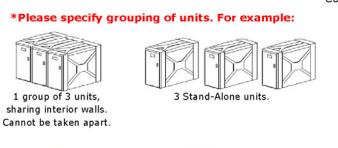




U-Locks from 1/2" to 3/4" Diameter. Padlocks and U-Locks not included. 7 Standard Color Options (No charge) Please call for custom color, or color match information

American Bicycle Security Company P.O. Box 7359 Ventura, CA 93006 Ph: (800) 245-3723 or (805) 933-3688 Fax: (805) 933-1865 www.ameribike.com Email: turtle@ameribike.com

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& ASSOCIATES

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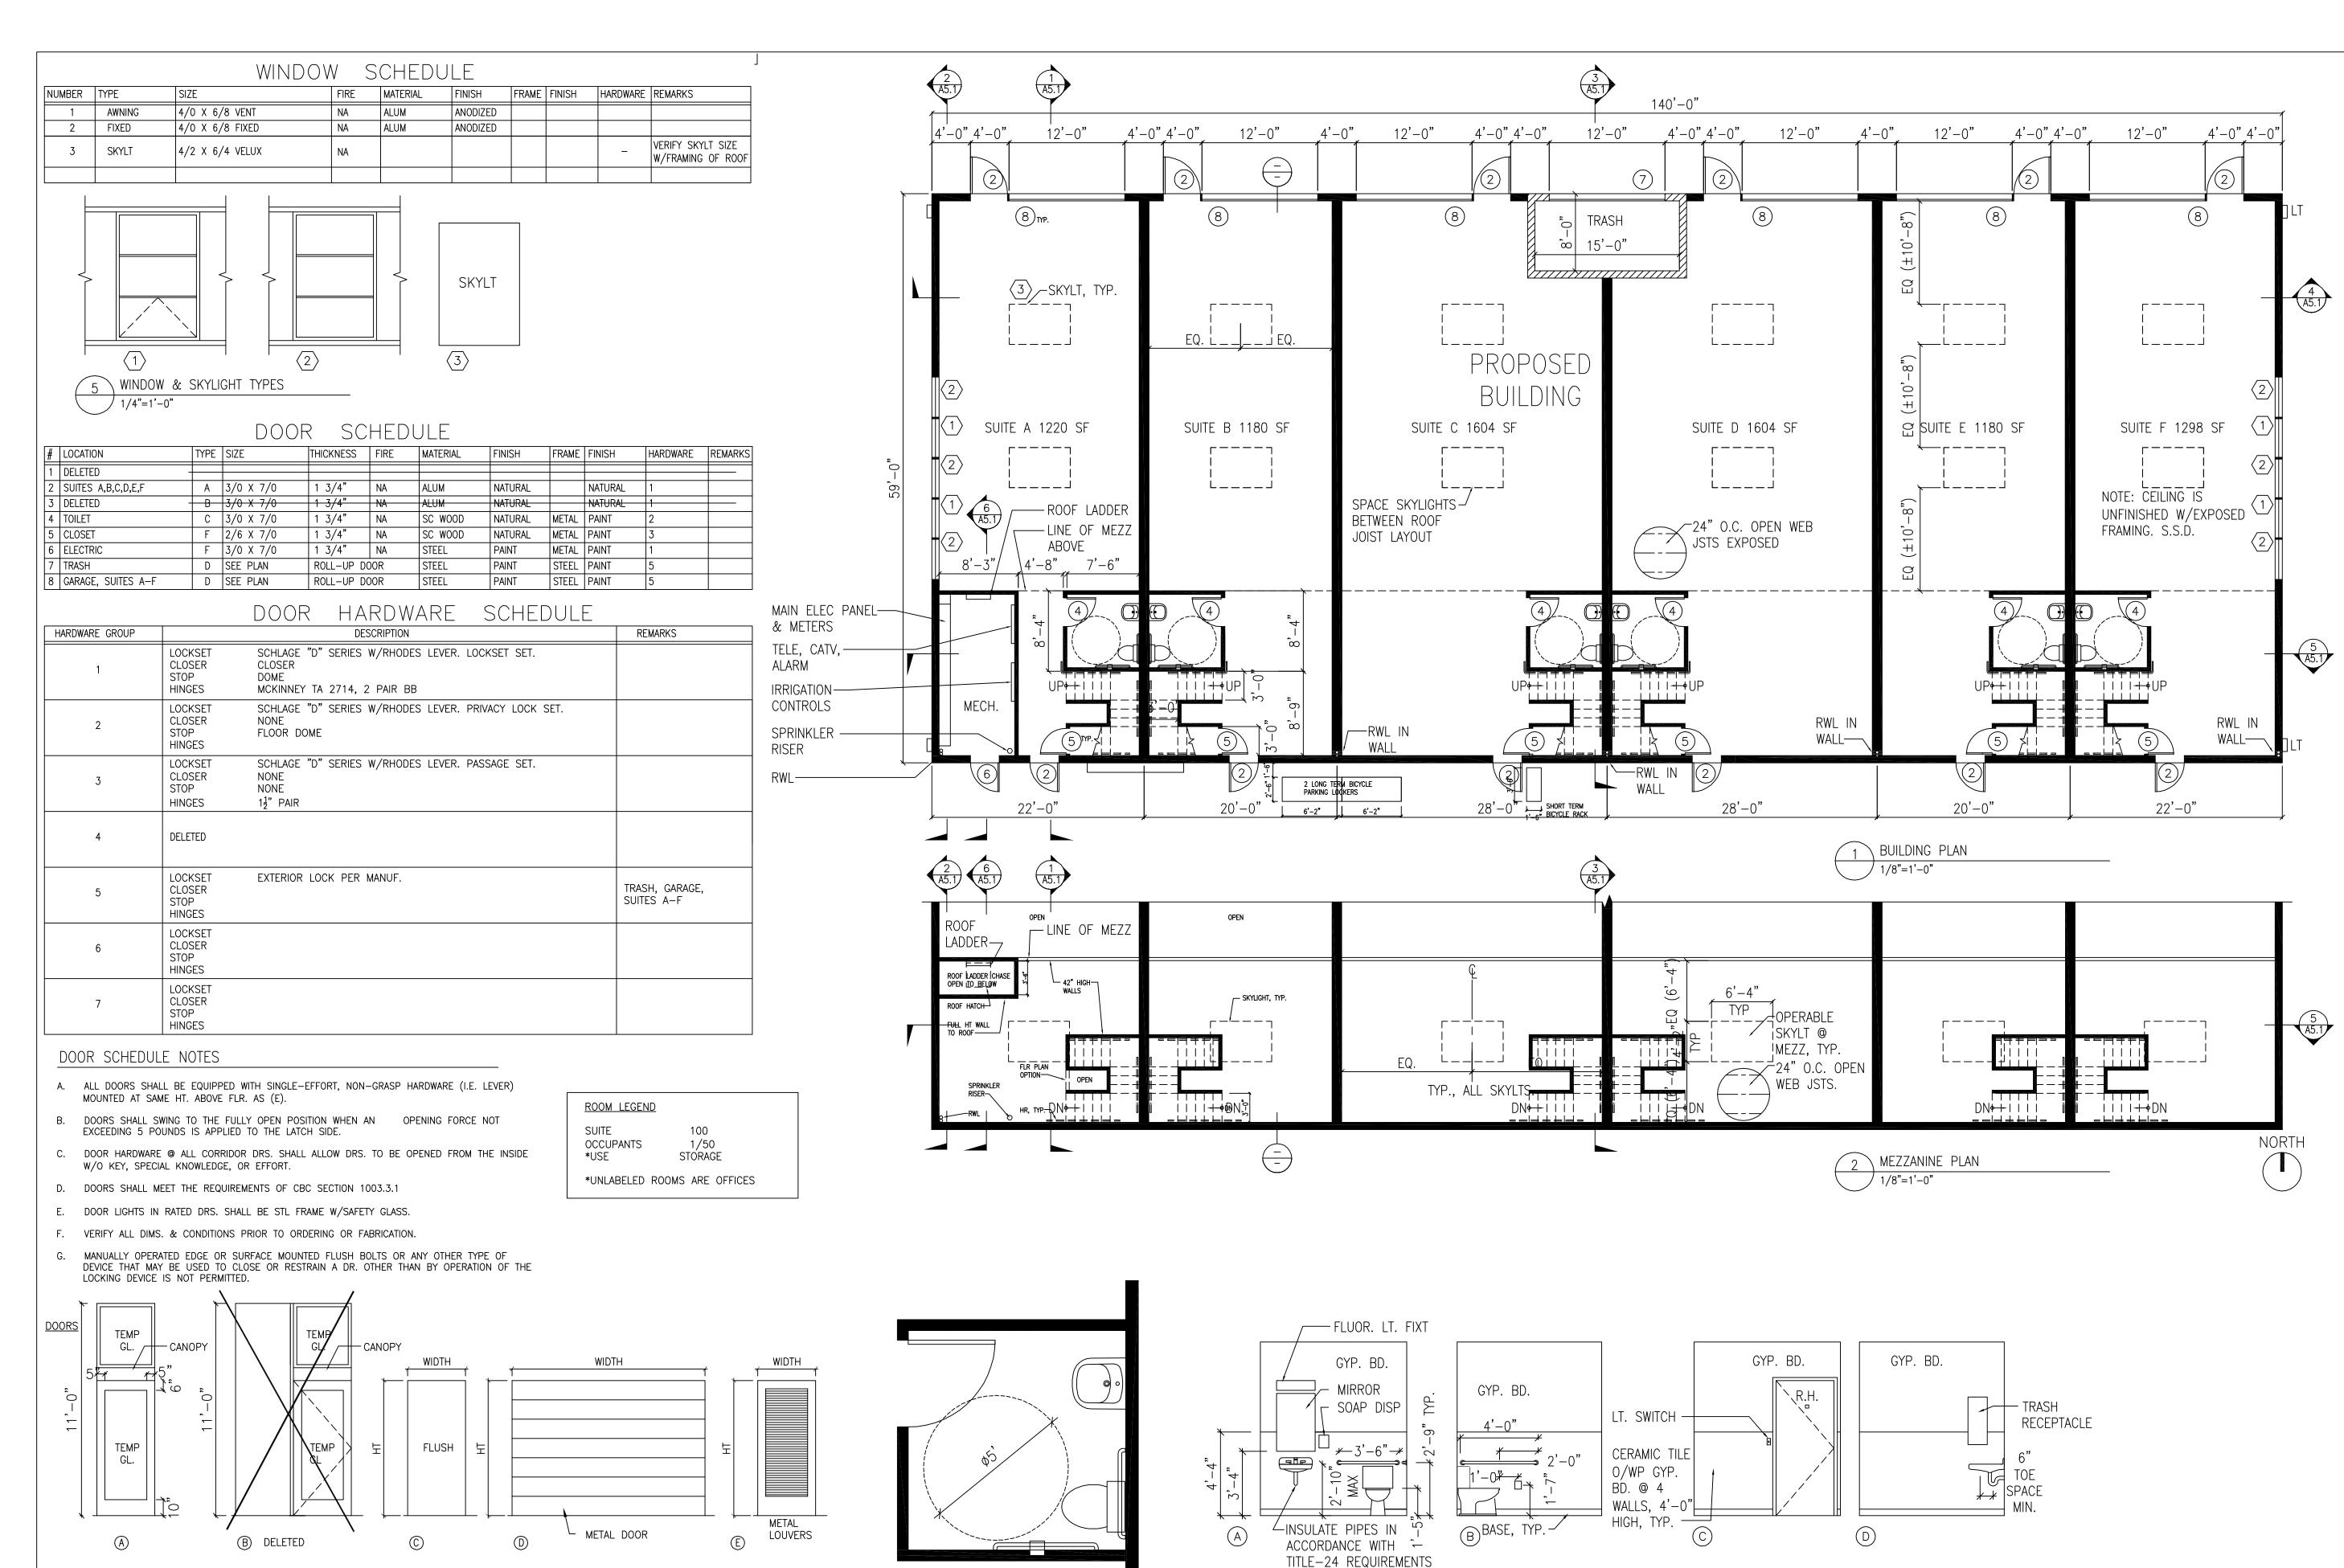
REVISIONS: DESCRIPTION 2019-05-13 DESIGN REVIEW DESIGN REVIEW 2019-09-12 DESIGN REVIEW 2019-10-14

NEW COMMERCIAL STRUCTURE 1920 MINTURN STREET ALAMEDA, CA 94501

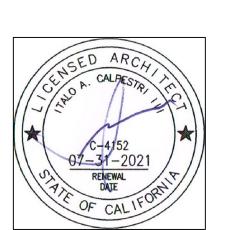DRAWING TITLE

BICYCLE LOCKER & RACK SPECIFICATIONS

201704LP PROJECT No. DRAWN BY: IAC CHECKED BY: DATE: SCALE:



6 ENLARGED RESTROOM PLAN

J 3/8"=1'−0"


4 DOOR TYPES

/ 1/4"=1'-0"

ITALO A. CALPESTRI III

& ASSOCIATE

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OWNER:

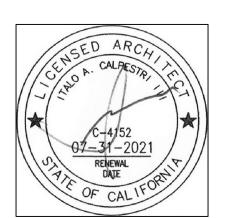REVISIONS:		
No.	DESCRIPTION	DATE
1	DESIGN REVIEW	2019-05-
2	DESIGN REVIEW	2019-09-1
$\overline{\Lambda}$	DESIGN REVIEW	2019-10-1

PROJECT
NEW COMMERCIAL STRUCTURE
1920 MINTURN STREET
ALAMEDA, CA 94501

DRAWING TITLE
BUILDING PLANS
& SCHEDULES

3 BATHROOM

1 /4"=1'-0"

<u> WALL LEGEND:</u>

(E) WALL TO REMAIN

(N) 2X FRAMING @ 16" OC, 5/8"
TYPE 'X' GYP BD FASTENED 6" OC


AT EDGES & 12" OC FIELD

_____ (E) NON-BEARING WALL TO BE

(N) NON-BEARING CMU WALL

REMOVED

PROJECT No.:	201704LP
DRAWN BY:	DH
CHECKED BY:	IAC
DATE:	
SCALE:	AS NOTED
SHEET NO.:	A-3

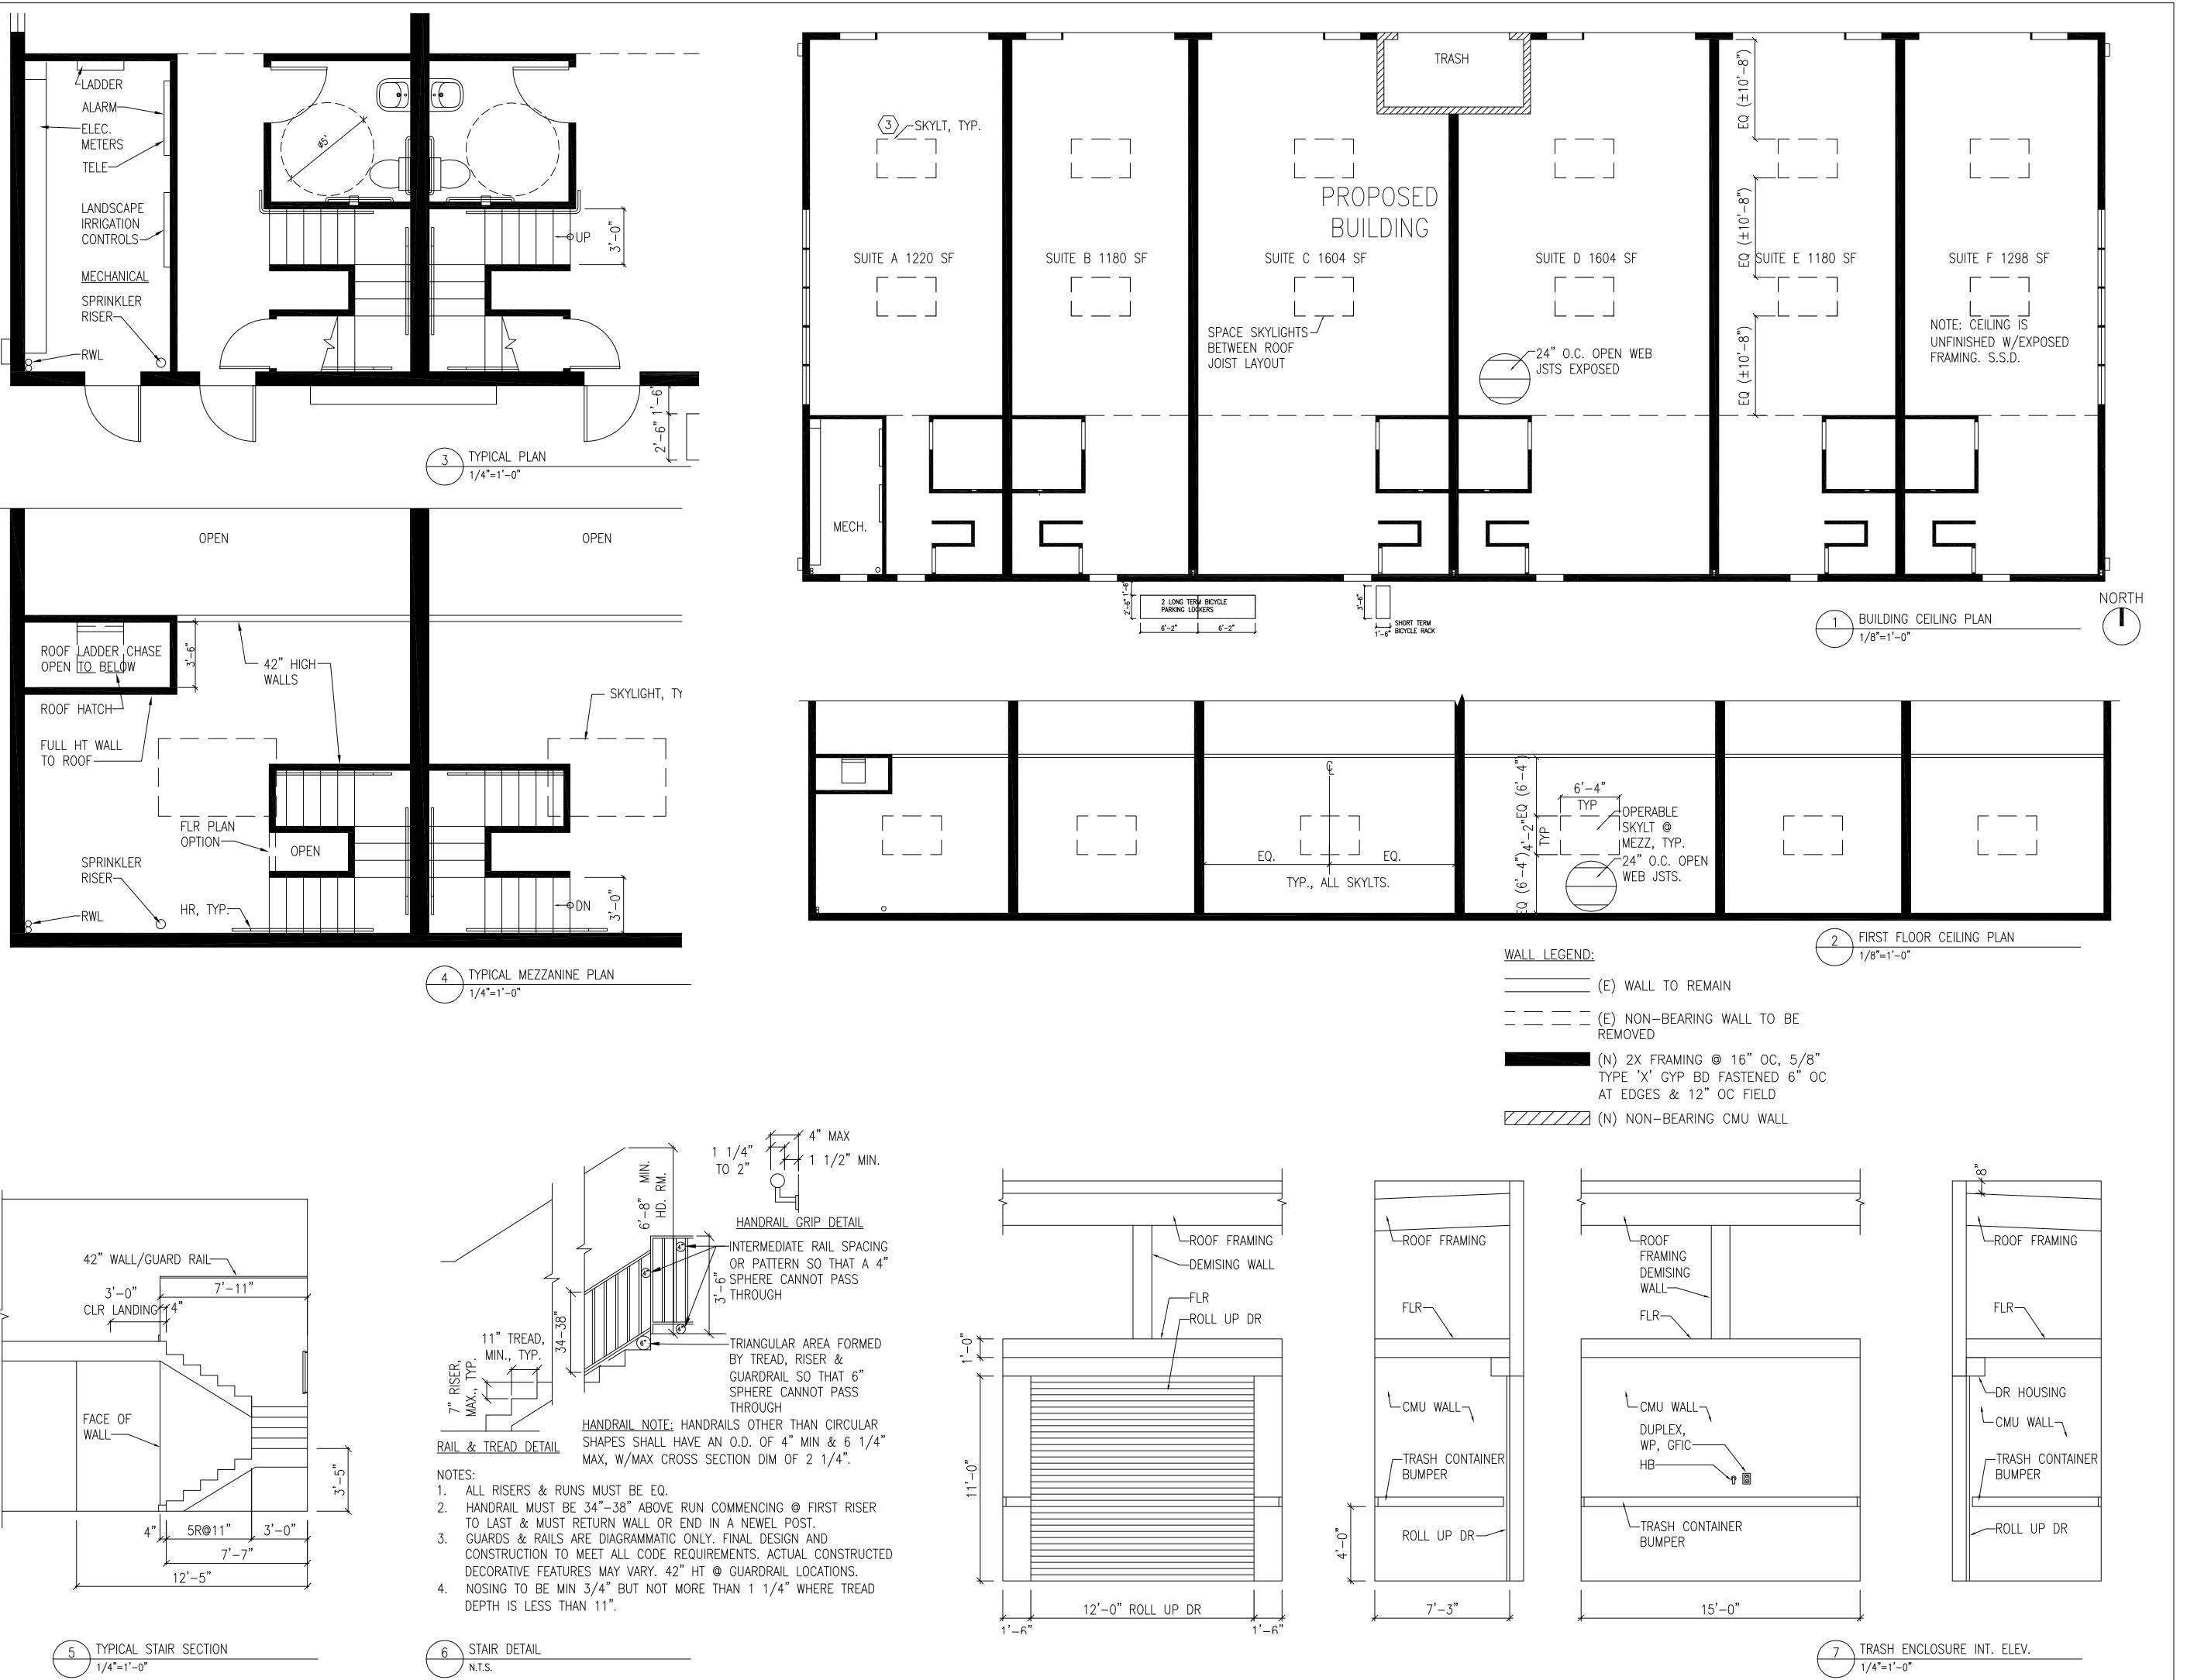

8,-1,

ITALO A. CALPESTRI III

& ASSOCIATES

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OWNER

CTAMD


REVISIONS:		
No.	DESCRIPTION	DATE
1	DESIGN REVIEW	2019-05-
2	DESIGN REVIEW	2019-09-
$\overline{\Lambda}$	DESIGN REVIEW	2019-10-

PROJECT
NEW COMMERCIAL STRUCTURE
1920 MINTURN STREET
ALAMEDA, CA 94501

REFLECTED CEILING PLANS, SECTIONS & DETAILS

PROJECT No. :	201704LP
DRAWN BY:	DH
CHECKED BY:	IAC
DATE:	
SCALE:	AS NOTED

SHEET NO.:

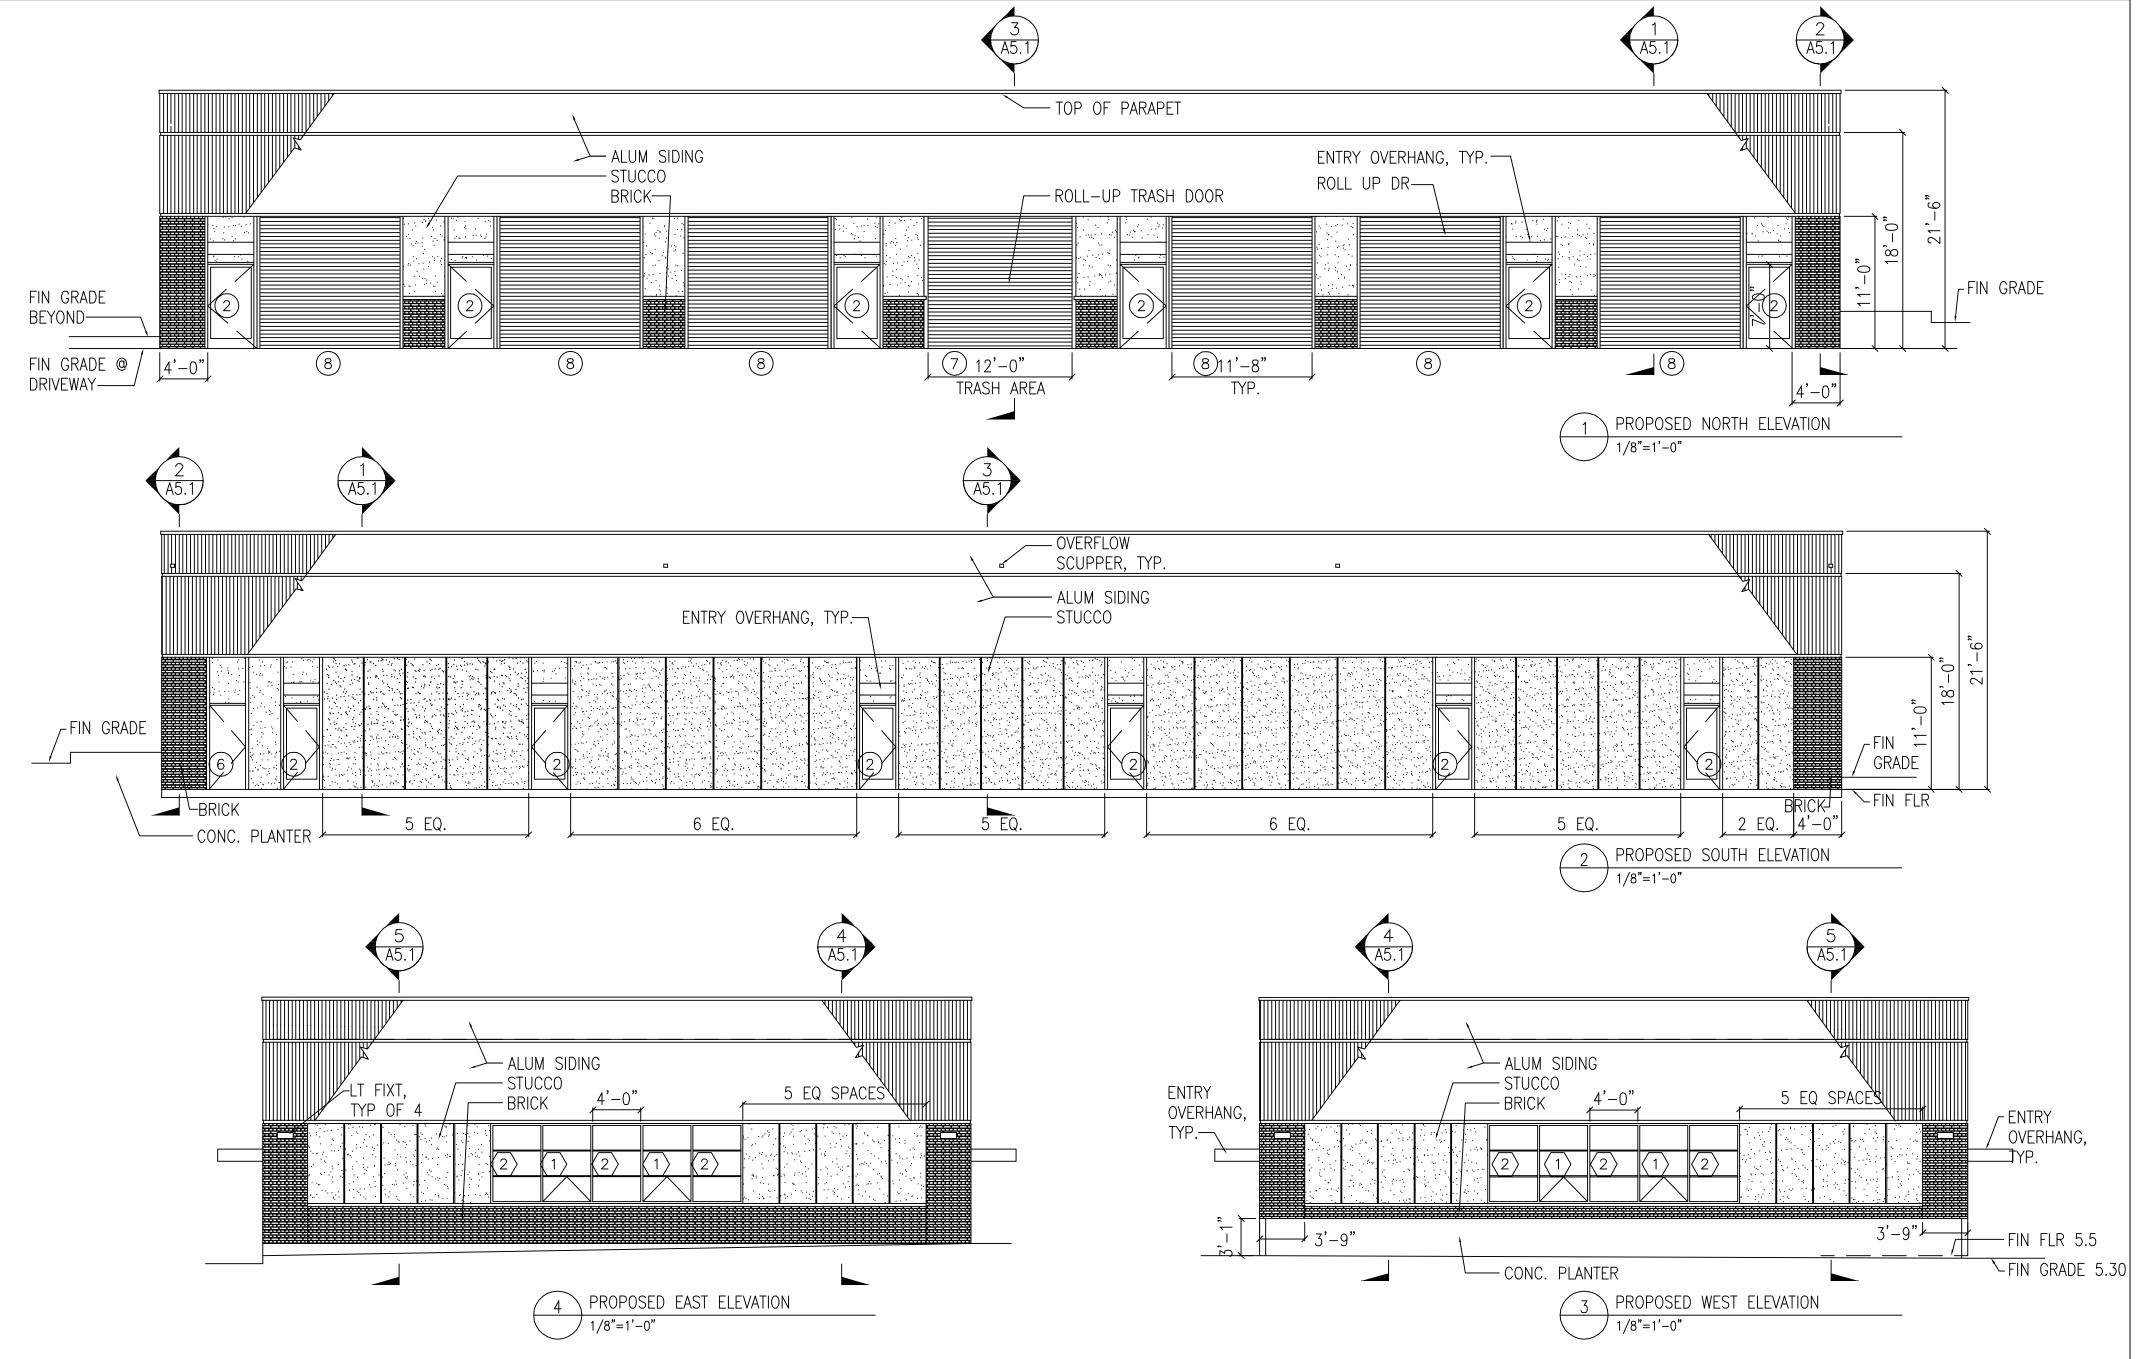


EXTERIOR FINISH

STUCCO: MATCH COLOR & TEXTURE AT 1925 UNION
BRICK: MCNEAR XXX, SAMPLE SUBMITTED
ALUMINUM SIDING: MATCH 1925 UNION
WINDOWS: ALUMINUM FRAME, COLOR TO MATCH 1925 UNION
DOORS: COLOR TO MATCH WINDOWS
CANOPY: PAINT COLOR TO MATCH 1925 UNION

ITALO A. CALPESTRI III

& ASSOCIATE

220 COLUMBIA AVENUE KENSINGTON, CA 94708 MOBILE: (510) 851-2387 FAX: (510) 525-3140

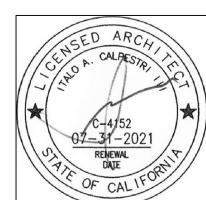

OWNER

STAMP

REVISIONS: No.	DESCRIPTION	DATE
1	DESIGN REVIEW	2019-05-13
2	DESIGN REVIEW	2019-09-12
$\overline{\Lambda}$	DESIGN REVIEW	2019-10-14

PROJECT

NEW COMMERCIAL STRUCTURE


1920 MINTURN STREET

ALAMEDA, CA 94501

DRAWING TITLE PROPOSED ELEVATIONS

SHEET NO .:

PROJECT No. :	201704LP	
DRAWN BY:	DH	
CHECKED BY:	IAC	
DATE:		
SCALE:	AS NOTED	
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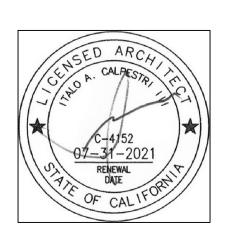


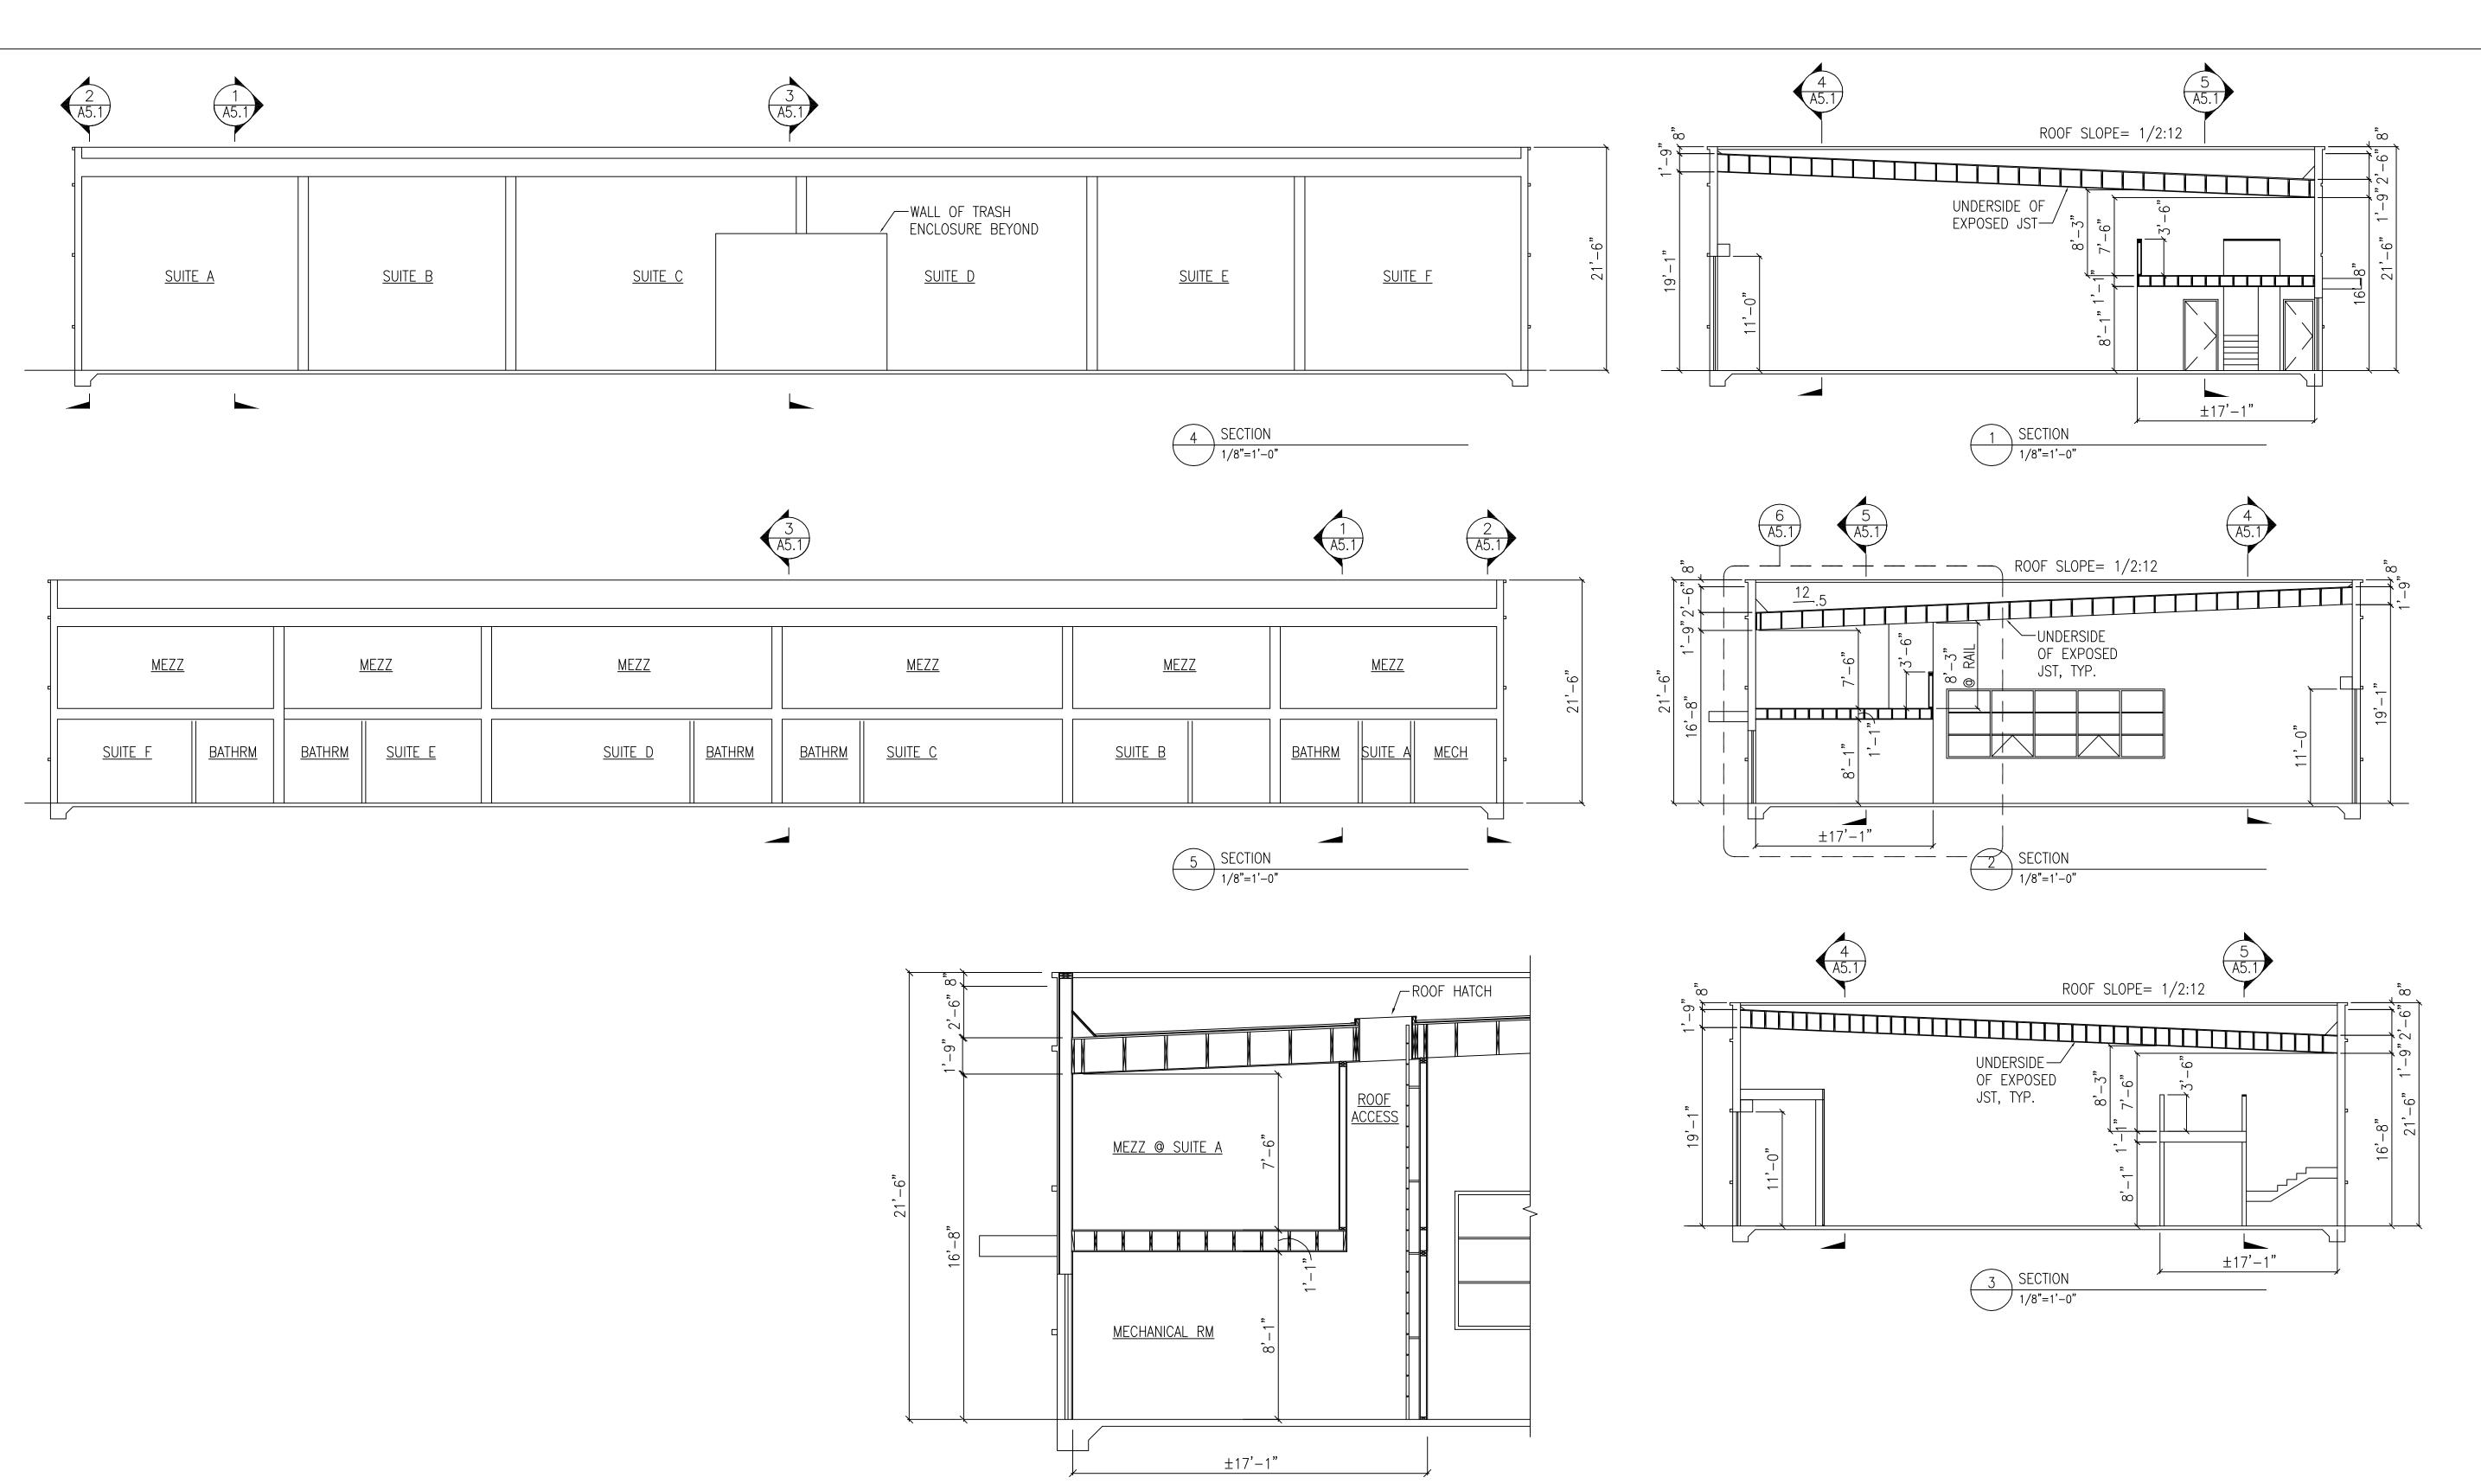6 SECTION DETAIL
1/4"=1'-0"

ITALO A. CALPESTRI III

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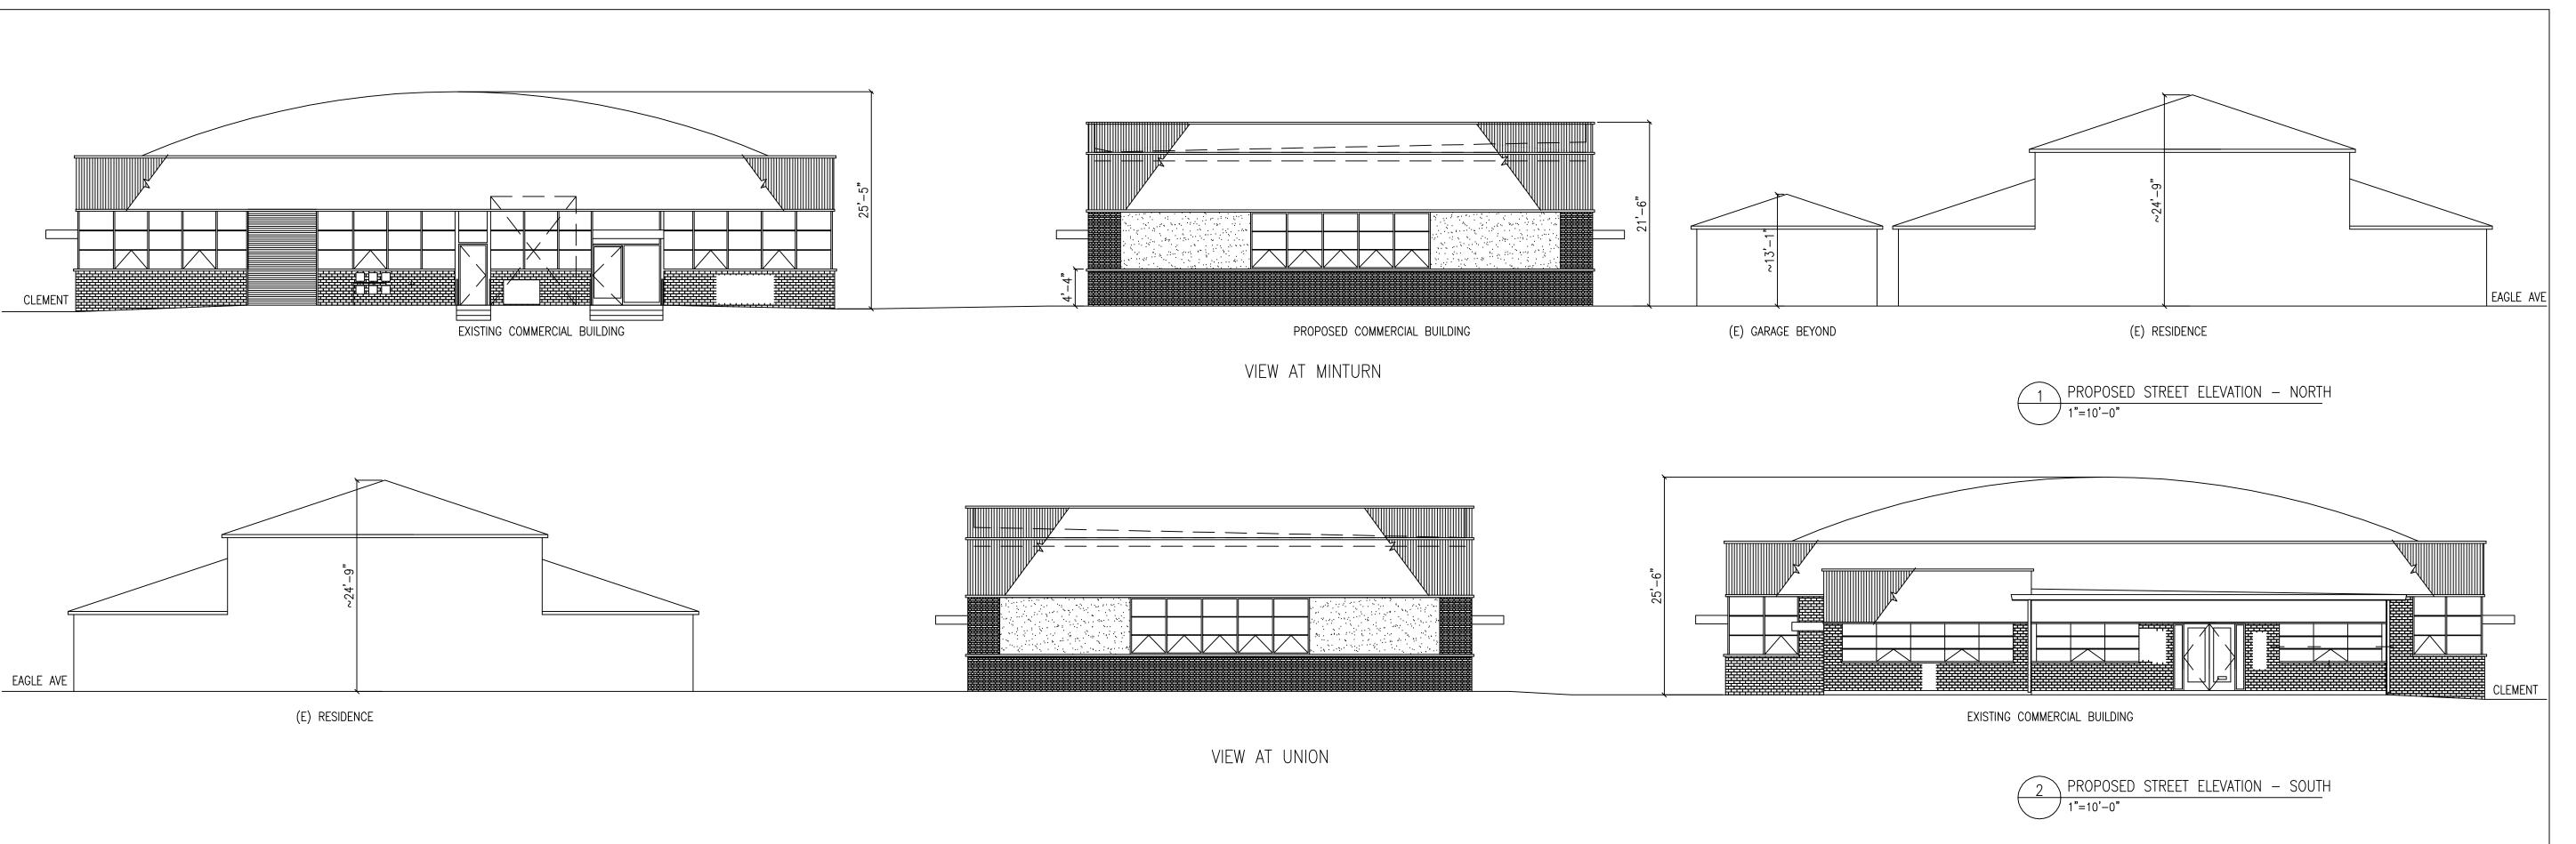
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REVISIONS: No.	DESCRIPTION	DATE
1	DESIGN REVIEW	2019-05-13
2	DESIGN REVIEW	2019-09-12
$\overline{\mathbb{A}}$	DESIGN REVIEW	2019-10-14

PROJECT
NEW COMMERCIAL STRUCTURE
1920 MINTURN STREET
ALAMEDA, CA 94501

drawing title SECTIONS

PROJECT No. :		201704LP	
DRAWN BY:		DH	
CHECKED BY:		IAC	
DATE:			
SCALE:		AS NOTED	
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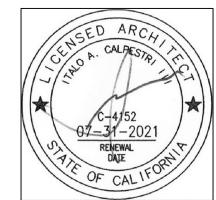


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PROJECT
NEW COMMERCIAL STRUCTURE
1920 MINTURN STREET
ALAMEDA, CA 94501

DRAWING TITLE
STREET
VIEW ELEVATIONS

PROJECT No. :	201704LP
DRAWN BY:	DH
CHECKED BY:	IAC
DATE:	
SCALE:	AS NOTED

SHEET NO.: